

KANE COUNTY DEPARTMENT OF TRANSPORTATION OFFICE RENOVATION

41W011 BURLINGTON ROAD CAMPTON HILLS, IL 60175

100% DESIGN REVIEW

LOCATION MAP:

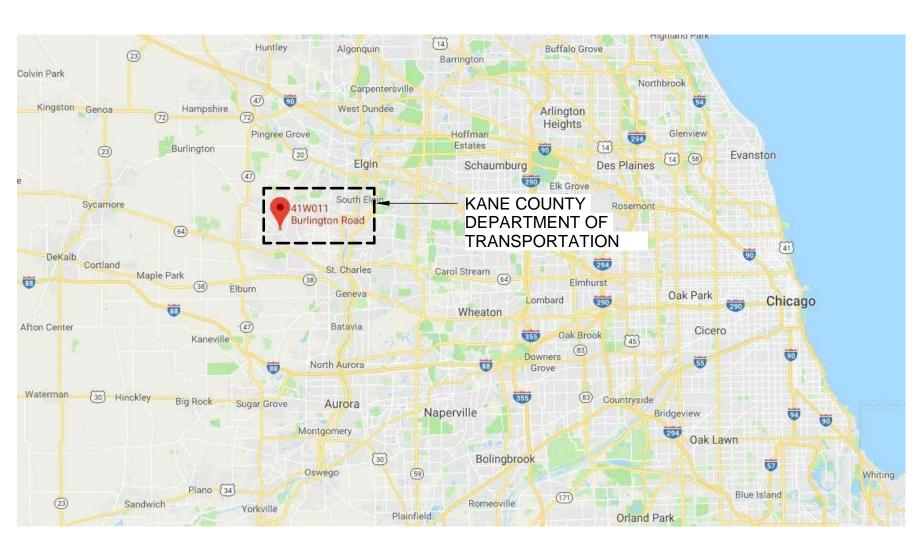

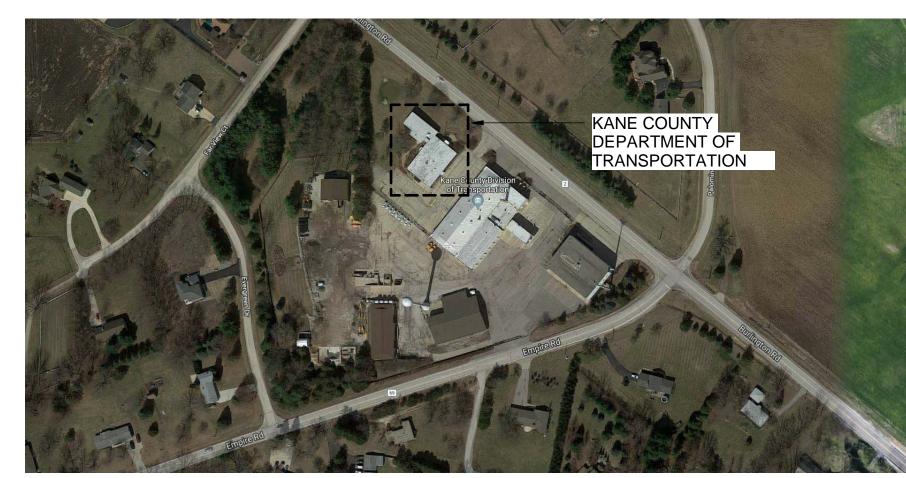

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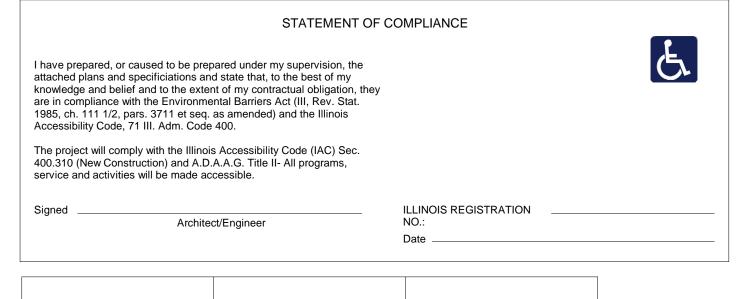
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THIS CERTIFIES THAT THESE DRAWINGS HAVE BEEN

LICENSED ARCHITECT

PREPARED UNDER MY DIRECT SUPERVISION AND TO THE BEST OF MY KNOWLEDGE AND BELIEF ARE IN ACCORDANCE

WITH ALL APPLICABLE BUILDING CODES AND ORDINANCES.



Archited	ct/Engineer	NO.: Date
EXPIRES 11/30/2018		
LICENSED ARCHITECT APPLIES TO SHEETS AD-101 THRU AD-801 A-101 THRU A-902 G-001 THRU G-004	LICENSED MECHANICAL ENGINEER APPLIES TO SHEETS H-001THRU H-201	LICENSED ELECTRICAL ENGINEER APPLIES TO SHEETS E-100 THRU E-401

CERTIFICATIONS & SEALS



No.	Description	Date
1	ISSUED FOR 30% DESIGN	07/23/2018
2	ISSUED FOR 100% DESIGN	09/17/2018

NOT FOR

CONSTRUCTION

Professional Seals

COVER SHEET

DRAWN:	V.WIEGAND	SHEET NO.
CHECKED:	K.KORAB	C 004
DESIGNED:	V.WIEGAND	G-001

JOB NO: 18-1006

G-001

Chicago, IL 60642

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9/27/2018 4:52:20 PM

PROJECT GENERAL NOTES - SCOPE

THIS PROJECT GENERALLY CONSISTS OF A RENOVATION FOR OFFICE SPACE IMPROVEMENTS APPROXIMATELY 1,700 SQUARE FEET. WORK WILL BE LIMITED TO THE MAIN LEVEL OF THE ORIGINAL PORTION OF THE OFFICE BUILDING, THERE IS NO SCOPE IN THE NEWER ADDITION SPACE.

PROJECT GENERAL NOTES - BIDDING

- 1. PRIOR TO SUBMISSION OF BID, GENERAL CONTRACTOR SHALL VISIT THE SITE AND BE KNOWLEDGEABLE OF ALL CONDITIONS THEREON, HE OR SHE SHALL INVESTIGATE, VERIFY, AND BE RESPONSIBLE FOR ALL CONDITIONS OF THE PROJECT AND SHALL NOTIFY THE OWNER OF ANY CONDITIONS REQUIREMENT MODIFICATION OR CLARIFICATION BEFORE PROCEEDING WITH THE WORK. THE CONTRACTOR IS RESPONSIBLE FOR ALL MEANS, METHODS, AND TECHNIQUES TO IMPLEMENT THE DESIGN AS PART OF THEIR BASE BID.
- 2. NOTES APPEAR ON VARIOUS SHEETS FOR DIFFERENT SYSTEMS AND MATERIALS. NOTES ON ANY ONE SHEET ARE TO BE APPLIED TO RELATED DRAWINGS AND DETAILS. WHEN THERE ARE DISCREPANCIES BETWEEN DRAWINGS AND SPECIFICATIONS, CONSULT THE OWNER DURING THE BID PERIOD FOR ANY CLARIFICATIONS NEEDED PRIOR TO SUBMISSION OF BID. IF THE OWNER IS NOT CONSULTED DURING THE BID PERIOD, THE MORE STRINGENT REQUIREMENT SHALL APPLY.
- 3. ASBESTOS WARNING: ASBESTOS-CONTAINING MATERIALS ARE OR MAY BE PRESENT IN THIS BUILDING. NO PERSON MAY DISTURB ASBESTOS CONTAINING BUILDING MATERIALS UNLESS THAT PERSON IS A LICENSED ASBESTOS WORKER AND CONDUCTS SUCH WORK IN ACCORDANCE WITH SECTIONS CONTAINED IN THE PROJECT DOCUMENTS AND IN COMPLIANCE WITH ILLINOIS DEPARTMENT OF PUBLIC HEALTH RULES AND REGULATIONS.
- 4. THE INTERIOR AND EXTERIOR PAINTED SURFACES SHALL BE PRESUMED TO CONTAIN LEAD-BASED PAINT. DISTURBANCES OF THESE PAINTED SURFACES TO COMPLETE THE REQUIRED SCOPE SHALL BE CONDUCTED IN ACCORDANCE WITH USEPA'S FINAL RENOVATION, REPAIR, AND PAINTING (RRP) RULE IN 40 CFR 745. ALL LEAD-SAFE WORK PRACTICES INCLUDE, BUT ARE NOT LIMITED TO ISOLATING THE WORK AREA TO PREVENT DUST MIGRATION, MINIMIZING DUST GENERATION, ENSURING ALL PERSONNEL AND EQUIPMENT ARE FREE OF DUST BEFORE LEAVING THE WORK AREA, CLEANING THE AREA AFTER WORK IS COMPLETED.
- 5. THE SUBMISSION OF A BID OR PROPOSAL WILL BE CONSTRUED AS EVIDENCE THAT THE CONTRACTOR HAS FAMILIARIZED HIMSELF WITH THE PLANS AND EXISTING CONDITIONS OF THE BUILDING SITE. CLAIMS MADE SUBSEQUENT TO THE PROPOSAL FOR MATERIALS AND LABOR BECAUSE OF DIFFICULTIES ENCOUNTERED WILL NOT BE RECOGNIZED IF THEY COULD HAVE BEEN FORESEEN HAD PROPER EXAMINATION OF THE SITE AND/OR DRAWINGS BEEN MADE.

PROJECT GENERAL NOTES - PERMITTING

- 1. THE CONTRACTOR SHALL PERFORM ALL WORK IN ACCORDANCE WITH THE GOVERNING EDITION OF THE INTERNATIONAL BUILDING CODE AND ALL APPLICABLE COUNTY, STATE, AND FEDERAL LAWS, INCLUDING THE OCCUPATIONAL SAFETY AND HEALTH ACT (OSHA) AND REGULATIONS ADOPTED PURSUANT THERETO.
- 2. THE GENERAL CONTRACTOR IS RESPONSIBLE FOR APPLYING, PROCURING, AND PAYING FOR ALL PERMITS AND INSPECTIONS REQUIRED TO COMPLETE THE SCOPE OF WORK UNLESS NOTED OTHERWISE.
- 3. CONTRACTOR IS RESPONSIBLE FOR THE DESIGN AND PERMITTING (INCLUDING PERMIT COSTS) OF ALL SHORING NECESSARY TO IMPLEMENT THE DESIGN.

PROJECT GENERAL NOTES - DEMOLITION

- 1. DEMOLISH ALL ITEMS NOTED AND IN SCOPE OF WORK NOTES. CONTRACTOR IS RESPONSIBLE FOR COMPLETE REMOVAL OF ALL ITEMS ASSOCIATED WITHIN THE DEMOLISHED AREA.
- 2. CONTRACTOR SHALL VISIT THE SITE AND FULLY REVIEW CONDITIONS AND QUANTITIES OF THIS BUILDING AND SITE PRIOR TO BID SUBMISSION TO GAIN FULL KNOWLEDGE OF THE DEMOLITION REQUIREMENTS. HE OR SHE SHALL INVESTIGATE, VERIFY, AND BE RESPONSIBLE FOR ALL CONDITIONS OF THE PROJECT AND SHALL NOTIFY THE OWNER OF ANY CONDITIONS REQUIRING MODIFICATION DURING THE BID PERIOD. ALL DEMOLITION FOR THE PROJECT (INCLUDING REQUIRED PERMITS), EXCEPT SPECIFIC ITEMS NOTED AS N.I.C.
- TO THE BEST OF THE OWNERS KNOWLEDGE THESE DRAWINGS REPRESENT THE EXISTING PLAN CONDITIONS TO BE REMOVED AS ARE DIAGRAMMATICALLY SHOWN. EXACT LOCATIONS, SIZES, EXTENT, AND CONDITIONS OF EXISTING CONSTRUCTION TO BE REMOVED, RELOCATED, OR TO REMAIN SHALL BE VERIFIED AT THE BUILDING SITE BY THE CONTRACTOR. CONTRACTOR TO REPORT DISCREPANCIES IN WRITING DURING THE BID PERIOD.
- 4. THE CONTRACTOR SHALL PERFORM ALL WORK IN ACCORDANCE WITH THE CURRENT BUILDING CODE AND ALL APPLICABLE COUNTY, STATE, AND FEDERAL LAWS, INCLUDING THE OCCUPATIONAL SAFETY AND HEALTH ACT (OSHA) AND REGULATIONS ADOPTED PURSUANT THERETO.
- 5. CONTRACTOR TO PERFORM DEMOLITION SCOPE OF WORK AS REQUIRED TO COMPLETE NEW CONSTRUCTION. COORDINATE ARCHITECTURAL DEMOLITION WITH MECHANICAL, ELECTRICAL, AND FIRE PROTECTION DEMOLITION SCOPE OF WORK.
- 6. ITEMS OF CONSTRUCTION SHOWN AND NOTED TO BE REMOVED SHALL BE THE SAME FOR ALL SIMILAR CONDITIONS AND CONSTRUCTION UNLESS NOTED OTHERWISE.
- 7. SALVAGED ITEMS REQUESTED BY THE OWNER MUST BE CAREFULLY REMOVED, KEPT FREE OF DAMAGE, AND DELIVERED TO THE DESIGNATED STORAGE AREA. MATERIALS AND/OR ITEMS REMOVED AND NOT DESIGNATED TO BECOME THE PROPERTY OF THE OWNER WILL BECOME PROPERTY OF THE CONTRACTOR AND REMOVED FROM SITE.
- 8. ANY EXISTING COMPONENT REMOVED OR DAMAGED TO ALLOW NEW WORK TO OCCUR MUST BE REINSTALLED OR REPLACED AT THE COMPLETION OF NEW WORK UNLESS NOTED OTHERWISE. THE CONTRACTOR SHALL INCLUDE THE SATISFACTORY PATCHING AND FINISH OF ALL SCARS RELATED TO THE DEMOLITION OPERATION.
- 9. ALL ITEMS OF DEMOLITION NOT INDICATED TO BE SAVED SHALL BE REMOVED IN THEIR ENTIRETY INCLUDING ALL ASSOCIATED MACHINERY, FRAMING, ANCHORS, HOUSING, ETC. AND BE DISPOSED OF ON A DAILY BASIS TO AVOID ACCUMULATION OF ANY DEBRIS ON THE SITE
- REMOVE ALL EXISTING MECHANICAL, PLUMBING, AND ELECTRICAL SYSTEMS NOT UTILIZED IN THE NEW CONSTRUCTION.
- 11. PATCH ALL PENETRATIONS RESULTING FROM THE REMOVAL OF UTILITIES. MAINTAIN REQUIRED FIRE RATING WHERE WALLS ARE PATCHED. FINISH TO MATCH ADJACENT
- 12. DO NOT CUT INTO, REMOVE, OR ALTER ANY EXISTING STRUCTURAL MEMBER OR PORTION OF THE FLOOR SYSTEM UNLESS NOTED OTHERWISE.
- 13. SUBMIT WRITTEN REQUEST TO OWNER IN ADVANCE OF CUTTING OR ALTERING ELEMENTS WHICH AFFECT;
 - A. STRUCTURAL INTEGRITY OF ELEMENT.B. INTEGRITY OF WEATHER-EXPOSED OR MOISTURE-RESISTANT ELEMENTS
- 16. THE GC SHALL SAW CUT ALL MASONRY WALLS, CONCRETE FLOORS, AND CONCRETE WALLS IN A CLEAN AND STRAIGHT MANNER, AT THE LIMITS OF THE DESIGNATED REMOVAL.
- 17. REFER TO MECHANICAL DRAWINGS FOR THE REMOVAL AND/OR REUSE OF ALL MECHANICAL DIFFUSERS, DUCTWORK, EQUIPMENT, ETC.
- 18. REFER TO ELECTRICAL DRAWINGS FOR THE REMOVAL AND/OR REUSE OF ALL ELECTRICAL COMPONENTS.
- 19. CLEAN ALL EXCESS CONCRETE SPOTS, SOLID DEBRIS, AND PAINT SPOTS FROM THE FLOOR. REMOVE ALL WAX, DIRT, GREASE, PAINTS, AND OLD ADHESIVES.
- 20. CRACKS, HOLES, AND DEPRESSIONS IN THE FLOORING SYSTEM TO BE FILLED USING PATCHING MATERIAL ACCEPTABLE TO FLOORING MANUFACTURER. SWEEP AND VACUUM THE FLOOR AFTER PATCHING AND DEBRIS REMOVAL. DO NOT USE OIL BASED SWEEPING COMPOUNDS. MAKE SURE ALL PERIMETER AREAS ARE CLEAN.
- 21. WHERE EXISTING CONCRETE SLABS ARE REMOVED FOR THE INSTALLATION OF PLUMBING OR ELECTRICAL SYSTEMS, PATCH EXISTING MATERIALS AS REQUIRED TO MEET FIRE RATING REQUIREMENTS.
- 22. REMOVE DEBRIS AND ABANDONED ITEMS FROM THE CONSTRUCTION AREA. CAP ALL REMAINING PIPING AS REQUIRED BY CODE.

PROJECT GENERAL NOTES - CONSTRUCTION

- 1. ALL DIMENSIONS ARE TO FACE OF PARTITIONS, COLUMN CENTERLINE, OR FINISHED FACE OF EXTERIOR WALL UNLESS OTHERWISE NOTED.
- 2. ALL DIMENSIONS SHALL BE VERIFIED IN THE FIELD BEFORE PROCEEDING WITH ANY WORK. THE OWNER SHALL BE NOTIFIED OF ANY DISCREPANCIES OR CORRECTIONS. DIMENSIONS OF NEW WORK ARE BASED ON RECORD DRAWINGS OF EXISTING WORK. ANY DISCREPANCIES IN EXISTING WORK WILL AFFECT NEW WORK DIMENSIONS. CONTRACTOR IS TO VERIFY THE DIMENSIONS.
- 3. PROVIDE ACCESS PANELS AS REQUIRED BY APPLICABLE CODES AND AS REQUIRED FOR MECHANICAL AND ELECTRICAL EQUIPMENT. REVIEW LOCATIONS WITH OWNER AND ARCHITECT, AT A PRE-INSTALLATION CONFERENCE.
- FIRE-STOP ALL PENETRATIONS IN WALLS TO MATCH HOURLY RATING OF THE WALL.
- 5. ALL NON-RATED PARTITION WALLS SHALL BE STOPPED AND/OR CALKED AT TOP, BOTTOM, AND ADJACENT ASSEMBLIES WITH 1-HOUR EQUIVALENT FIRESTOPPING AND SEALANTS. SEAL ALL PENETRATIONS.
- 6. ALL DISSIMILAR METALS SHALL BE EFFECTIVELY ISOLATED.
- THE CONTRACTOR MUST COORDINATE ALL MECHANICAL AND ELECTRICAL FLOOR SLEEVES AND WALL SLEEVES, EMBEDDED CONDUIT, AND MECHANICAL DUCTWORK WITH MECHANICAL, PLUMBING, ELECTRICAL, AND ARCHITECTURAL DRAWINGS WITH CORRESPONDING DISCIPLINES.
- 8. ALL PIPES, CONDUITS, AND DUCTWORK THAT PENETRATE WALLS, FLOOR, OR ROOF SLABS SHALL BE INSTALLED IN A MANNER THAT WILL PRESERVE THE FIRE RESISTIVE INTEGRITY AND WATER TIGHTNESS OF SUCH WALLS OR SLABS AND THE BUILDING.
- 9. ALL EXTERIOR JOINTS AROUND WINDOWS, DOORS, FRAMES, METAL PANELS, BETWEEN WALLS AND ROOF, BETWEEN WALL PANELS, AND AT PENETRATIONS OF UTILITIES THROUGH THE BUILDING ENVELOPE SHALL BE FIRE-SAFE AS REQUIRED, SEALED, CAULKED, OR WEATHER STRIPPED TO PREVENT WATER OR AIR LEAKAGE/PENETRATION.
- 10. TOP OF FLOOR SLAB AT GROUND FLOOR = 0'-0".
- 11. CONTRACTOR SHALL BE RESPONSIBLE FOR PROTECTION OF EXISTING AND NEW WORK. ANY WORK DAMAGED FOR ANY REASON SHALL BE REPLACED AT NO COST TO THE OWNER.
- 12. PRIOR TO STARTING CONSTRUCTION THE GENERAL CONTRACTOR SHALL BE RESPONSIBLE TO VERIFY THAT ALL REQUIRED PERMITS AND APPROVALS HAVE BEEN OBTAINED. NEITHER CONSTRUCTION NOR FABRICATION OF ANY ITEM SHALL BEGIN UNTIL THE CONTRACTOR HAS RECEIVED ALL PLANS AND ANY OTHER APPROVALS FROM GOVERNMENTAL AGENCIES OR OTHER REGULATORY AUTHORITIES HAVING JURISDICTION OVER THE PROJECT. FAILURE OF THE CONTRACTOR TO FOLLOW THIS PROCEDURE SHALL CAUSE THE CONTRACTOR TO ASSUME FULL RESPONSIBILITY FOR ANY SUBSEQUENT MODIFICATION OF THE WORK MANDATED BY REGULATORY AUTHORITY.
- 13. ALL GYPSUM BOARD TO BE 5/8" TYPE "X" UNLESS NOTED OTHERWISE. IN DAMP AREAS, MOISTURE AND MOLD RESISTANT GYPSUM BOARD SHALL BE USED IN LIEU OF REGULAR GYPSUM BOARD. IN WET AREAS CEMENTITIOUS BACKER UNITS SHALL BE USED.
- 14. INSTALL GYPSUM BOARD CONSTRUCTION JOINTS AT MINIMUM 30'-0" O.C.
- 15. CONTRACTOR SHALL INSTALL ROUGH BLOCKING OR WOOD NAILERS DURING THE ROUGH FRAMING STAGE OF CONSTRUCTION AS REQUIRED FOR PROPERLY SECURING WALL CABINETS, SHELVING, LIGHTING, AND ELECTRICAL FIXTURES, WALL MOUNTED EQUIPMENT, MILLWORK, APPLIED DECORATIVE TREATMENTS, AND HANDRAIL BRACKETS. ALL WOOD BLOCKING TO BE FIRE TREATED MATERIAL.
- 16. EXISTING AREAS DAMAGED BY WORK OF THIS PROJECT SHALL BE PATCHED TO MATCH EXISTING ADJACENT SURFACES IN FINISH, COLOR, AND TEXTURE UNLESS OTHERWISE NOTED.
- 17. EXISTING PAINTED SURFACES DAMAGED OR PATCHED AS PART OF THIS PROJECT SHALL BE PAINTED TO MATCH EXISTING ADJACENT FINISH, COLOR, AND TEXTURE. EXISTING PAINT FINISH, COLOR, AND TEXTURE SHALL BE VERIFIED BY CONTRACTOR IN THE FIELD PRIOR TO CONSTRUCTION.
- 18. NEWLY INSTALLED EXPOSED ELECTRICAL ITEMS, INCLUDING BUT NOT LIMITED TO, CONDUIT HANGERS, AND FITTINGS SHALL BE PAINTED TO MATCH EXISTING ADJACENT SURFACES UNLESS DRAWINGS INDICATE A WALL OR CEILING TO REMAIN UNFINISHED (NOT PAINTED).
- 19. ALL EXISTING FLOOR SURFACES DAMAGED OR PATCHED AS PART OF THIS PROJECT SHALL BE PATCHED TO MATCH EXISTING ADJACENT FINISH, COLOR, AND TEXTURE. EXISTING FLOOR FINISH SHALL BE VERIFIED AND DOCUMENTED BY CONTRACTOR IN THE FIELD PRIOR TO CONSTRUCTION.
- 20. ALL NEW CMU AND EXPOSED CONCRETE WALLS TO BE CLEANED AND PAINTED UNLESS NOTED OTHERWISE.
- 21. CONTRACTOR TO REMOVE ANY GRAFFITI WITHIN 24 HOURS DURING CONSTRUCTION.



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SOUNTY DEPARTME Insportation (KD Fice Renovation

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AA OF

Professional Seals

NOT FOR CONSTRUCTION

No.	Description	Date
1	ISSUED FOR 30% DESIGN	07/23/2018
2	ISSUED FOR 100% DESIGN	09/17/2018
<u> </u>		

ARCHITECTURAL NOTES

DRAWN: V.WIEGAND SHEET NO.
CHECKED: K.KORAB

CHECKED: K.KORAB

DESIGNED: V.WIEGAND

JOB NO: 18-1006

FOOTING

F FTG

PROJECT ABBREVIATIONS

٨	AC	AIR CONDITIONING				D	PLSTR	PLASTER
	ACT	ACOUSTIC CEILING TILE	G	GA	GAUGE		PLUMB	PLUMBING
	ADA	AMERICANS WITH DISABILITIES ACT		GALV	GALVANIZED	' P	PNL	PANEL
	ADJ	ADJACENT		GALV	GYPSUM BOARD	г Р	POU	POINT OF USE
	AFF	ABOVE FINISHED FLOOR		GC	GENERAL CONTRACTOR	P	PR	PAIR
	ALUM	ALUMINUM		GCMU	GLAZED CONCRETE MASONRY UNIT	P	PRC	PRECAST
				GFCI	GROUND FAULT CIRCUIT INTERRUPTER		PREFAB	PREFABRICATE(D)
	ARCH	ARCHITECTURAL		GFCMU	GROUND FACE CONCRETE MASONRY UNIT			PAINT(ED)
^	AINOLL	AKOHITEOTOKAL		GFRC	GLASS FIBER REINFORCED CONCRETE		PTN	PARTITION
В	D/	BOTTOM OF		GFRG	GLASS FIBER REINFORCED GYPSUM		PVC	POLYVINYL CHLORIDE
	BIT	BITUMINOUS		GL	GLASS FIBER REINI ORCED GTF SOM GLASS		PWD	PLYWOOD
	BLDG	BUILDING	G	GL	GLAGG	Г	L AAD	FEIWOOD
	BRK	BRICK	Ц	НВ	HOSE BIB	0	QT	QUARRY TILE
	BTW	BETWEEN		HC	HOLLOW CORE	Q	QΊ	QUAINT TILL
Ь	DIVV	BLIWLIN		HDW	HARDWARE	D	RB	RESILIENT BASE
_	CAB	CABINET		HM	HOLLOW METAL		RCP	REFLECTED CEILING PLAN
	САВ	CEMENT BOARD		HORIZ	HORIZONTAL(LY)		RD	ROOF DRAIN
	CCD	CHICAGO CITY DATUM		HP	HIGH POINT		REF	REFERENCE
	CFMF	COLD FORMED METAL FRAMING						
				HR(S)	HOUR(S)		REINF	REINFORCED(D)(ING) REQUIRED
С		CONTINUOUS INSULATION		HT	HEIGHT		REQD	
	CIP	CAST IN PLACE	П	HVAC	HEATING, VENTILATING, AND AIR CONDITIONING		RH	RIGHT HAND
	CJ	CONTROL JOINT	н	HW	HOT WATER		RM	ROOM
	CLNG	CENTERLINE		HWD	HARDWOOD	R	RO ROW	ROUGH OPENING
	CLNG	CLOSET		HWH	HOT WATER HEATER	R		RIGHT-OF-WAY
	CLO	CLOSET CLEAR(ANCE)	П	: : V V I I	NOT WATER HEATER		RSR	RISER
	CLR	CLEAR(ANCE)	1	ID	INSIDE DIAMETER	К	RTN	RETURN
	CMU	CONCRETE MASONRY UNIT	I I			_	CAN	CANITADY
	CO	CLEAN OUT	I 1	IN INCL	INCH(ES) INCLUDE(D)(ING)		SAN	SANITARY
	COL	COLUMN	1				SC	SEALED CONCRETE
	COMM	COMMUNICATION(S)	1	INFO	INFORMATION		SCFT	STRUCTURAL CLAY FACING TILE
	CONC	CONCRETE	1	INSUL	INSULATION		SCHED	SCHEDULE
	CONST	CONSTRUCTION	I	INT	INTERIOR, INTERNAL		SCWD	SOLID CORE WOOD DOOR
	CONT	CONTINUOUS	ı	IANI	IANITOD	S	SF	SQUARE FEET(FOOT)
	CORR	CORRIDOR		JAN	JANITOR		SFCMU	SPLIT FACE CONCRETE MASONRY UNIT
	CPT	CARPET		JST	JOIST		SHT	SHEET
	CRS	COURSE(S)	J	JT	JOINT		SHWR	SHOWER
	CS	CAST STONE					SIM	SIMILAR
	CT	CEREMIC TILE		LAM	LAMINATE(D)		SPEC(S)	SPECIFICATION(S)
	CW	COLD WATER		LAV	LAVATORY	S	SQ	SQUARE
С	STC	SOUND TRANSMISSION CLASS		LBP	LEAD-BASED PAINT	S	ST STL	STAINLESS STEEL
				LBS	POUND(S)	S	STL	STEEL
D	DBL	DOUBLE		LF	LINEAR FEET	S	STN	STONE
D	DEMO	DEMOLISH, DEMOLITION	L	LH	LEFT HAND	S	STRUC	STRUCTURE/STRUCTURAL
D	DF	DRINKING FOUNTAIN	L	LLH	LONG LEG HORIZONTAL	S	SUSP	SUSPENDED
D	DIA	DIAMETER	L	LLV	LONG LEG VERTICAL			
D	DIM	DIMENSION	L	LP	LOW POINT	Т	T&G	TONGUE AND GROOVE
D	DN	DOWN	L	LVL	LEVEL	Т	T/	TOP OF
D	DS	DOWNSPOUT				Т	TD	TRENCH DRAIN
D	DWG(S)	DRAWING(S)	M	MATL	MATERIAL(S)	Т	TEL	TELEPHONE
			M	MAX	MAXIMUM	Т	TEMP	TEMPORARY
Ε	EA	EACH	M	MECH	MECHANICAL	Т	THK	THICK(NESS)
Е	EJ	EXPANSION JOINT	M	MEP	MECHANICAL, ELECTRICAL & PLUMBING	Т	TRD	TREAD
Ε	ELEC	ELECTRICAL	M	MEZZ	MEZZANINE	Т	TYP	TYPICAL
Е	ELEV	ELEVATION	M	MFR	MANUFACTURER(R)(D)	Т	TZ	TERRAZZO
Ε	ELVR	ELEVATOR	M	MH	MANHOLE			
Е	ENCL	ENCLOSURE	M	MIN	MINIMUM	U	UL	UNDERWRITER'S LABORATORIES
	ENT	ENTRANCE	М	MISC	MISCELLANEOUS		UNF	UNFINISHED
	EOS	EDGE OF SLAB	М	MNT	MOUNT(ING)		UNO	UNLESS NOTED OTHERWISE
	EP	EPOXY PAINT	М	MO	MASONRY OPENING		UNX	UNEXCAVATED
	EQ	EQUAL	М	MOPD	MAYOR'S OFFICE FOR PEOPLE WITH		URN	URINAL
	EQUIP	EQUIPMENT			DISABILITIES	-		
	ESCR	ESCALATOR		MTD	MOUNTED	V	VB	VINYL BASE
	EWC	ELECTRIC WATER COOLER		MTL	METAL		VCT	VINYL COMPOSITION TILE
	EWH	ELECTRIC WATER HEATER	М	MWK	MILLWORK		VERT	VERTICAL(LY)
	EXH	EXHAUST					VIF	VERIFY IN FIELD
	EXIST	EXISTING	N	NIC	NOT IN CONTRACT		VTR	VENT THROUGH ROOF
	EXP	EXPOSED	N	NO	NUMBER	•	- • •	
	EXT	EXTERIOR	N	NOM	NOMINAL	W	W/	WITH
_	• •		N	NTS	NOT TO SCALE		WAP	WIRELESS ACCESS POINT
F	F/	FACE OF					WC	WATER CLOSET
	FAAP	FIRE ALARM ANNUNCIATOR PANEL	0	OC	ON CENTER		WD	WOOD
	FACP	FIRE ALARM CONTROL PANEL	0	OCC	OCCUPANCY		WGT	WEIGHT
	FD	FLOOR DRAIN	0	OD	OUTSIDE DIAMETER		WH	WALL HUNG
	FDN	FOUNDATION	0	OHD	OVERHEAD DOOR		WM	WIRE MESH
	FE	FIRE EXTINGUISHER		OPH	OPPOSITE HAND		WP	WORKING POINT
	FEC	FIRE EXTINGUISHER CABINET		OPNG	OPENING		WR	WATER RESISTANT
	FF	FINISHED FLOOR		OPP	OPPOSITE		WRB	WEATHER RESISTIVE BARRIER
	FIN						WWF	WELDED WIRE FABRIC
		FINISH(ED)	Р	PCT	PORCELAIN CERAMIC TILE	VV	v v v v Г	WELDED WINE FADRIC
	FLR	FLOOR		PHEN	PHENOLIC			
	FP	FIRE PROTECTION		PJF	PREMOLDED JOINT FILLER			
F	FT	FEET, FOOT		PI	PI ATF			

PLATE

P PLAM PLASTIC LAMINATE

PRO	JECT PATTERNS
DIVISION 0	03 - CONCRETE
4 . 4	CONCRETE
	PRECAST CONCRETE
DIVISION 0	04 - MASONRY
	BRICK
	STONE
	CONCRETE MASONRY UNIT (CMU)
	MORTAR NET
	STRUCTURAL GLAZED FACING TILE (SGFT)
DIVISION 0	05 - METALS
	ALUMINUM
	STEEL
DIVISION 0	06 - WOODS, PLASTICS AND COMPOSITES
	BLOCKING / SHIM
	DIMENSIONAL LUMBER
	FINISH WOOD
m	

PLYWOOD

DIVISION 07 - THERMAL AND MOISTURE PROTECTION

FIREPROOFING **INSULATION - BATT INSULATION - RIGID DIVISION 08 - OPENINGS**

GLAZING (LARGE SCALE)

DIVISION 09 - FINISHES ACOUSTICAL CEILING TILE (ACT)

CERAMIC TILE (WALL OR FLOOR) GYPSUM WALL BOARD (GWB)

RESILIENT TILE

SOLID SURFACE MATERIAL (SSM)

DIVISION 31 - EARTHWORK


EARTH GRAVEL

DIVISION 32 - SITE IMPROVEMENTS

TERRAZZO

TACTILE WARNING

GENERAL SYMBOL LEGEND

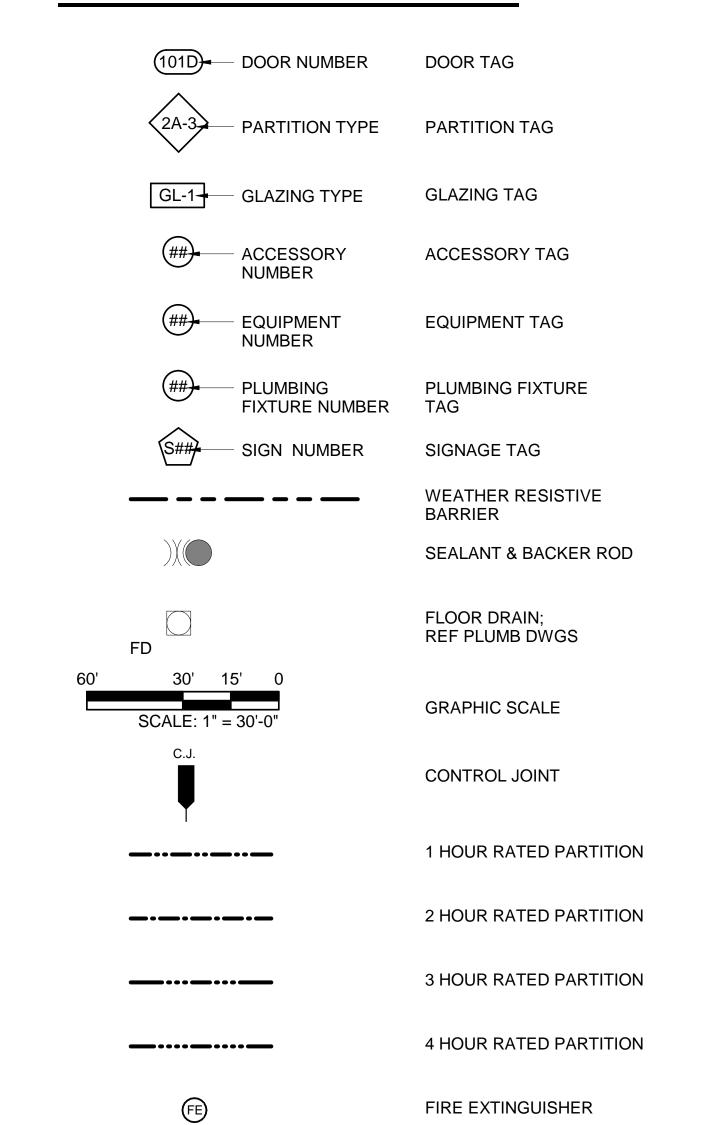



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KANE COUNTY DEPARTMENT
OF TRANSPORTATION
OFFICE RENOVATION

Professional Seals

5' WHEELCHAIR TURNAROUND

NOT FOR CONSTRUCTION

No.	Description	Date
1	ISSUED FOR 30% DESIGN	07/23/2018
2	ISSUED FOR 100% DESIGN	09/17/2018
		1
		1
		
		+
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ARCHITECTURAL SYMBOLS & **ABBREVIATIONS**

DRAWN: V.WIEGAND SHEET NO.

CHECKED: K.KORAB G-003 DESIGNED: V.WIEGAND JOB NO: 18-1006

BUILDING DATA:

DNSTRUCTION TYPE

AX HEIGHT ALLOWER

CCUPANCY CLASSIFICATION

RE SEPARATION DISTANCE

INCREASE FOR SPRINKLER

OTHER MODIFICATIONS

TOTAL HEIGHT ALLOWED

MAX STORIES ALLOWED (ABOVE GRADE)

OTHER MODIFICATIONS

INCREASE FOR SPRINKLER

THER MODIFICATIONS

TOTAL AREA ALLOWED PER FLOOR

TRUCTURAL FRAME (COLS, GIRDERS, TRUSSES)

SUPPORTING FLOOR(S) & ROOF

SUPPORTING ROOF ONLY

ONBEARING WALLS & PARTITIONS

TOTAL STORIES

AX AREA ALLOWED (PER STORY)

FRONTAGE INCREASE

FIRE RESISTANCE RATINGS:

EARING WALLS

EXTERIOR

INCREASE FOR SPRINKLER

ALLOWABLE OR REQUIRED

LOWABLE OR

HOURS

2 HOURS

PROVIDED

FIGHT ABOVE GRADE: +/-11 FT

JMBER OF STORIES: 1 STORIES

REA PER FLOOR: 9,158 SF

PROVIDED

EXISTING

FXISTING

IBC 2012

CHAPTER 3

SECTION 504.2

TABLE 503

TABLE 503

TABLE 503

IBC 2012

TABLE 601

TABLE 601

TABLE 601, 602

SECTION 506.3

CTION 506.2

SECTION 504.2

GENERAL NOTES - LIFE SAFETY

- INTERIOR WALL AND CEILING FINISHES SHALL BE CLASS A WITH A FLAME SPREAD RATING 0-25. AND SMOKE DEVELOPED MAX RATING OF 450 PER IBC 803.1.1. ALL EXIT DOORS TO SWING IN THE DIRECTION OF TRAVEL EXCEPT FROM ROOMS
- HAVING A CAPACITY NOT EXCEEDING 50 PERSONS, PER IBC 1008.1.2. ALL EXIT DOORS MUST BE READILY OPENED WITHOUT A KEY FROM THE SIDE
- EGRESS IS MADE, PER IBC 1008.1.9. SEE SHEET A-201 FOR PARTITION TYPES.
- ALL GLASS IN DOORS TO BE TEMPERED SAFETY GLASS AND SAFETY RATED GLASS
- ALL FIRE RATINGS INDICATED FOR WALLS, CEILINGS, AND ROOF ARE TO COMPLY WITH UNDERWRITER'S LABORATORIES TEST RATINGS OR AS REGULATED BY THE INTERNATIONAL BUILDING CODE AND NFPA 130 (2014).
- ALL GYPSUM BOARD TO BE TYPE 'X' UNLESS NOTED OTHERWISE. ALL RATED DOORS TO HAVE A FIRE DOOR CERTIFICATION LABEL READILY VISIBLE
- BY THE AUTHORITY HAVING JURISDICTION, MUST BE SELF-CLOSING AND MUST HAVE A POSITIVE LATCH, AND MUST BE INSTALLED IN ACCORDANCE WITH NFPA-80.
- MECHANICAL, ELECTRICAL, AND STORAGE AREAS REQUIRE TO HAVE 1HR SPRAY APPLIED FIRE PROTECTION AT ROOF AND STRUCTURE SUPPORTING ROOF. IF ABOVE 20'-0" AFF, NOT REQUIRED.
- ALL PENETRATIONS IN NONFIRE-RESISTANCE-RATED FLOOR ASSEMBLIES SHALL BE PROTECTED WITH AN APPROVED NONCOMBUSTIBLE MATERIAL THAT RESISTS THE FREE PASSAGE OF FLAME AND THE PRODUCTS OF COMBUSTION PER IBC

PLUMBING FIXTURE COUNTS - NO CHANGE TO EXISTING PLUMBING FIXTURE REQ'D ACCORDING TO ILLINOIS PLUMBING CODE SECTION 890 APPENDIX A, TABLE B: OFFICE BUILDINGS WATER CLOSETS REQUIRED MEN 35 - 55 = 3WOMEN 35 - 55 = 3 PROVIDED = 9 MENS ROOM **5 WOMENS ROOM 1 UNISEX**

LAVATORIES REQUIRED MEN 36 - 60 = 3WOMEN 36 - 60 = 3PROVIDED = 3 MENS ROOM **5 WOMENS ROOM**

PLUMBING FIXTURE COUNTS PROVIDED ARE IN COMPLIANCE

NO CHANGE, N.I.C.

PARKING DATA - NO CHANGE TO EXISTING
TOTAL PARKING STALLS PROVIDED ON BUILDING PROPERTY: 46 (NO CHANGE)

2 HC SPACES (NO CHANGE)
TOTAL: 70 PROVIDED

PARKING CAPACITIES PROVIDED ARE IN COMPLIANCE

OCCUPANCY LOAD CALCULATIONS AREA CALCULATION METHOD FIRST FLOOR 36 OCC.

53 OCC.

89 OCC.

EXITING CALCULATIONS - NO CHANGE TO EXISTING DOOR CAPACITY

(1) 36" EXIT WIDTHS 160 OCC. 32"/0.2IN =) 36" EXIT WIDTHS 32"/0.2IN= 160 OCC.

(2) 36" EXIT WIDTHS 70"/0.2" =

LOWER LEVEL

TOTAL INDOOR

TOTAL 670 OCC ALLOWABLE

(KDC O DE 0 OFFICE AREA **/**⊭// 1079 SF / 100 : /11 PERSONS AA OF MECHÁNICAL EQUIPMENT **ROOM** /RØØM/

//Æ//

191 SF / 300 =

I PERSONS

ELECTRICA

113 SF / 300 =

STORAGE

107 SF / 300 = 1 PERSONS

//1 PERSONS/

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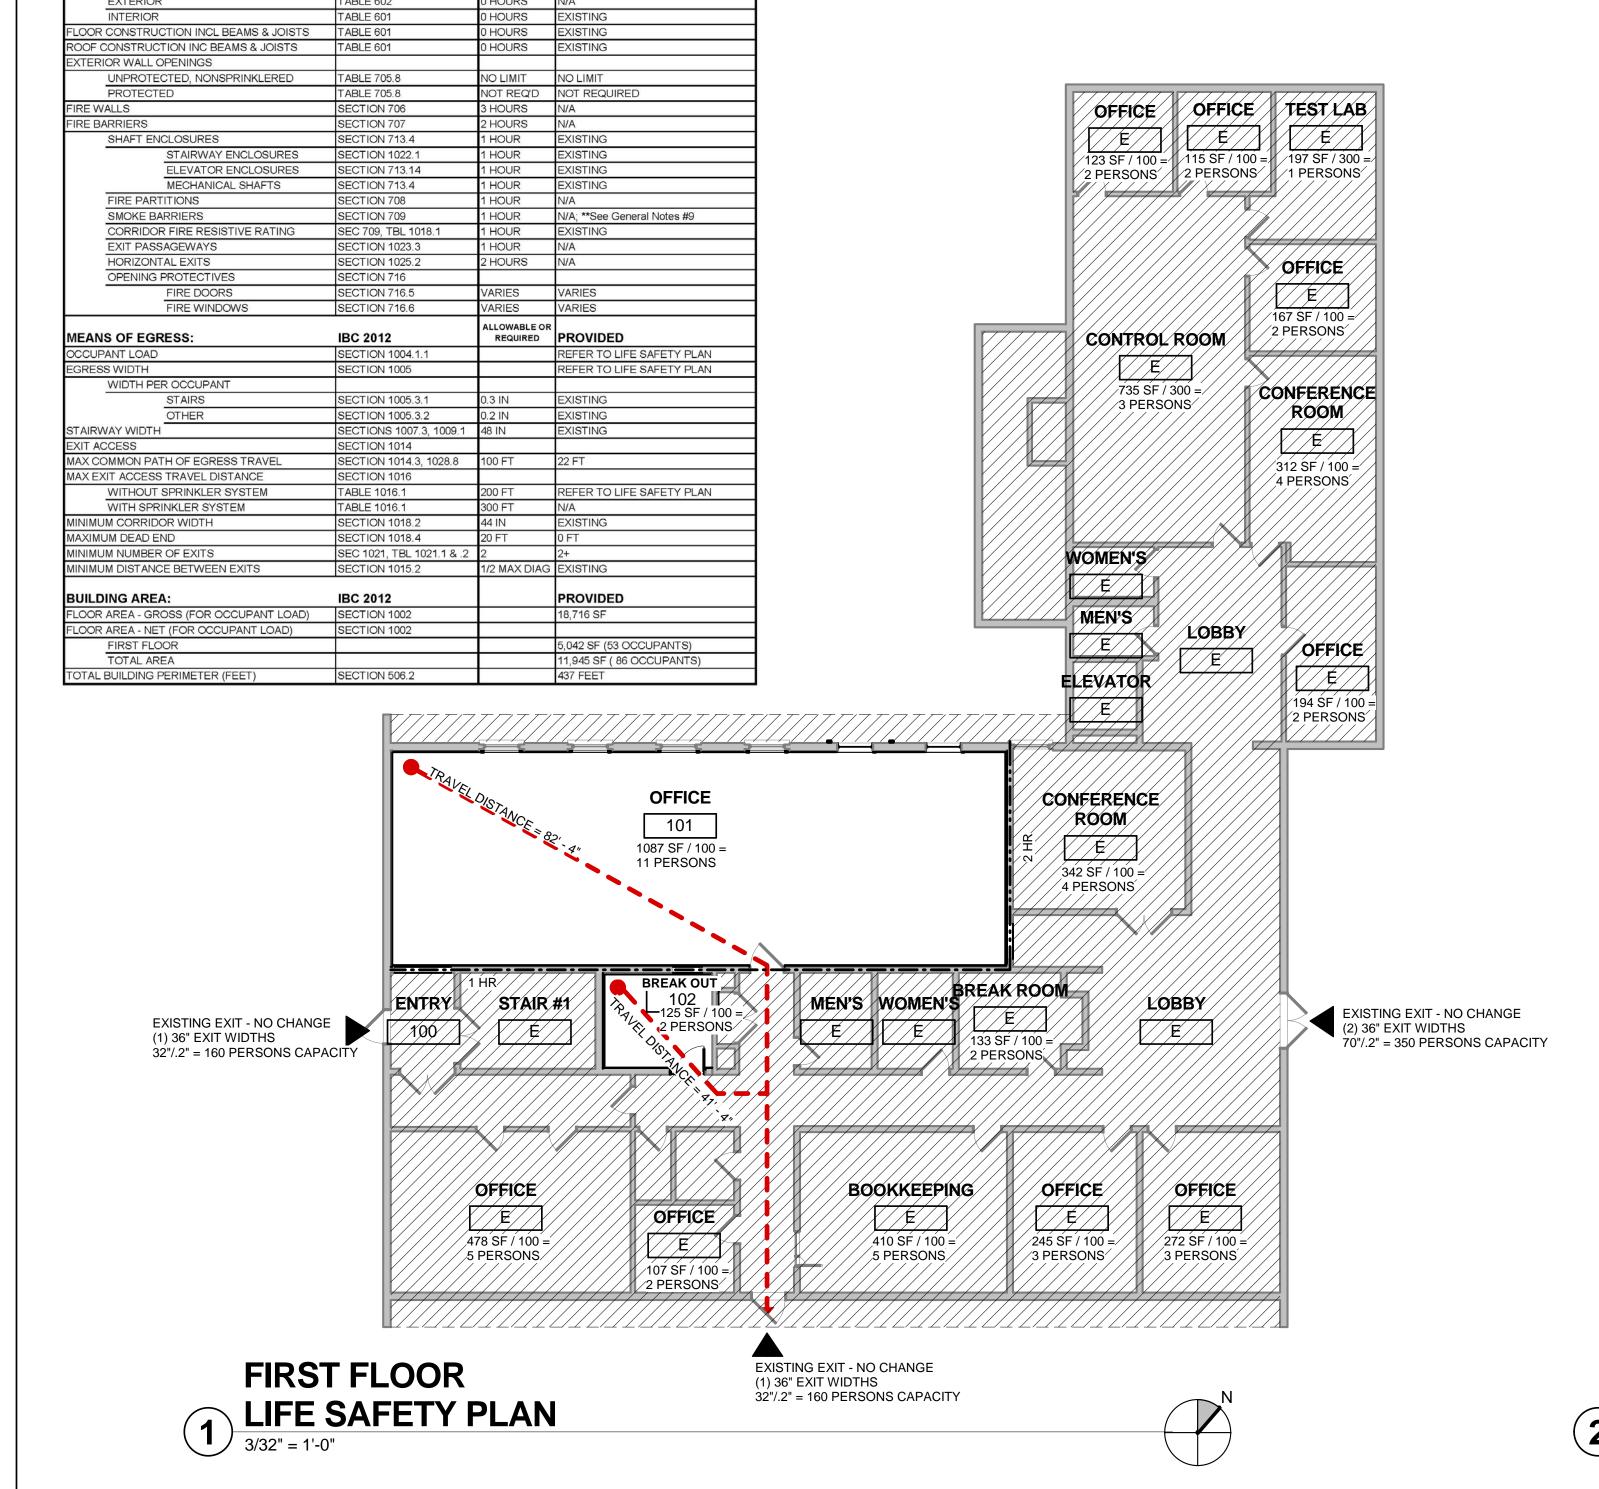
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2	ISSUED FOR 100% DESIGN	09/17/2018
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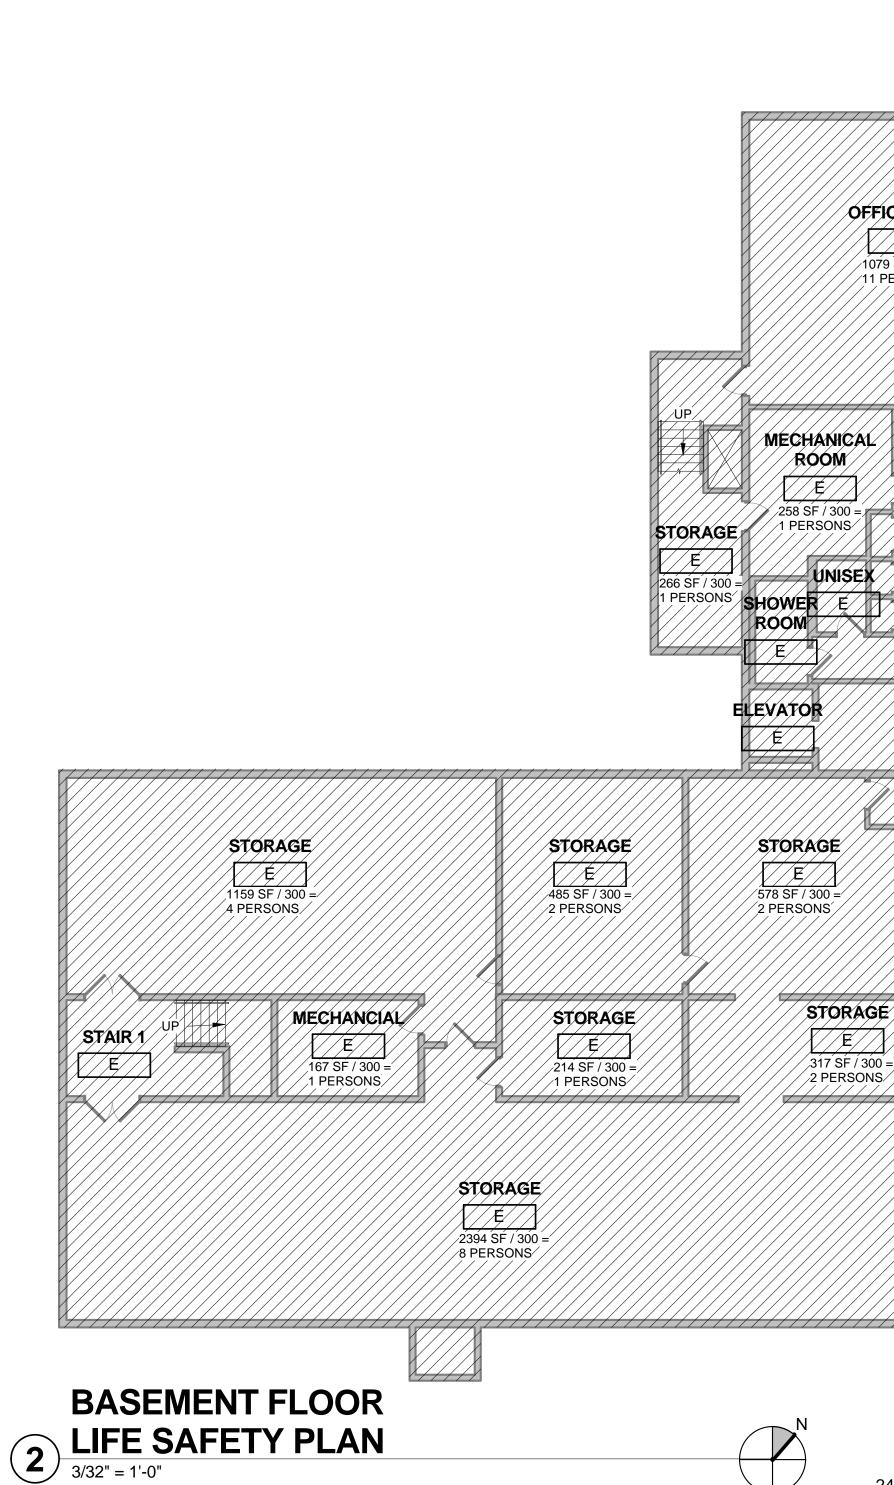
| LIFE SAFETY NOTES & CODE MATRIX

DRAWN: V.WIEGAND SHEET NO. CHECKED: K.KORAB DESIGNED: V.WIEGAND

JOB NO: 18-1006


G-004





1) FIRST FLOOR DEMOLITION PLAN


1/4" = 1'-0"

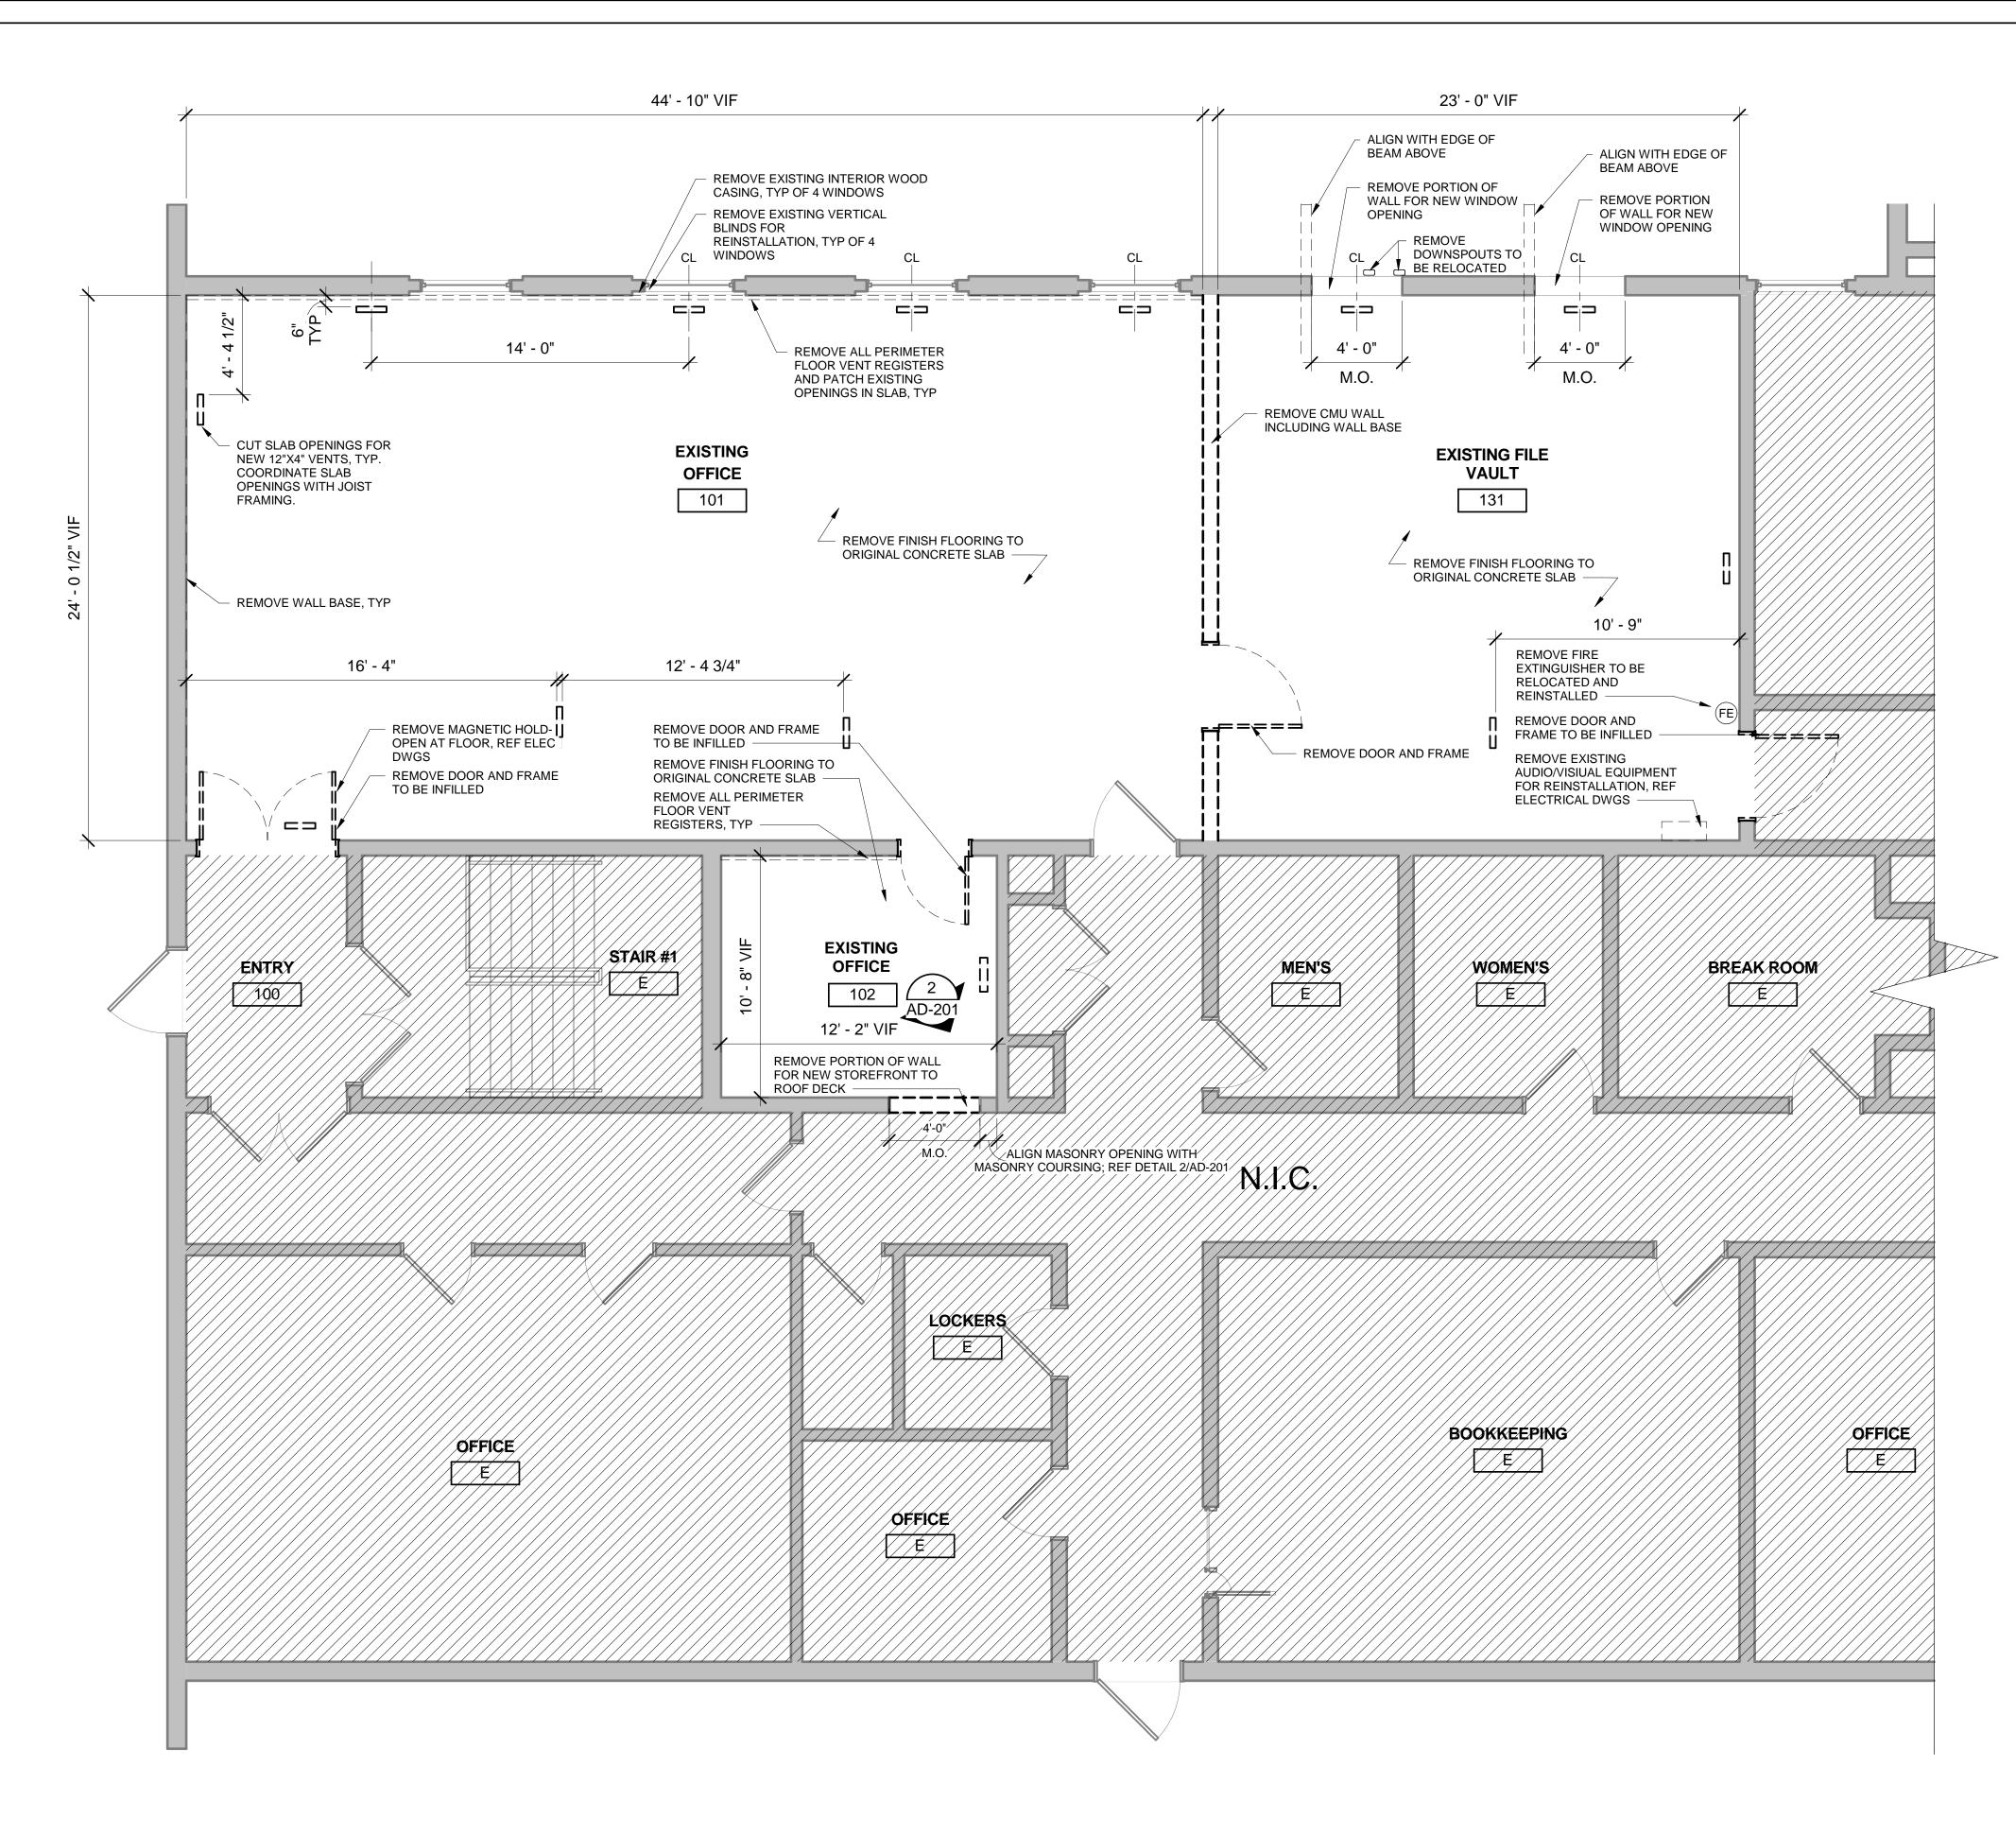

GENERAL NOTES - DEMO PLANS

- CONTRACTOR TO COORDINATE ALL REMOVAL WITH THE REQUIREMENTS OF NEW CONSTRUCTION. CONTRACTOR IS RESPONSIBLE FOR COMPLETE REMOVAL OF ALL ITEMS ASSOCIATED WITHIN THE DEMOLISHED AREA.
- WALLS TO BE REMOVED ARE TO BE REMOVED TO THE DECK, U.N.O. CONTRACTOR TO VERIFY CEILING HEIGHTS IN THE FIELD DURING BIDDING.
- REFERENCE MECH., AND ELEC. DEMO DRAWINGS FOR ASSOCIATED DEMO SCOPE.
- OWNER WILL REMOVE AND/OR RELOCATE ALL EXISTING FURNITURE, FILE CABINETS, STORAGE, SHELVING, ETC PRIOR TO CONSTRUCTION.
- REMOVE AUDIO/VISUAL AND EXIT SIGNS FOR REPLACEMENT; REFER TO ELECTRICAL DWGS.
- SCOPE OF WORK CONTAINS SUSPECT LOCATIONS OF HAZARDOUS BUILDING MATERIALS. ABATEMENT IN LOCATIONS CONTAINING HAZARDOUS BUILDING MATERIALS IS REQUIRED. CONTRACTOR TO COMPLY WITH PROPER REMOVAL/MITIGRATION PROCEDURES AS REQUIRED

EDGE OF MASONRY OPENING

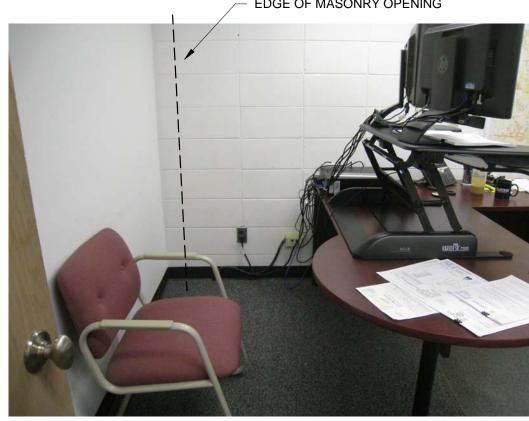

BREAK OUT ROOM EXISTING INTERIOR ELEVATION



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RENOVATION KANE COUNTY OF TRANSPORT OFFICE REI

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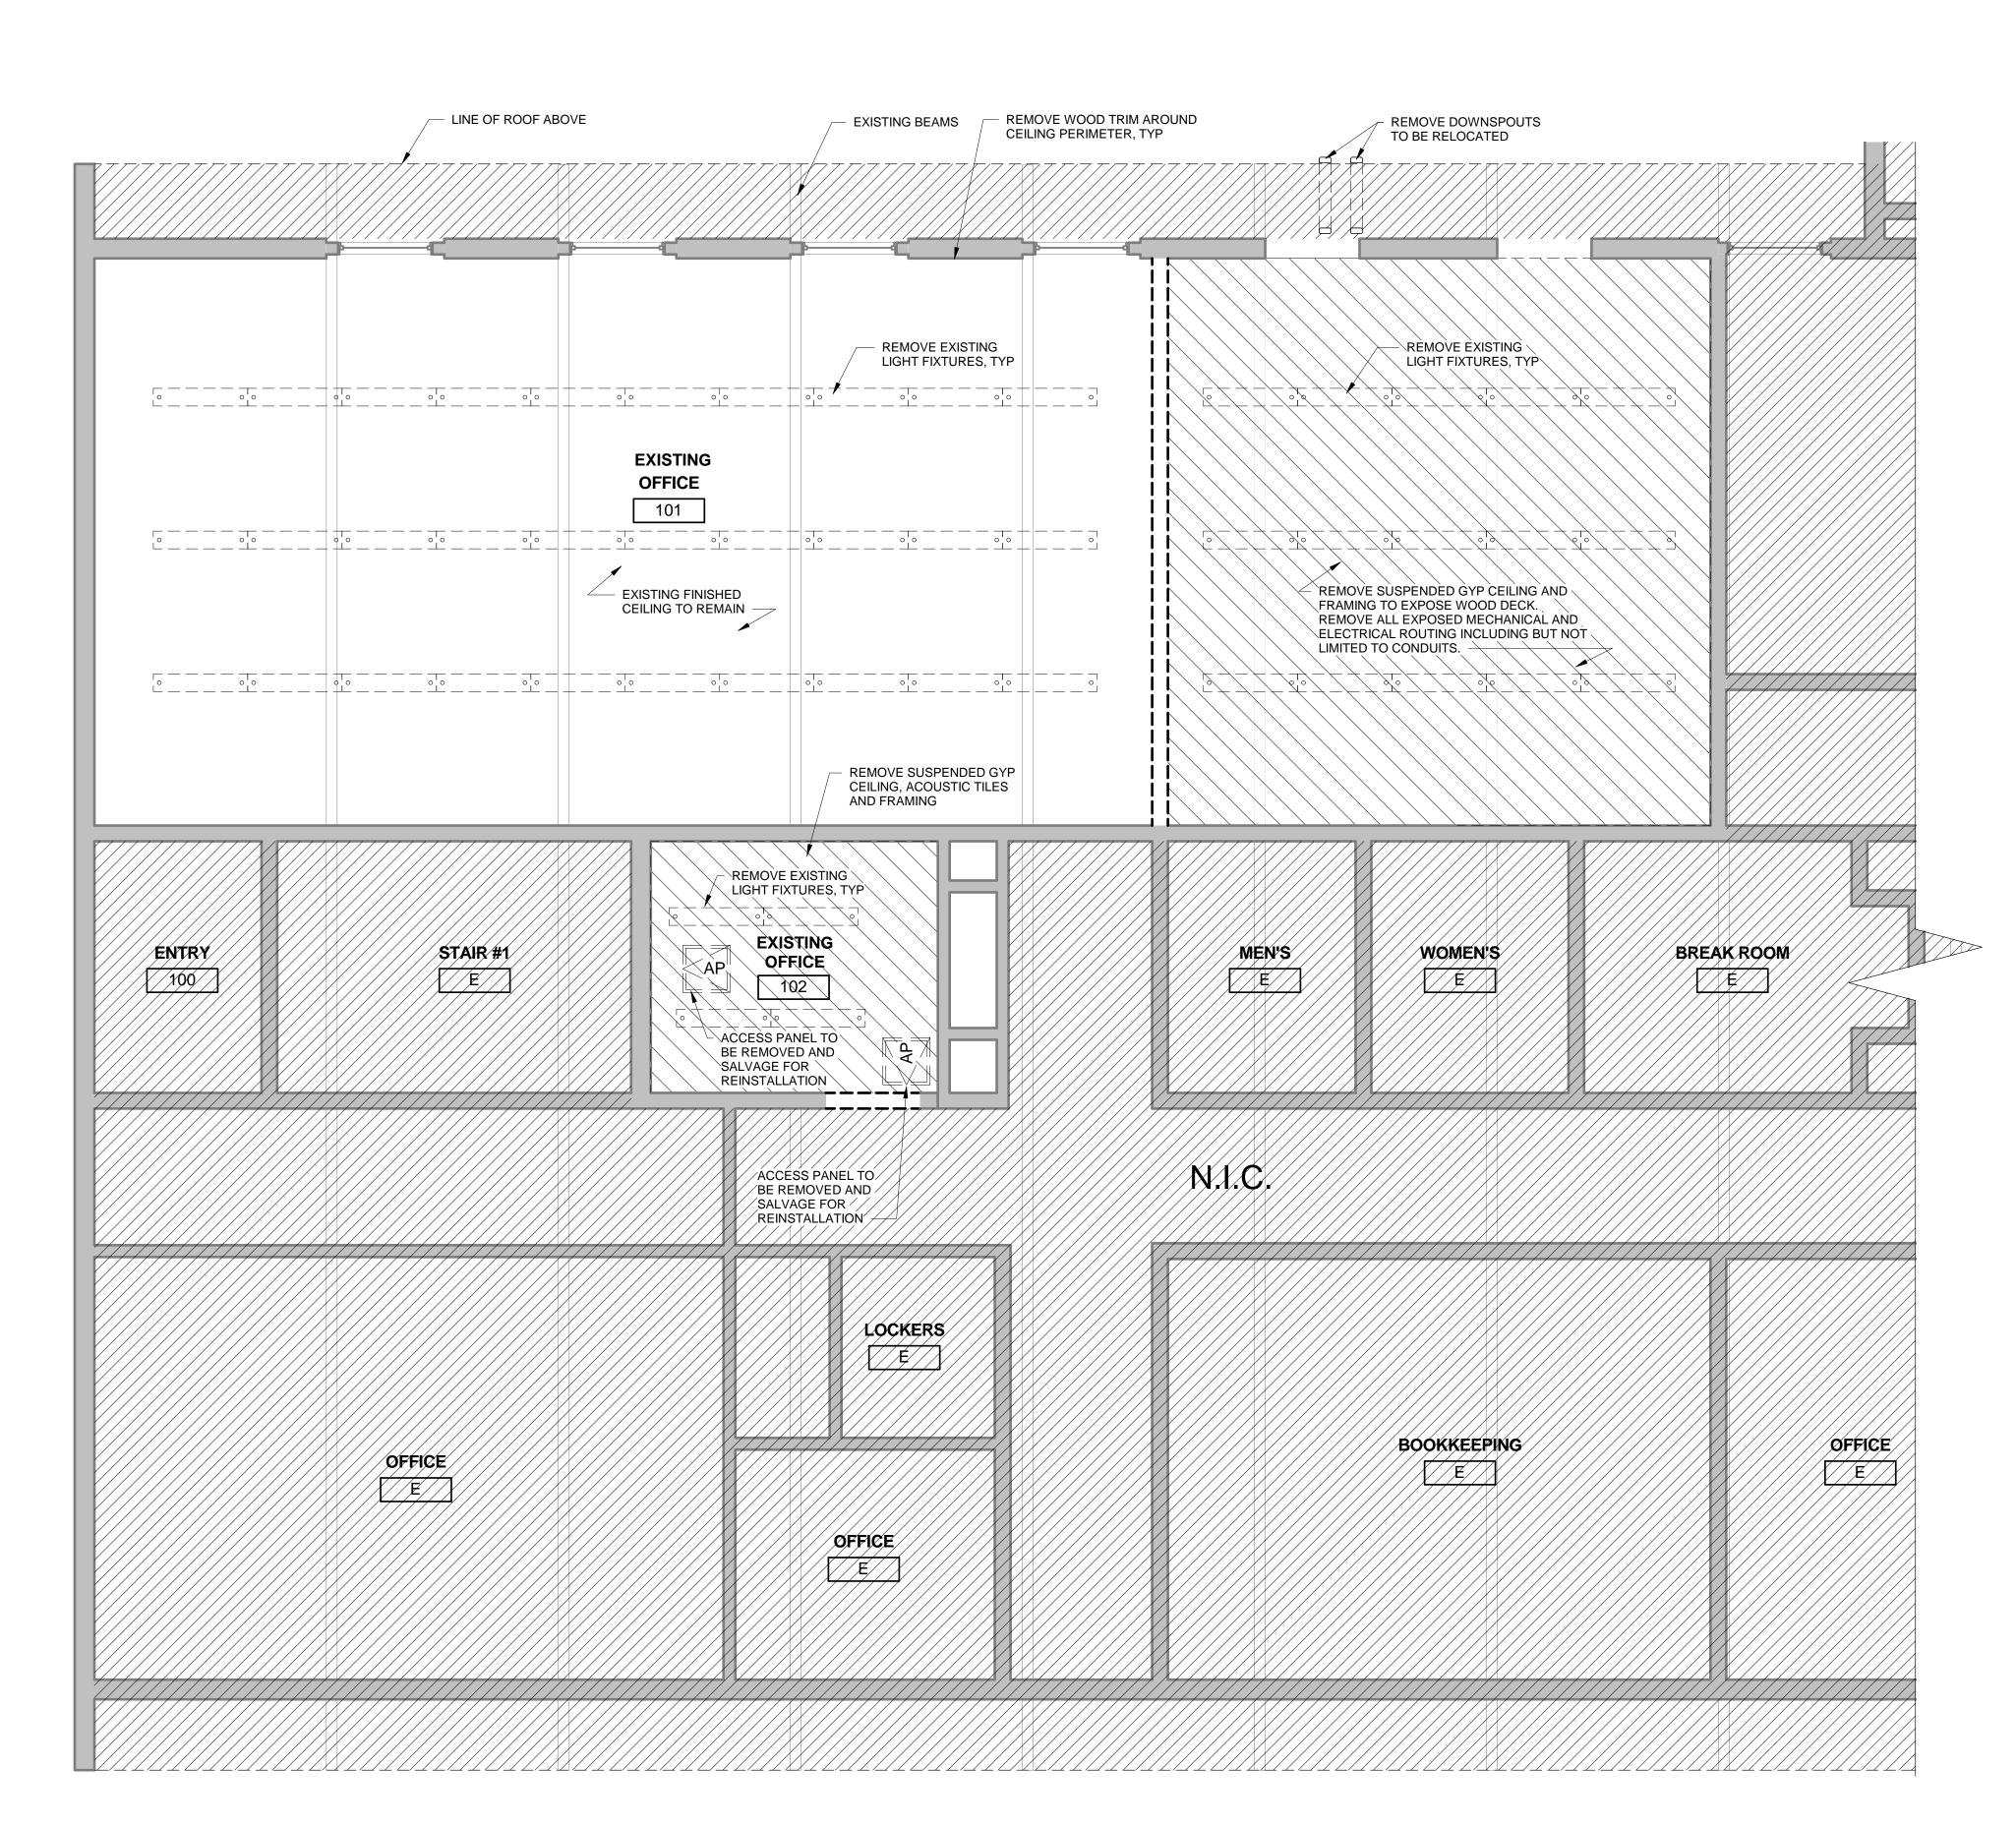
No.	Description	Date
1	ISSUED FOR 30% DESIGN	07/23/2018
2	ISSUED FOR 100% DESIGN	09/17/2018
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FIRST FLOOR **DEMOLITION PLAN**

DRAWN: V.WIEGAND SHEET NO. CHECKED: K.KORAB DESIGNED: V.WIEGAND

JOB NO: 18-1006

AD-201



GENERAL NOTES - DEMO PLANS

- CONTRACTOR TO COORDINATE ALL REMOVAL WITH THE REQUIREMENTS OF NEW CONSTRUCTION. CONTRACTOR IS RESPONSIBLE FOR COMPLETE REMOVAL OF ALL ITEMS ASSOCIATED WITHIN THE DEMOLISHED AREA.
- 2. REFERENCE MECH., AND ELEC., DEMO DRAWINGS FOR ASSOCIATED DEMO SCOPE.
- SCOPE OF WORK CONTAINS SUSPECT LOCATIONS OF HAZARDOUS BUILDING MATERIALS. ABATEMENT IN LOCATIONS CONTAINING HAZARDOUS BUILDING MATERIALS IS REQUIRED. CONTRACTOR TO COMPLY WITH PROPER REMOVAL/MITIGRATION PROCEDURES AS



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RENOVATION KANE COUNTY
OF TRANSPORT
OFFICE REI

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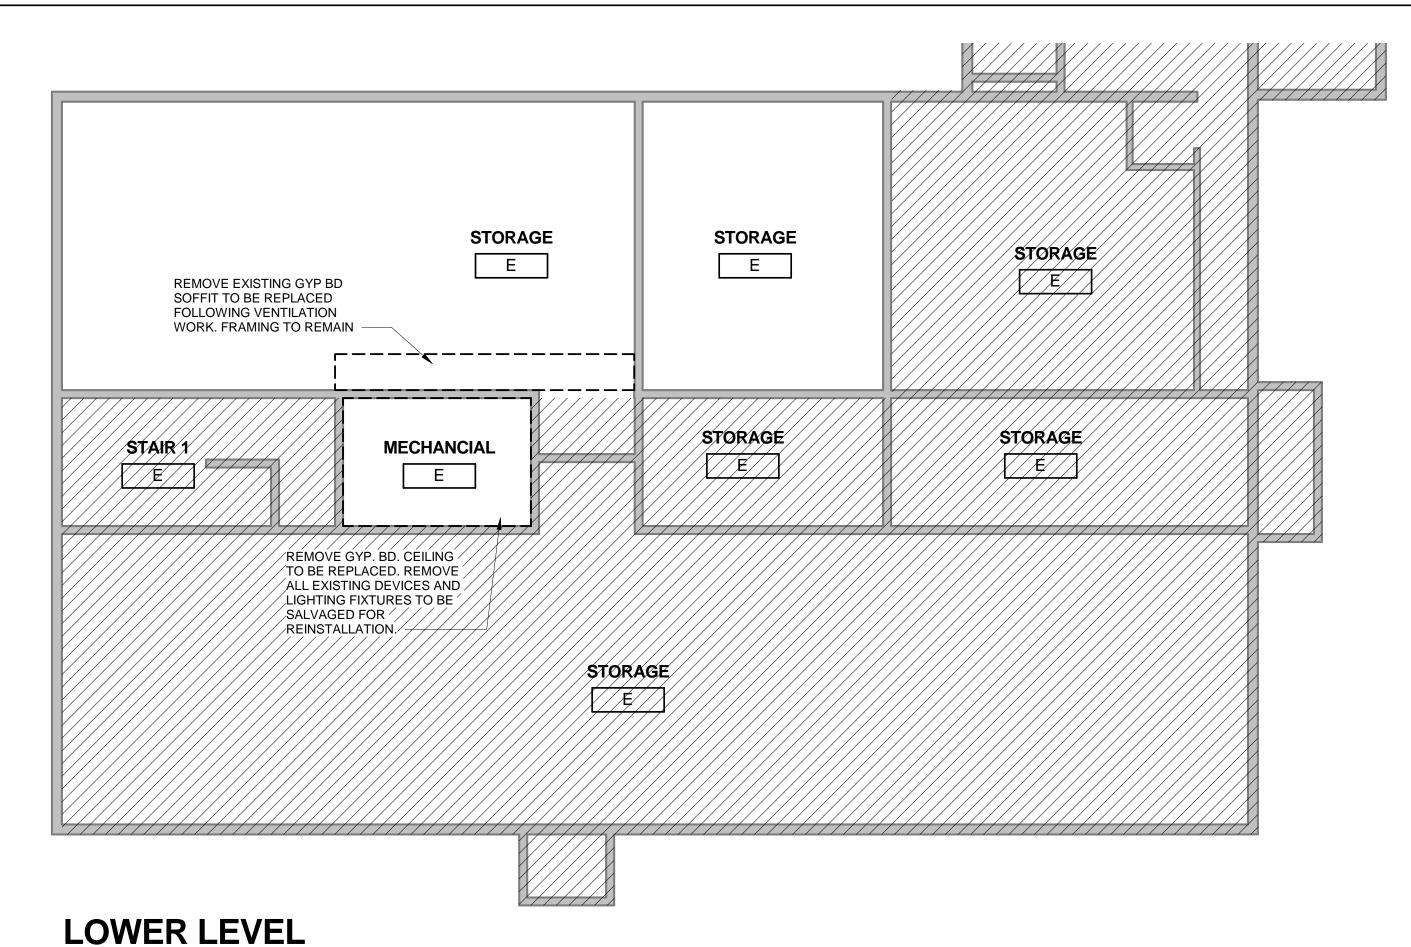
No.	Description	Date
1	ISSUED FOR 30% DESIGN	07/23/2018
2	ISSUED FOR 100% DESIGN	09/17/2018

FIRST FLOOR DEMOLITION REFLECTED **CEILING PLAN**

AD-801

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JOB NO: 18-1006




DEMOLITION FLOOR PLAN

LOWER LEVEL

FLOOR PLAN

1/8" = 1'-0"

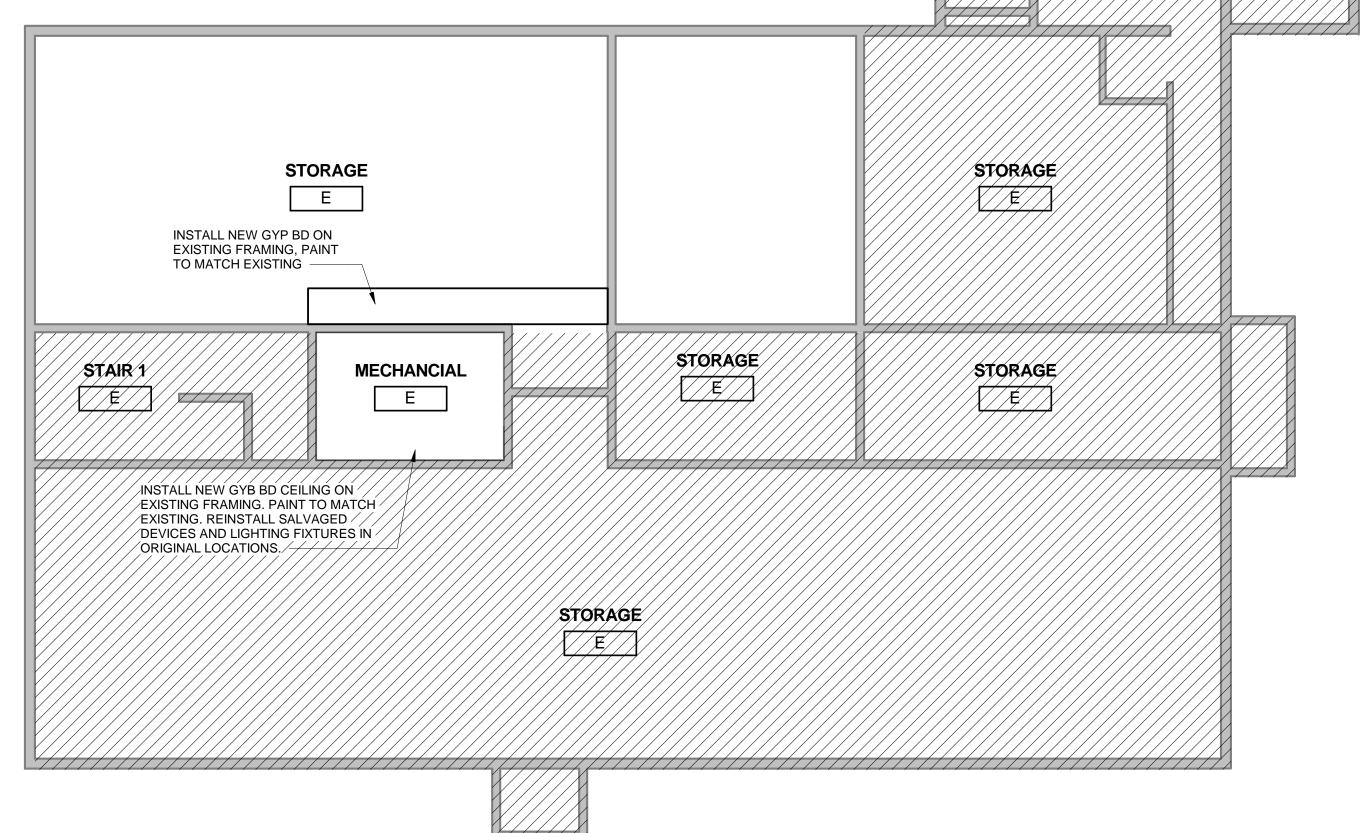

GENERAL NOTES - DEMO PLANS

- CONTRACTOR TO COORDINATE ALL REMOVAL WITH THE REQUIREMENTS OF NEW CONSTRUCTION. CONTRACTOR IS RESPONSIBLE FOR COMPLETE REMOVAL OF ALL ITEMS ASSOCIATED WITHIN THE DEMOLISHED AREA.
- REFERENCE MECH., AND ELEC., DEMO DRAWINGS FOR ASSOCIATED DEMO SCOPE.
- SCOPE OF WORK CONTAINS SUSPECT LOCATIONS OF HAZARDOUS BUILDING MATERIALS. ABATEMENT IN LOCATIONS CONTAINING HAZARDOUS BUILDING MATERIALS IS REQUIRED. CONTRACTOR TO COMPLY WITH PROPER REMOVAL/MITIGRATION PROCEDURES AS REQUIRED.

RCP NOTES

- MATERIAL FINISH LEGEND, SEE SHEET A-701. LIGHTING FIXTURES; REF ELECTRICAL DWGS.
- ALL CEILING FIXTURES AND DEVICES TO BE CENTERED IN CEILING AND/OR ALIGNED WITH ARCHITECTURAL ELEMENTS UNLESS NOTED OTHERWISE.
- REFERENCE ELEC DWGS FOR ADDITIONAL LIGHT FIXTURE INFO.
- ANY CEILING MOUNTED LIGHTING OR DEVICES MAY BE SUSPENDED FROM WOOD DECK BUT FASTENERS SHALL NOT PENETRATE FULLY THROUGH THE DECK.



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No.	Description	Date
1	ISSUED FOR 100% DESIGN	09/17/2018

LOWER LEVEL DEMOLITION PLAN AND NEW FLOOR PLAN

A-101


DRAWN: V.WIEGAND SHEET NO. CHECKED: K.KORAB DESIGNED: V.WIEGAND JOB NO: 18-1006

FLOOR PLAN NOTES

- PARTITION TYPES, SEE SHEET A-301.
- FINISH FLOOR PLAN, SEE SHEET A-701.
- FURNITURE PLAN, SEE SHEET A-702.



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DETAIL AT FLOOR INFILL

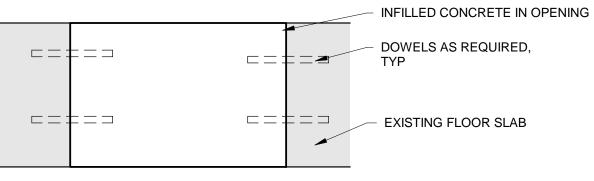6" = 1'-0"

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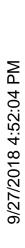
No.	Description	Date
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2	ISSUED FOR 30% DESIGN	07/23/2018
3	ISSUED FOR 100% DESIGN	09/17/2018


FIRST FLOOR PLAN

DRAWN: V.WIEGAND SHEET NO. CHECKED: K.KORAB DESIGNED: V.WIEGAND

A-201 JOB NO: 18-1006

1 FIRST FLOOR PLAN
1/4" = 1'-0"



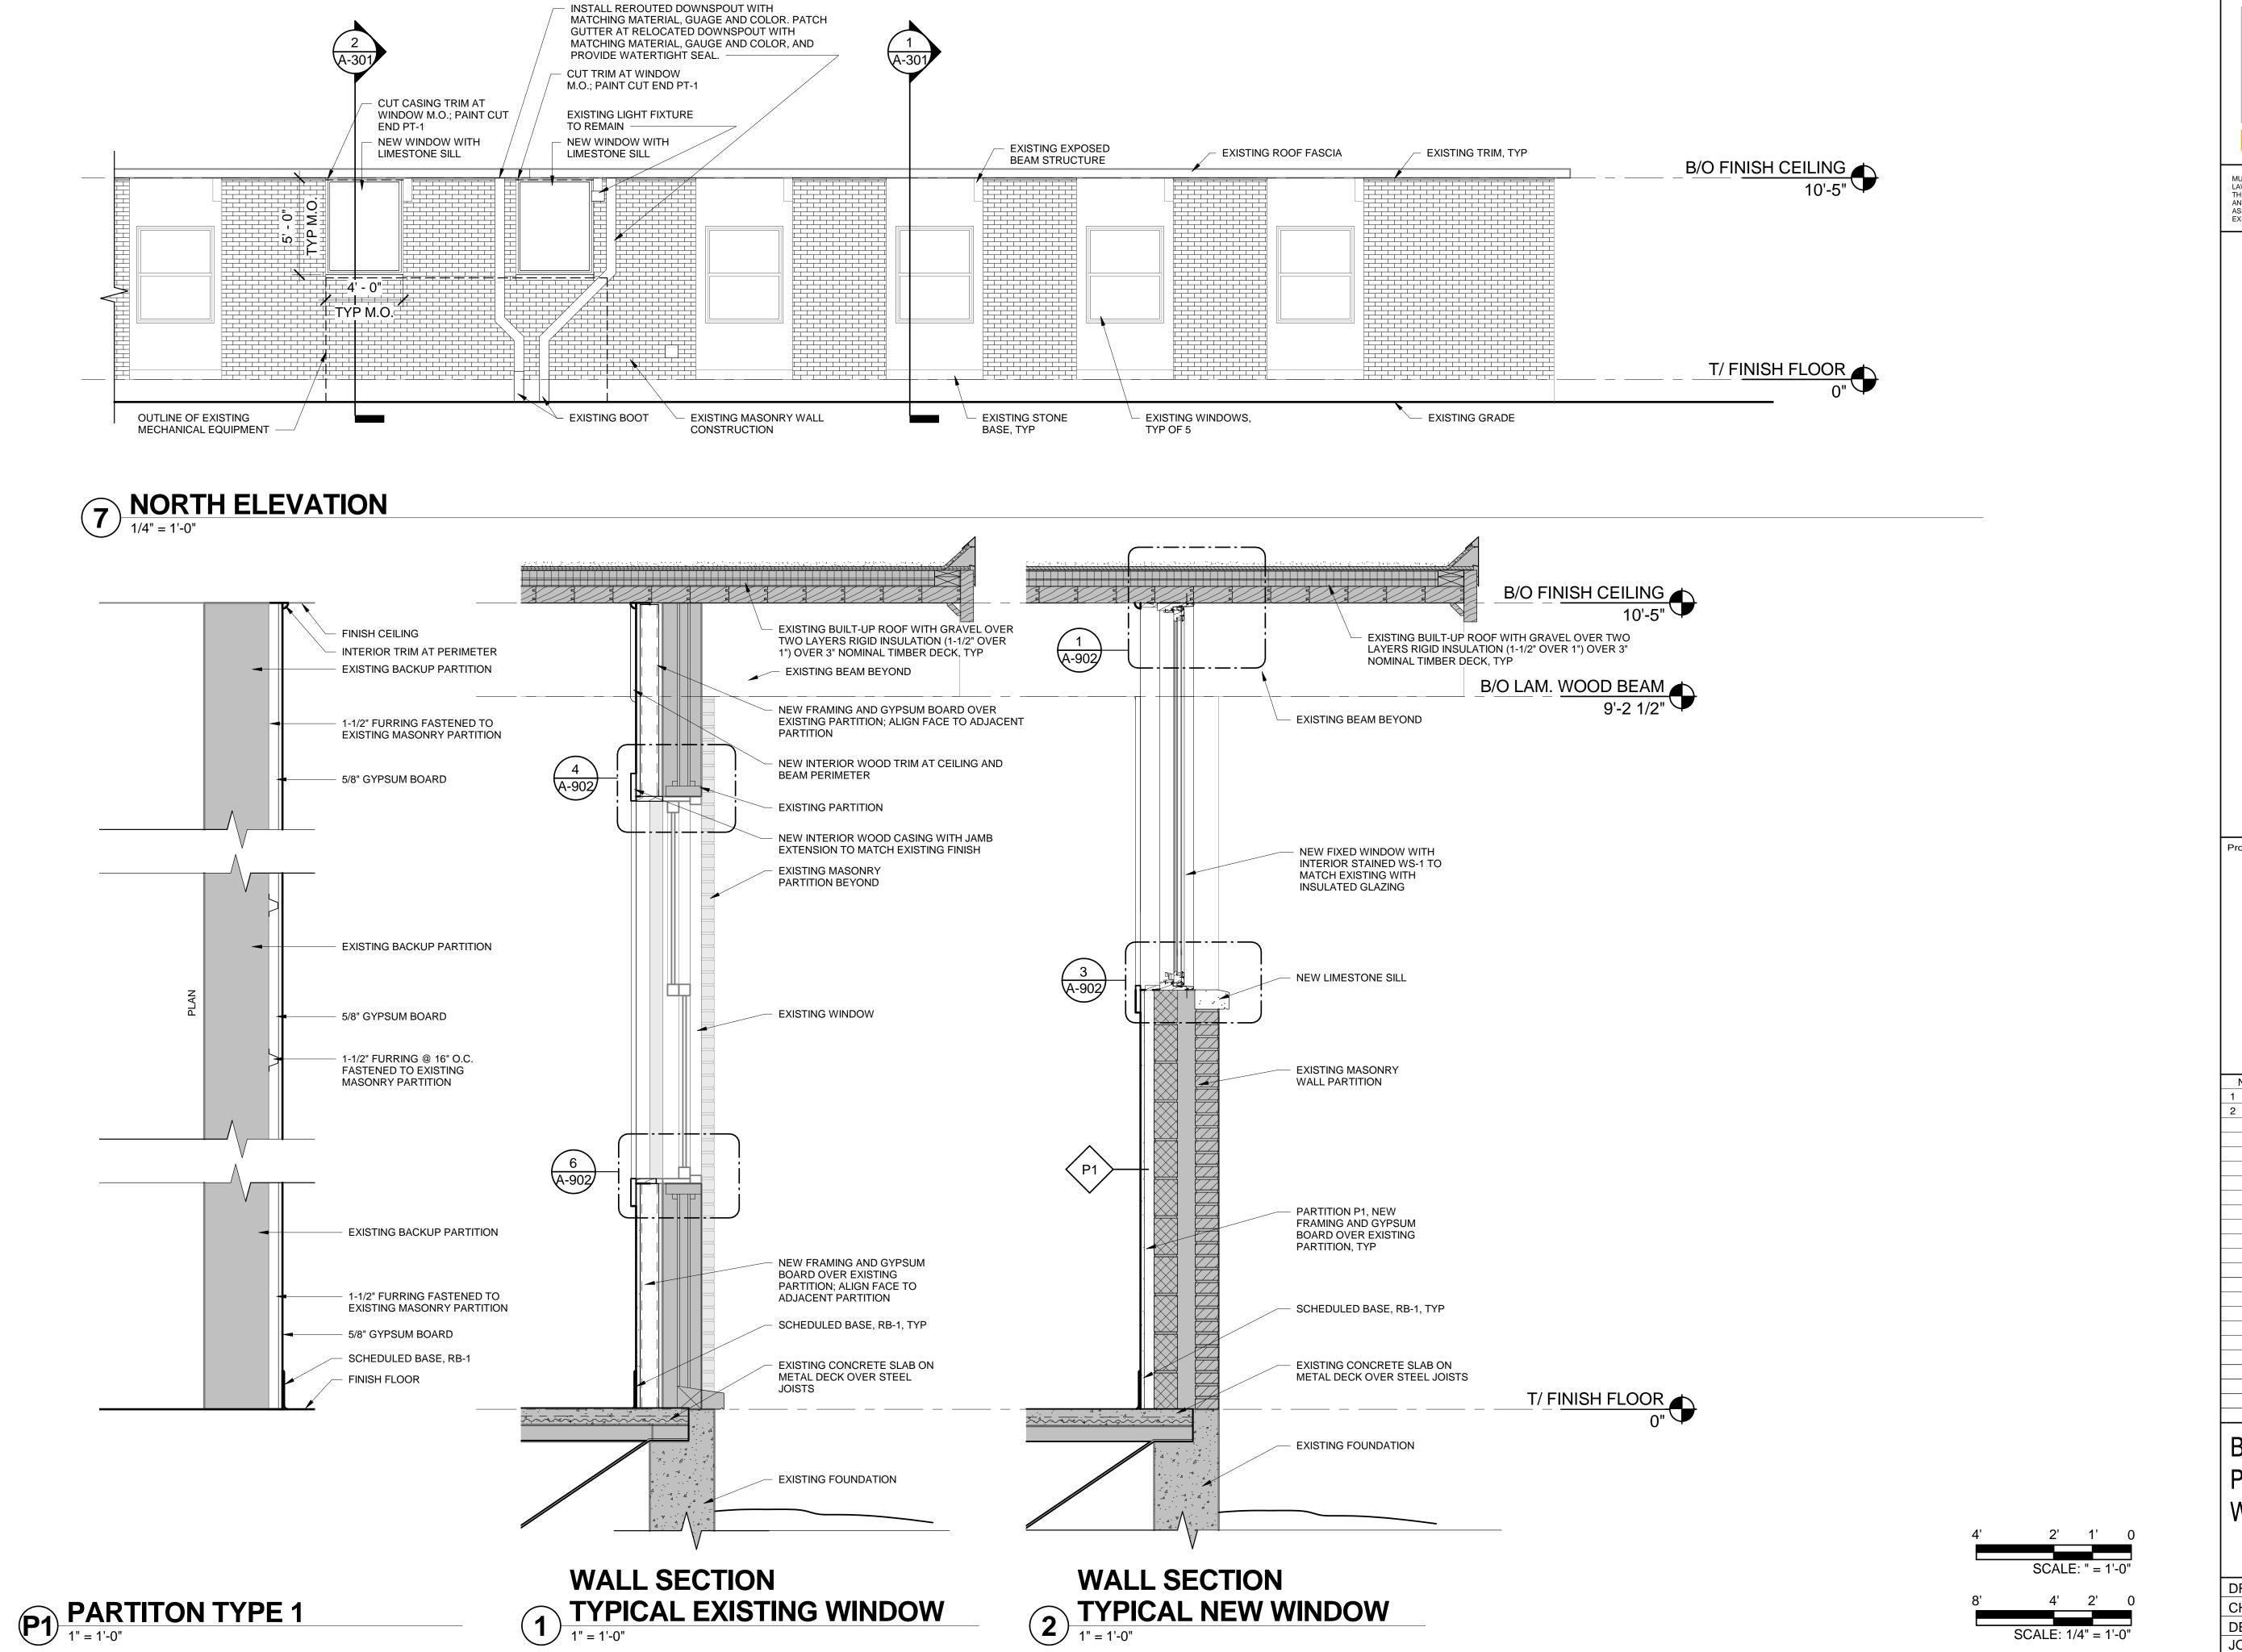

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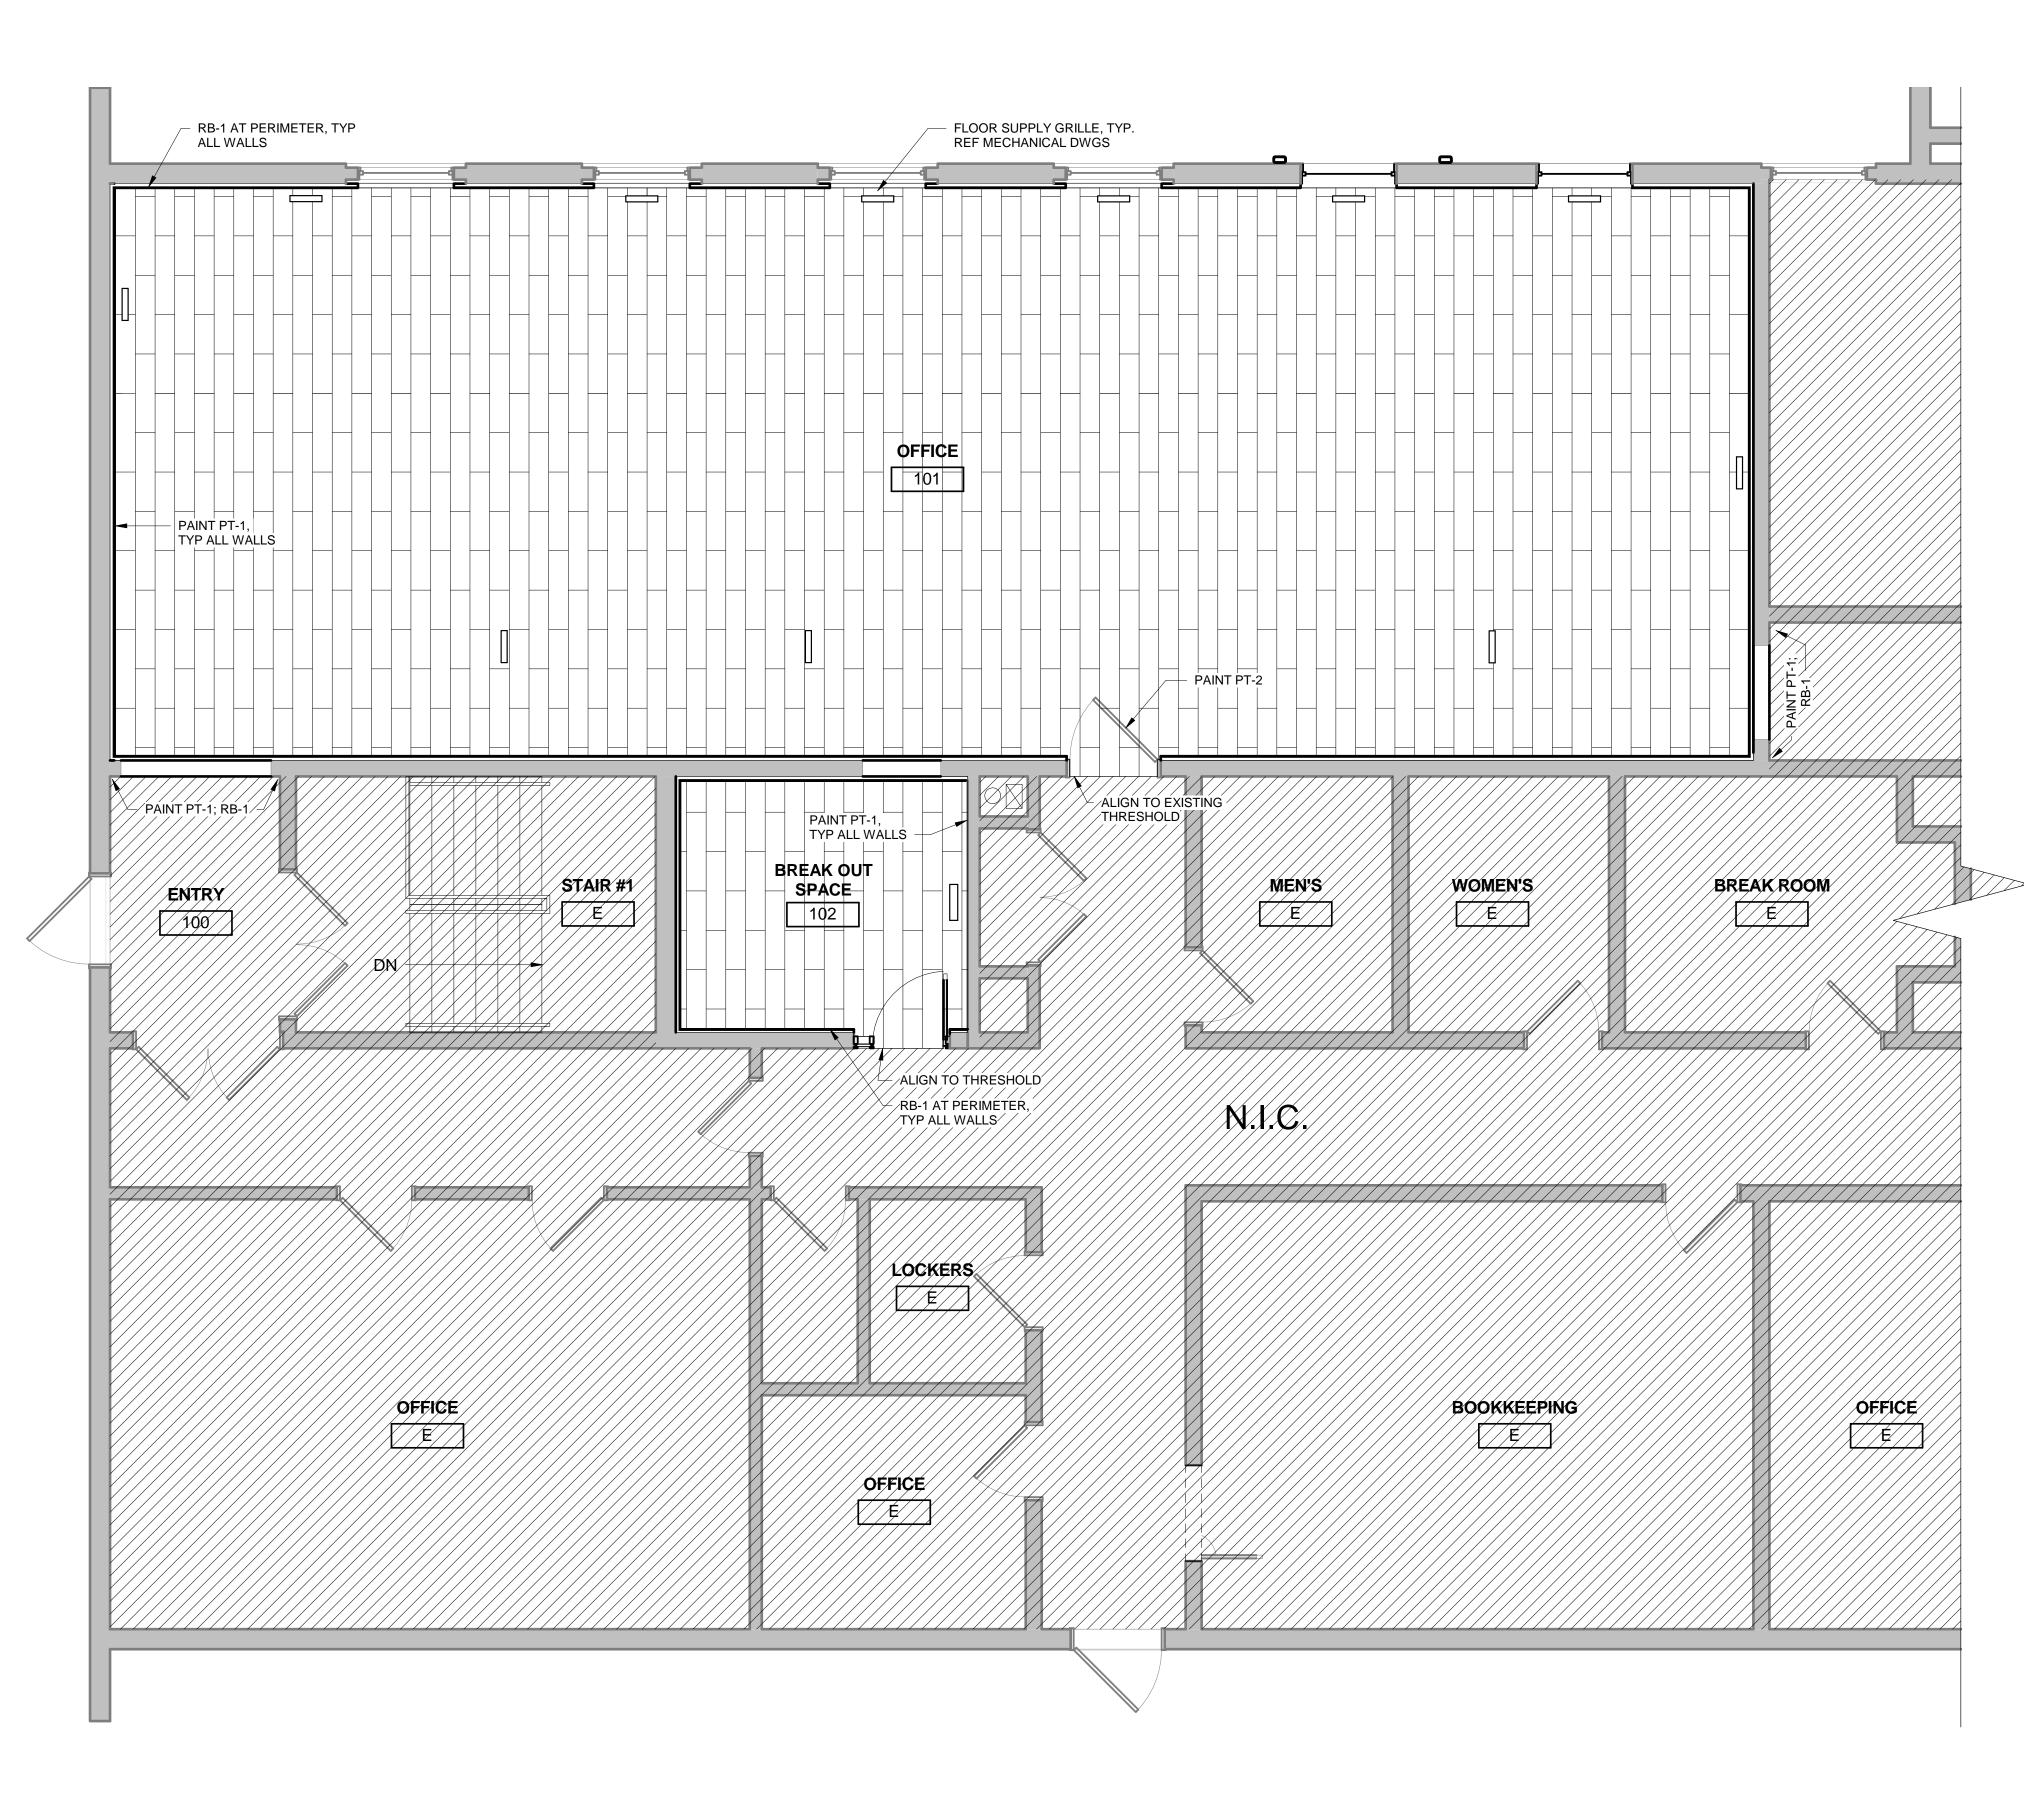
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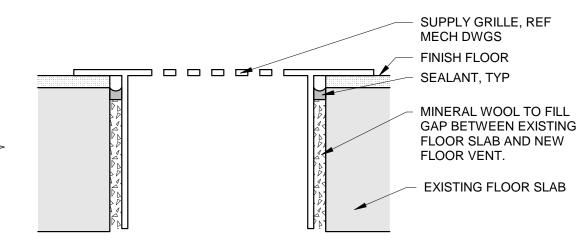
No.	Description	Date		
1	ISSUED FOR 30% DESIGN	07/23/2018		
2	ISSUED FOR 100% DESIGN	09/17/2018		
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BUILDING ELEVATIONS, PARTITION TYPES, AND WALL SECTIONS

DRAWN:	V.WIEGAND	SHEET NO.
CHECKED:	K.KORAB	A 204
DESIGNED:	V.WIEGAND	A-301
JOB NO: 18	-1006	



MATERIAL FINISH LEGEND **DESCRIPTION** ABBREV DESCRIPTION **EXTERIOR/INTERIOR WALL FINISHES** BASIS OF DESIGN GWB-1 GYPSUM WALL BOARD (SEE SPECIFICATIONS) RB-1 RESILIENT BASE MATCH EXISTING PT - 1 COLOR: SW 7035 PAINT **AESTHETIC WHITE** PT - 2 PAINT **COLOR: SW 6991 BLACK MAGIC** WS-1 **WOOD STAIN** MATCH EXISTING WINDOWS **CEILING FINISHES** GWB-1 **GYPSUM BOARD** BASIS OF DESIGN (SEE SPECIFICATIONS) WS-2 **WOOD STAIN** MATCH EXISTING BEAMS, AND TONGUE AND GROOVE FLOOR FINISHES CARPET TILE BASIS OF DESIGN: CPT-1 INTERFACE, NET EFFECT COLLECTION B701, 25CM X 1M, COLOR 102893 CASPIAN



DETAIL AT FLOOR REGISTER 6" = 1'-0"



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Professional Seals

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No.	Description	Date
1	ISSUED FOR 30% DESIGN	07/23/2018
2	ISSUED FOR 100% DESIGN	09/17/2018
		1

FIRST FLOOR FINISH PLAN

DRAWN: V.WIEGAND SHEET NO. CHECKED: K.KORAB DESIGNED: V.WIEGAND A-701

JOB NO: 18-1006



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KANE COUNTY DEPARTMENT
OF TRANSPORTATION
OFFICE RENOVATION

Professional Seals


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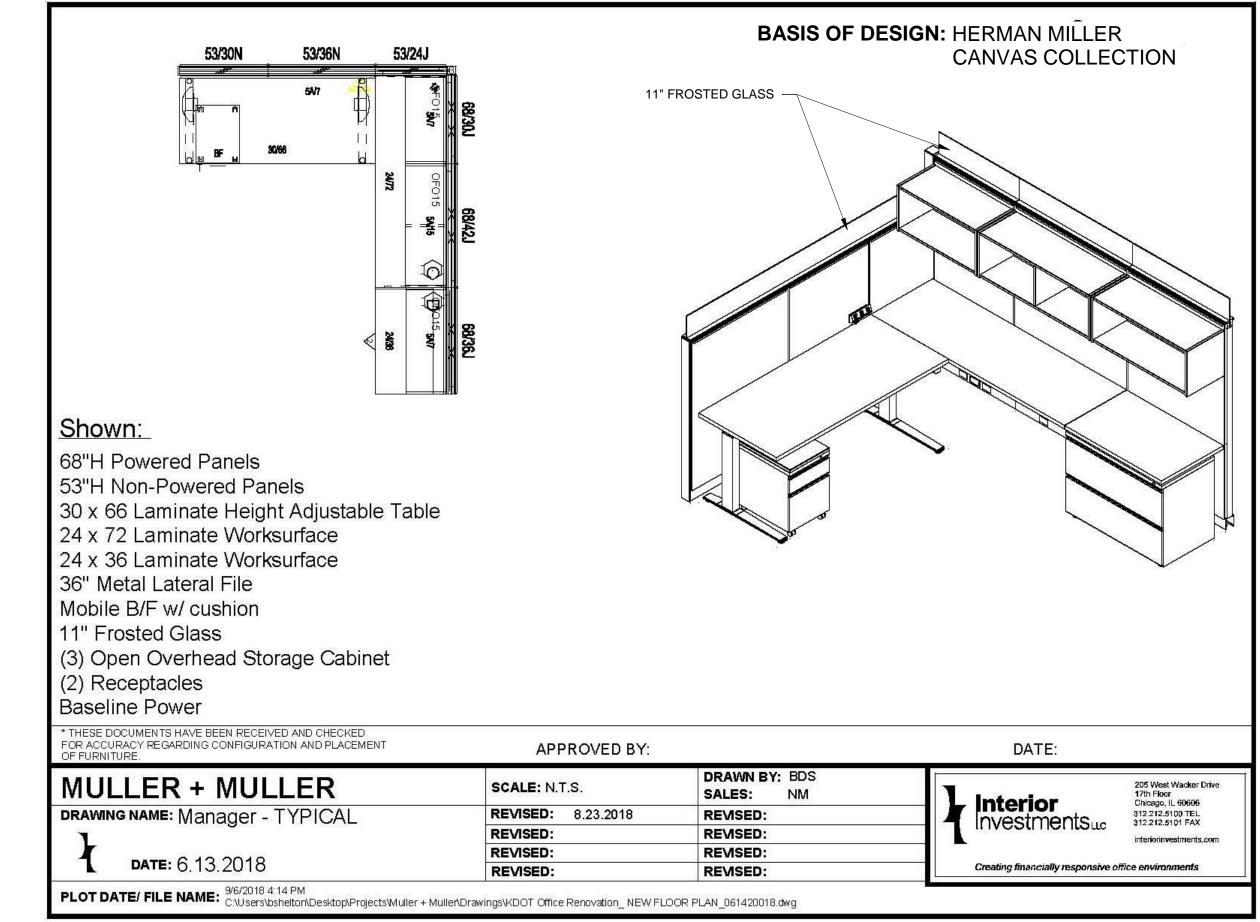
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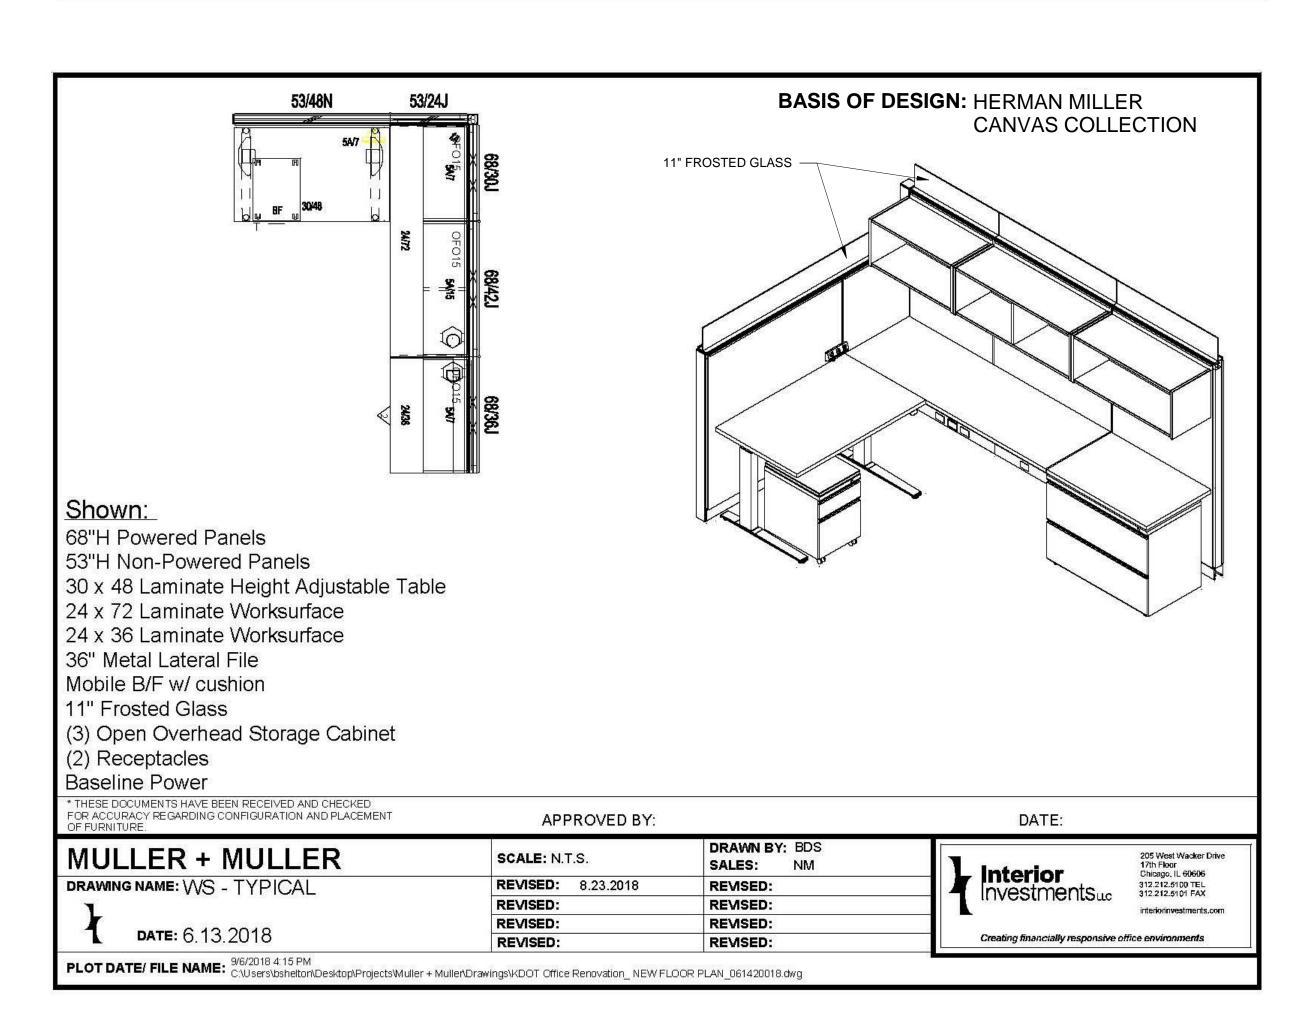
FIRST FLOOR FURNITURE PLAN

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RENOVATION

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No.	Description	Date
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2	ISSUED FOR 100% DESIGN	09/17/2018

FURNITURE TYPICAL


WORKSTATIONS

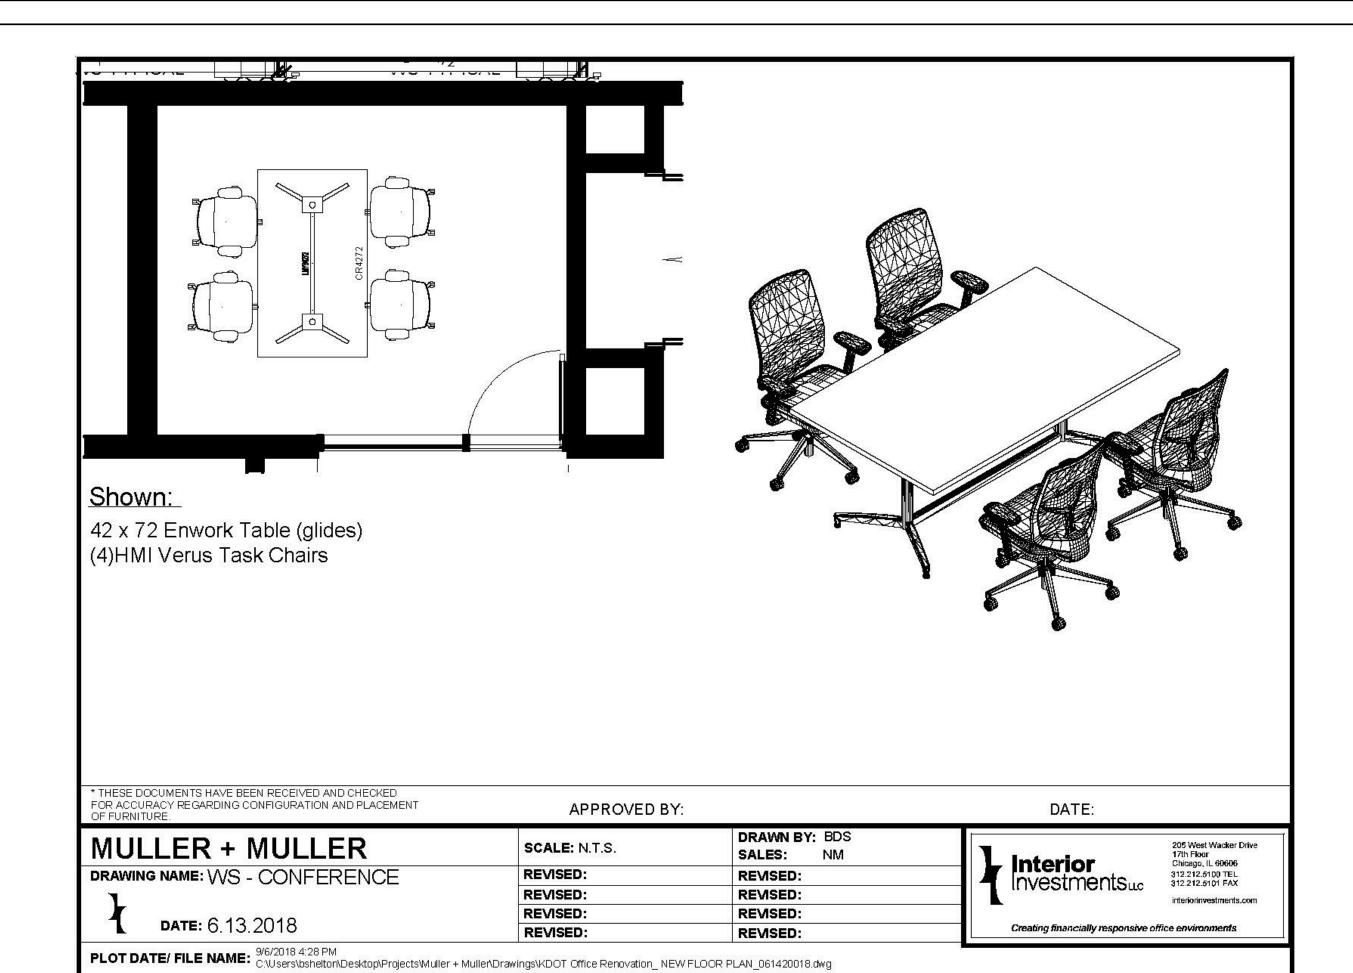DRAWN: V.WIEGAND SHEET NO. CHECKED: K.KORAB DESIGNED: V.WIEGAND

A-703 JOB NO: 18-1006

FIRST FLOOR

1 REFLECTED CEILING PLAN
1/4" = 1'-0"

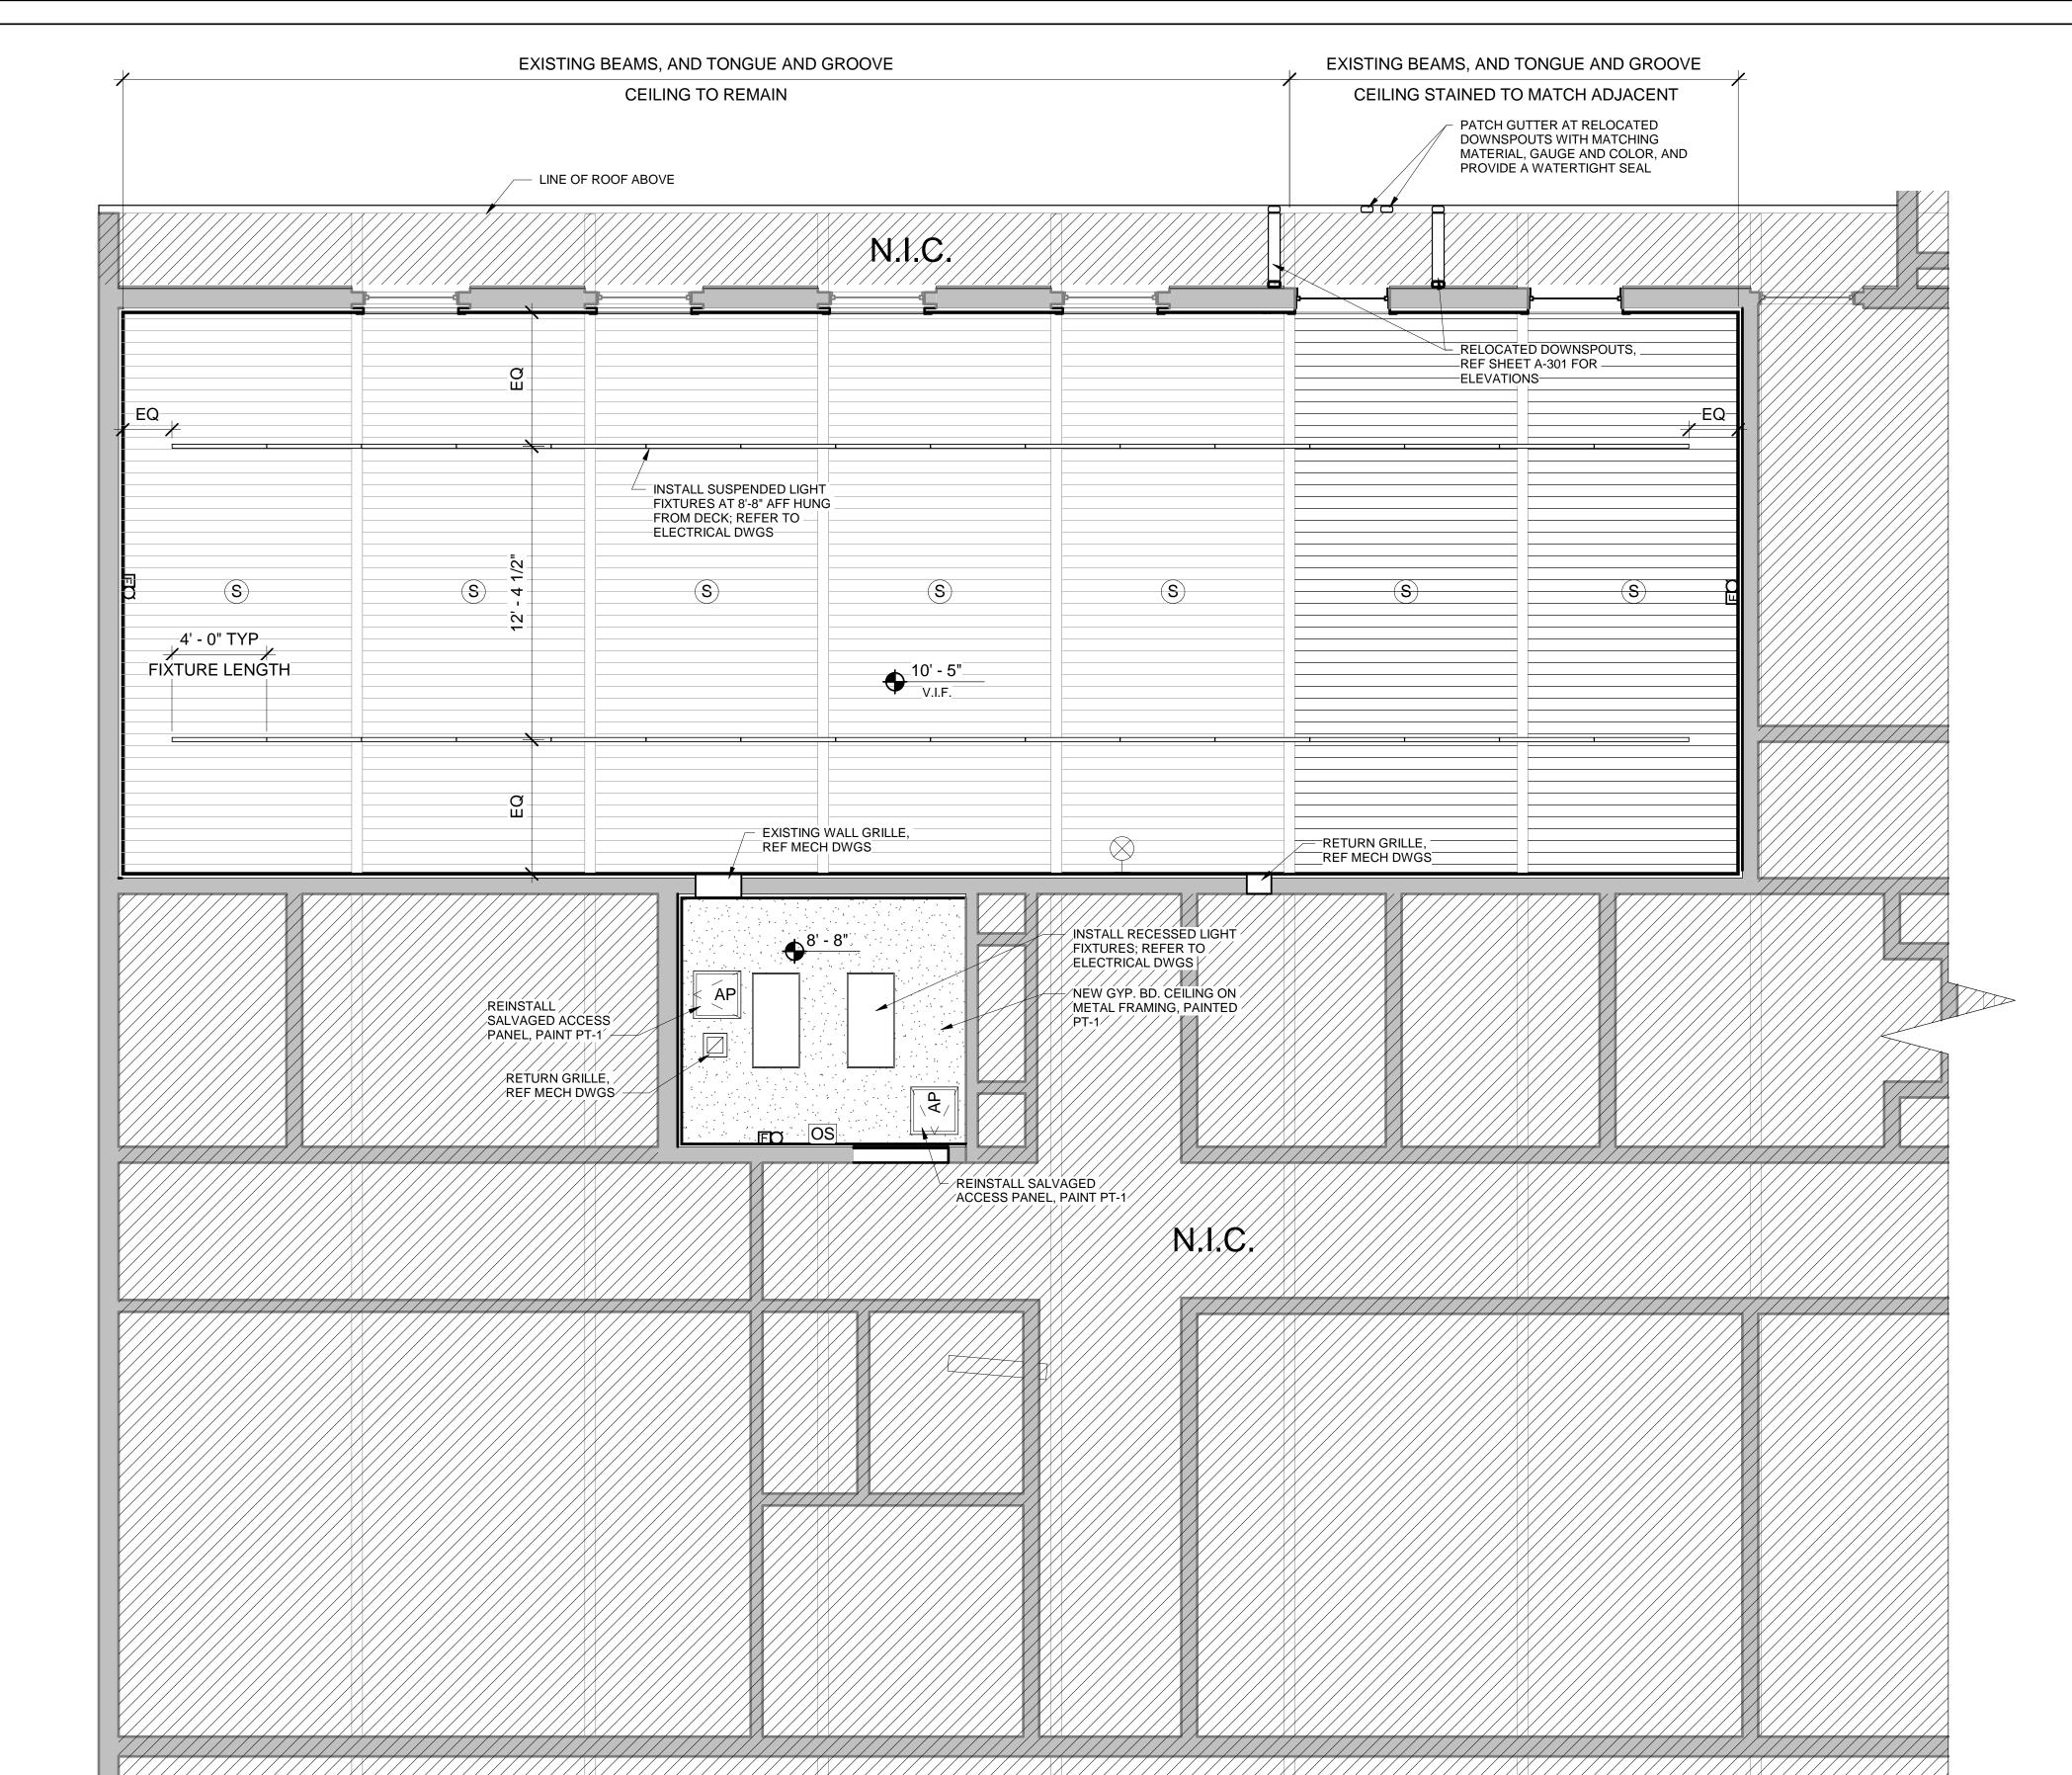

RCP NOTES

- MATERIAL FINISH LEGEND, SEE SHEET A-701.
- LIGHTING FIXTURES; REF ELECTRICAL DWGS. ALL CEILING FIXTURES AND DEVICES TO BE CENTERED IN CEILING AND/OR ALIGNED WITH ARCHITECTURAL ELEMENTS UNLESS NOTED OTHERWISE.
- REFERENCE ELEC DWGS FOR ADDITIONAL LIGHT FIXTURE INFO.
- ANY CEILING MOUNTED LIGHTING OR DEVICES MAY BE SUSPENDED FROM WOOD DECK BUT FASTENERS SHALL NOT PENETRATE FULLY THROUGH THE DECK.

RCP LEGEND

OS

S

F

2x4 LAY-IN LIGHT FIXTURE; REF ELEC DWGS

PENDANT LIGHT FIXTURE; REF ELEC DWGS

EXIT SIGN (WALL MTD); REF ELEC DWGS

OCCUPANCY SENSOR; REF ELEC DWGS

SMOKE DETECTOR; REF ELEC DWGS

> FIRE ALARM HORN/STROBE; REF ELEC DWGS

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KANE COUNTY DEPARTMENT OF TRANSPORTATION (KDOT) OFFICE RENOVATION

Professional Seals


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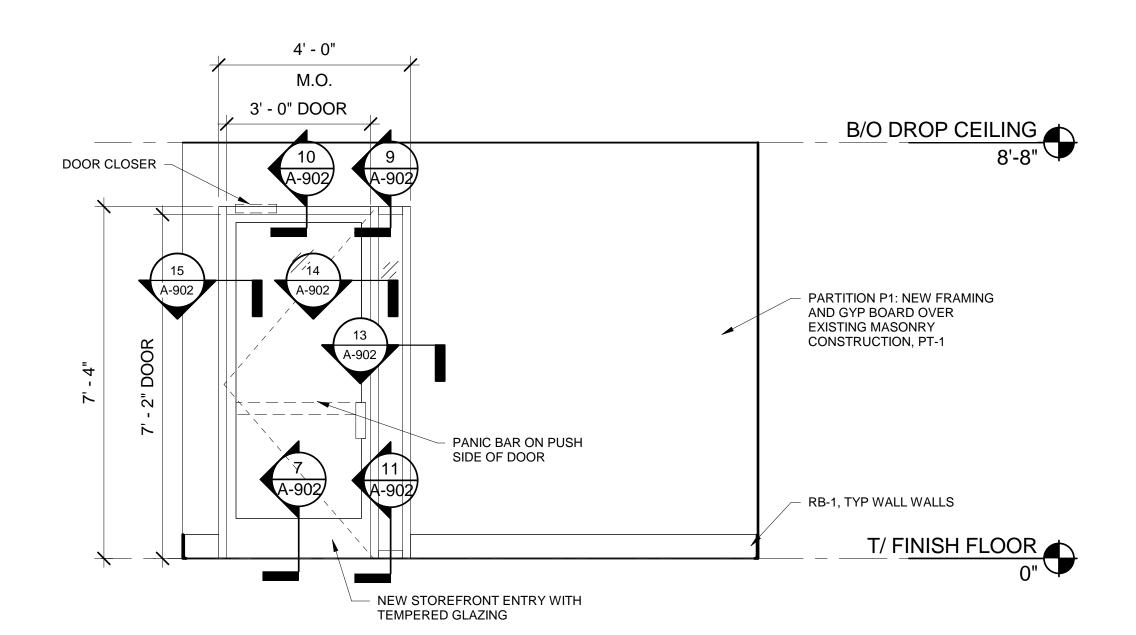
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3	ISSUED FOR 100% DESIGN	09/17/2018
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FIRST FLOOR REFLECTED CEILING PLAN

DRAWN: V.WIEGAND SHEET NO. CHECKED: K.KORAB A-801 DESIGNED: V.WIEGAND

JOB NO: 18-1006



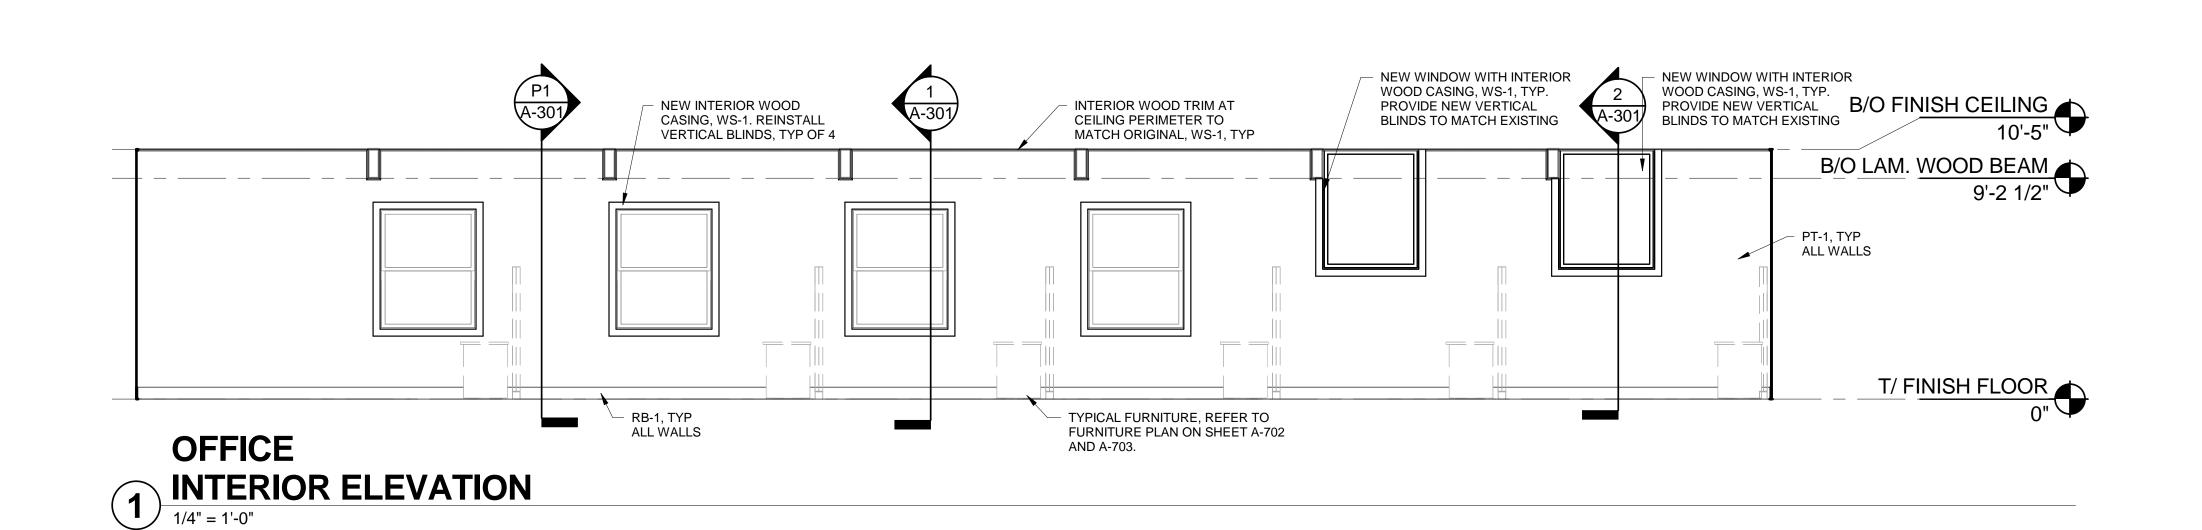

BREAK-OUT SPACE 2 INTERIOR ELEVATION

1/2" = 1'-0"



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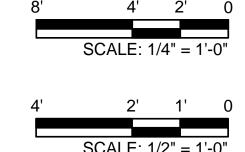
KANE COUNTY DEPARTMENT OF TRANSPORTATION OFFICE RENOVATION

Professional Seals


NOT FOR CONSTRUCTION

No.	Description	Date
1	ISSUED FOR 30% DESIGN	07/23/2018
2	ISSUED FOR 100% DESIGN	09/17/2018

INTERIOR ELEVATIONS





DRAWN: V.WIEGAND SHEET NO. CHECKED: K.KORAB DESIGNED: V.WIEGAND JOB NO: 18-1006

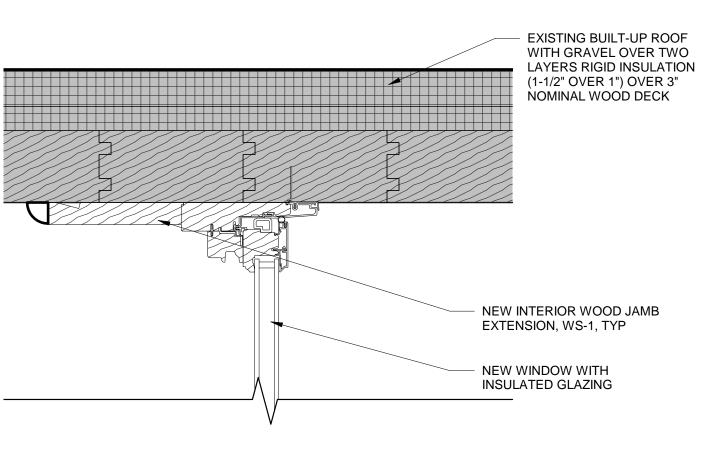


NEW FRAMING AND GYPSUM BOARD OVER **EXISTING WALL PARTITION EXISTING WALL** PARTITION NEW INTERIOR WOOD CASING AND JAMB EXTENSION, WS-1, TYP **EXISTING WINDOW** TO REMAIN **EXISTING MASONRY** WALL PARTITION BEYOND


GYPSUM BOARD ON METAL FRAMING UP TO DECK, PAINTED SEALANT AND BACKER ROD, TYP ALUMINUM STOREFRONT FRAMING GYP BD BEYOND **STOREFRONT**

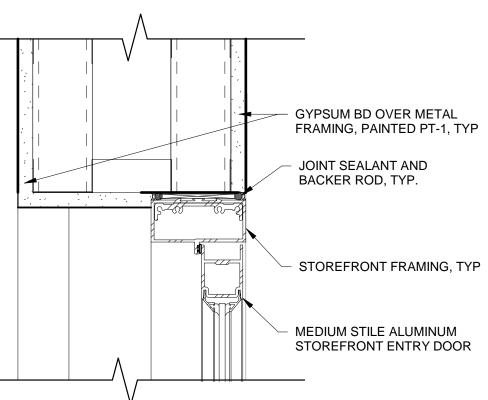


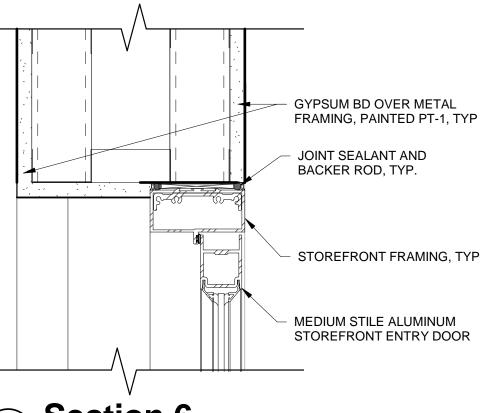

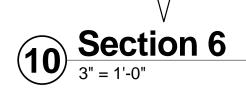


NEW WINDOW HEAD DETAIL

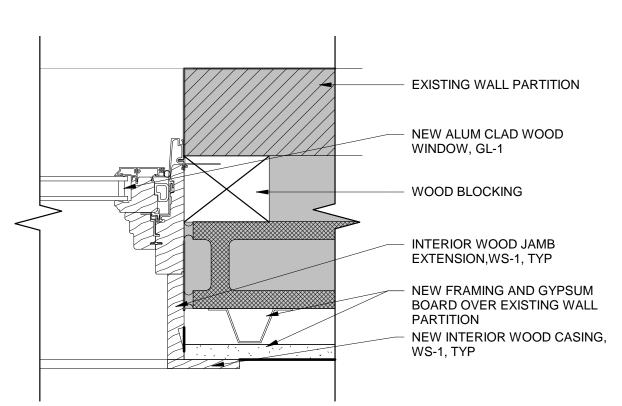


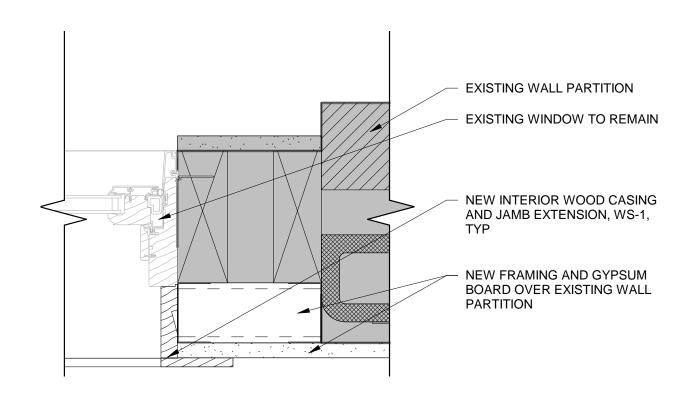


EXISTING WINDOW

HEAD DETAIL

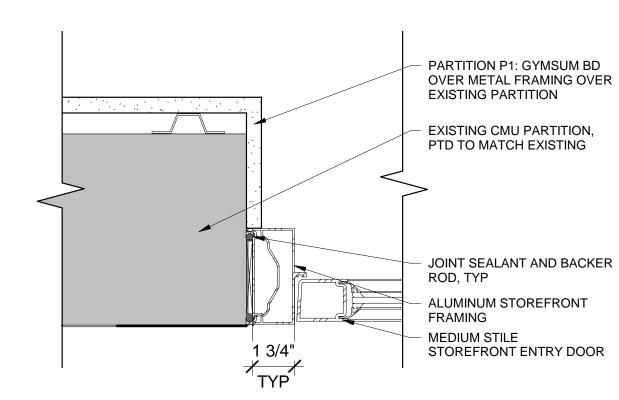


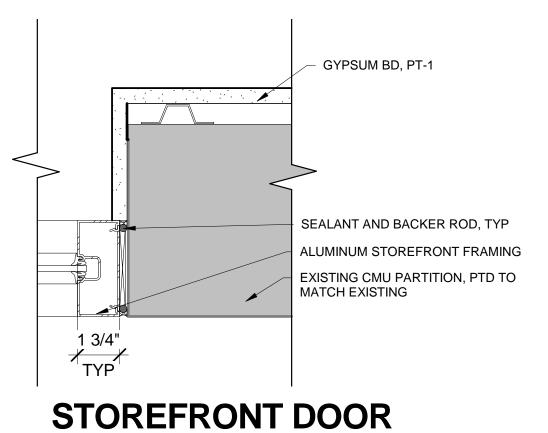

NEW WINDOW JAMB DETAIL

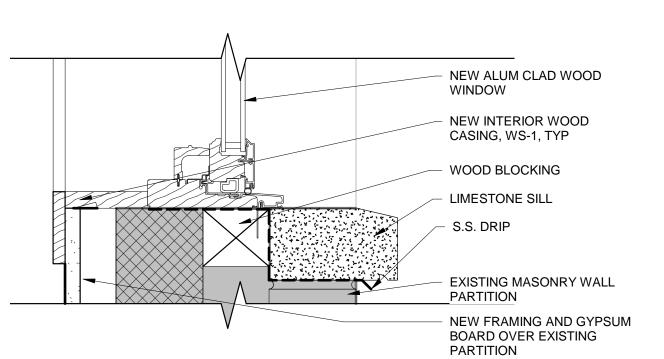

EXISTING WINDOW JAMB DETAIL

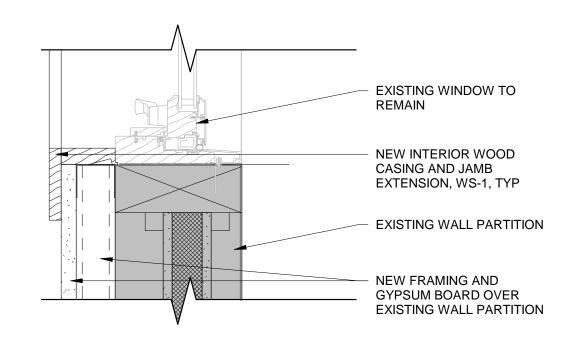


STOREFRONT JAMB DETAIL 3" = 1'-0"

STOREFRONT


11 SILL DETAIL
3" = 1'-0"

HEAD DETAIL

3" = 1'-0"

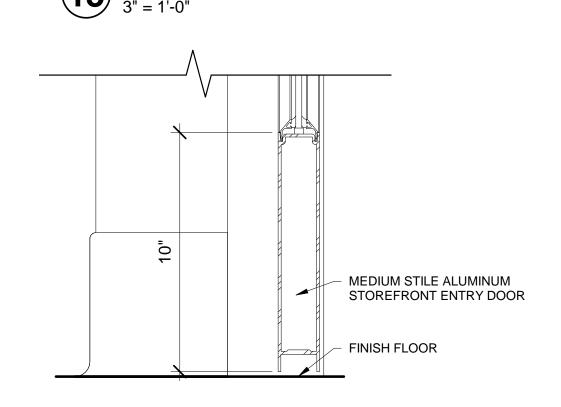

JAMB DETAIL

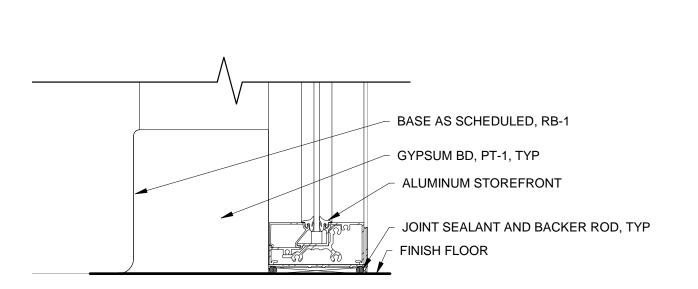


FRAMING

MEDIUM STILE

STOREFRONT ENTRY


STOREFRONT DOOR 7 SILL DETAIL
3" = 1'-0"

3 SILL DETIAL 3" = 1'-0"

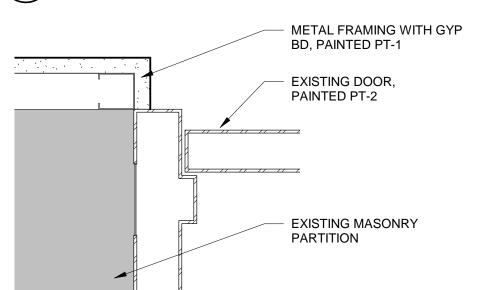

EXISTING DOOR

JAMB DETAIL

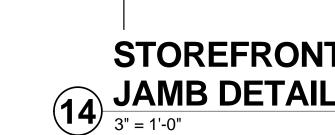

ALUMINUM STOREFRONT

STOREFRONT CENTER JAMB DETAIL

Description Date SSUED FOR 100% DESIGN 09/17/2018

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Chicago, IL 60642

WINDOW AND DOOR **DETAILS**

DRAWN: V.WIEGAND | SHEET NO. CHECKED: K.KORAB A-902 DESIGNED: V.WIEGAND

JOB NO: 18-1006

NEW WINDOW


EXISTING WINDOW SILL DETAIL

GENERAL NOTES

1. SEE SHEET E200 FOR THE NEW LIGHTING PLAN.

KEYNOTES (THIS SHEET)

- REMOVE AND DISPOSE OF EXISTING PENDANT HUNG FLUORESCENT LIGHT FIXTURES, LAMPS, STRUT SUPPORTS, CONDUITS AND CONDUCTORS. CONTRACTOR SHALL BE RESPONSIBLE FOR ALL DISPOSAL AND RECYCLING COSTS. REMOVE EXISTING LIGHTING CONDUCTORS. EXISTING CONCEALED CONDUITS SHALL BE ABANDONED IN PLACE. EXISTING CEILING JUNCTION BOXES MAY BE REUSED FOR SUPPORT POINTS ONLY. PROVIDE CANOPY COVERS, ARLINGTON #CP3540 OR EQUAL, AT ABANDONED JUNCTION BOXES.
- REMOVE AND DISPOSE OF EXISTING LIGHT SWITCHES, BOXES, CONDUITS AND WIRING. CONCEALED CONDUITS SHALL BE ABANDONED IN PLACE.
- 3. REMOVE AND DISPOSE OF EXISTING EXIT FIXTURES.

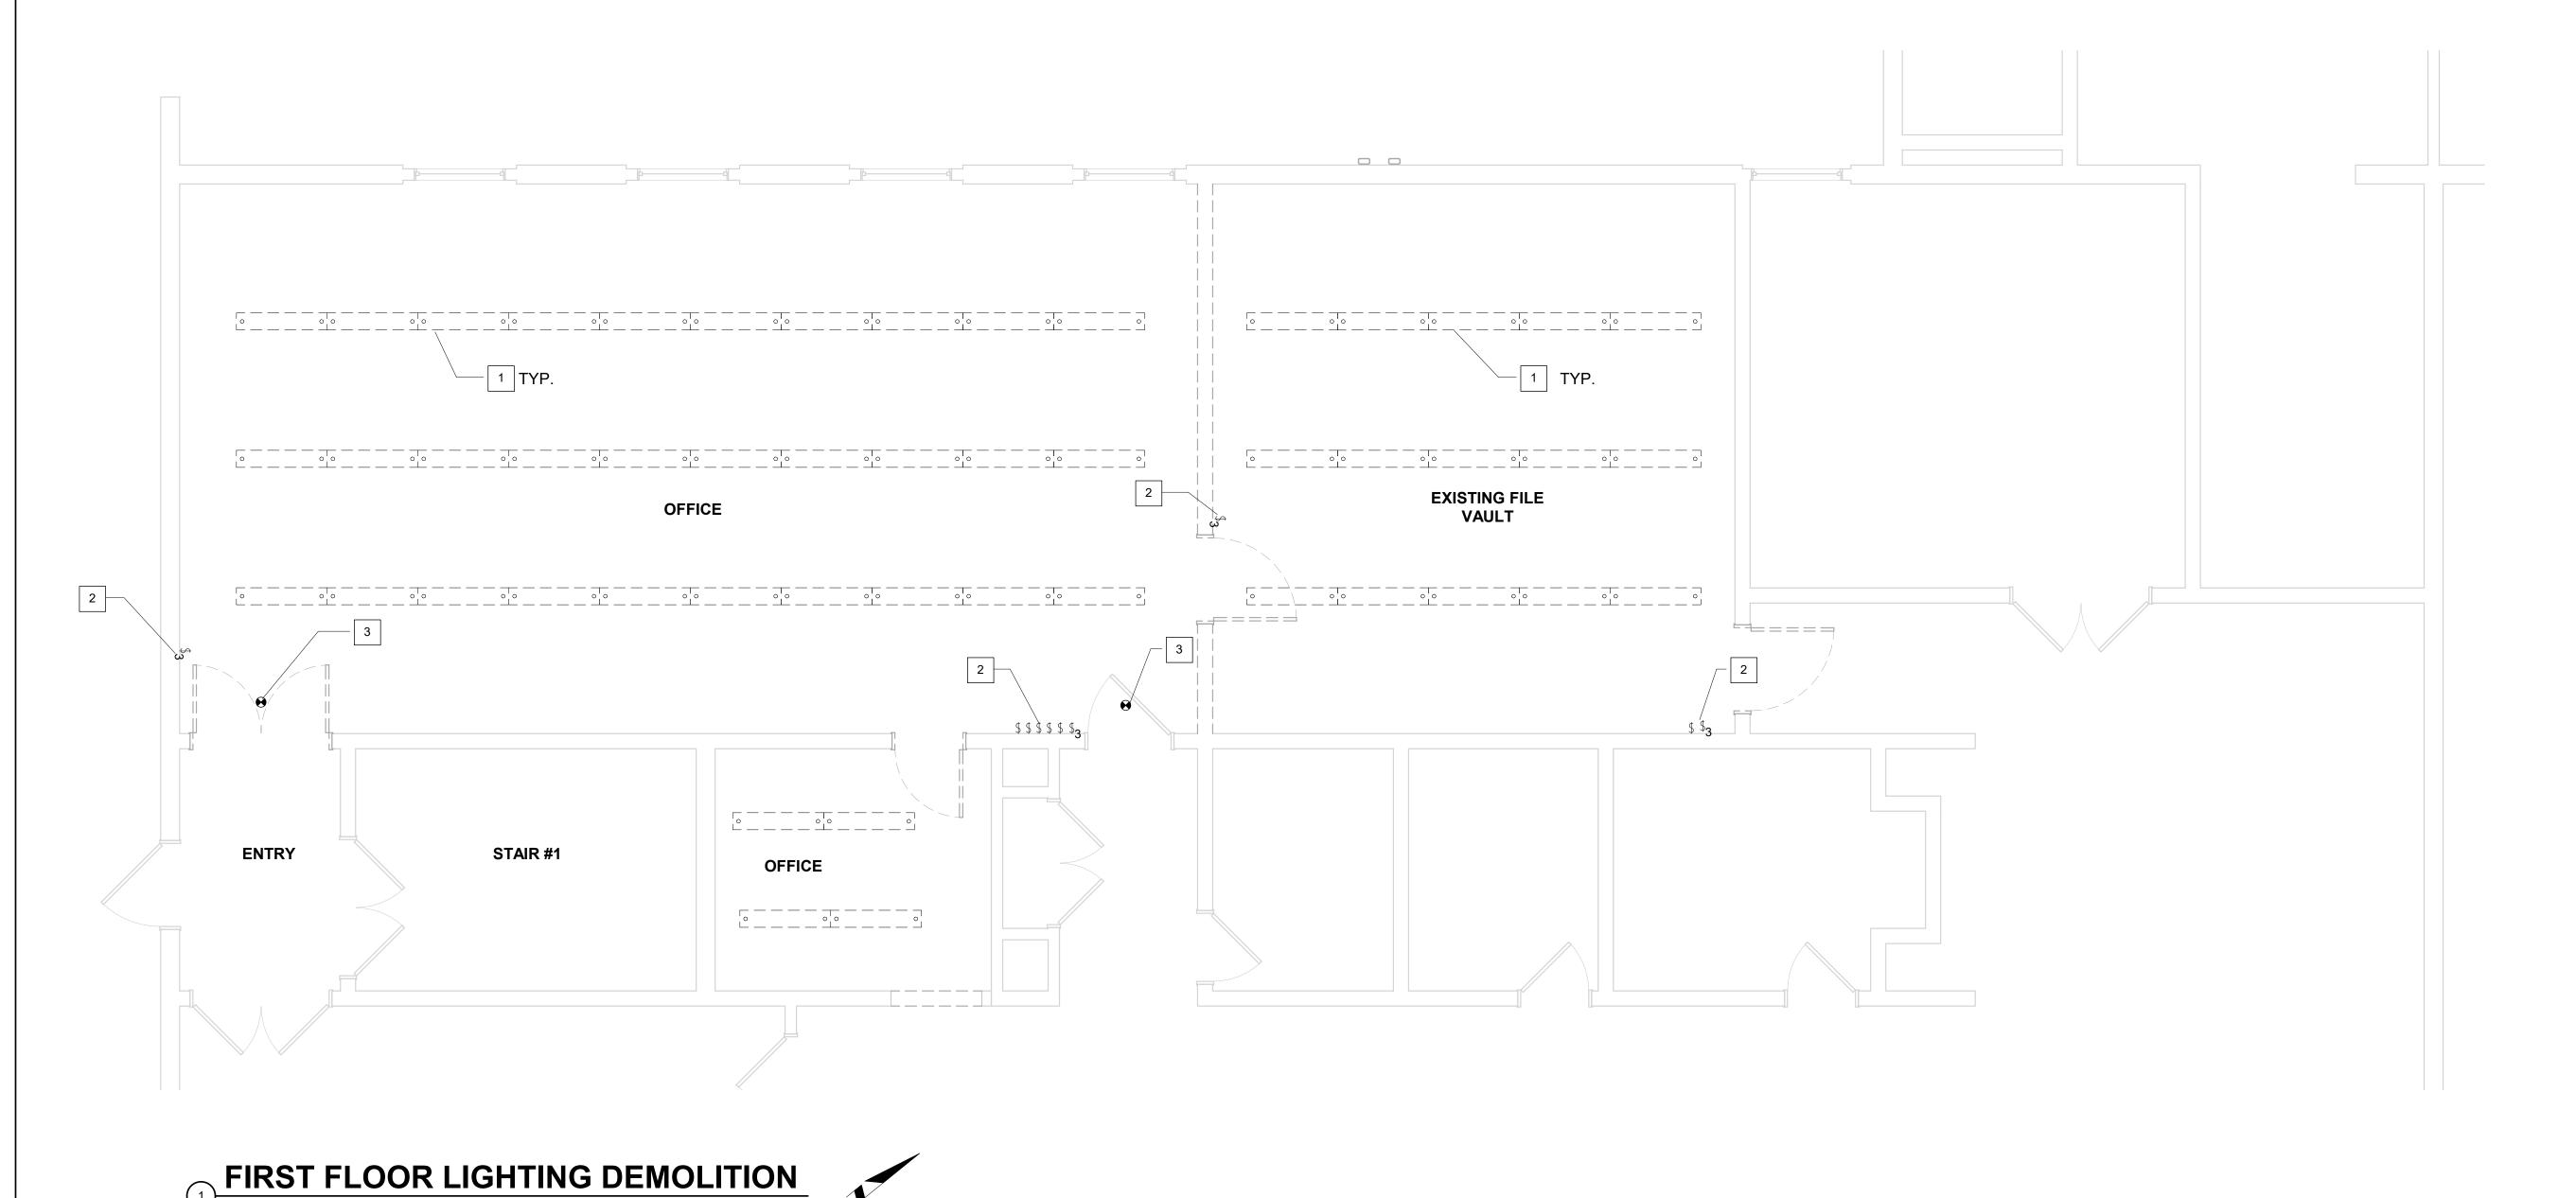



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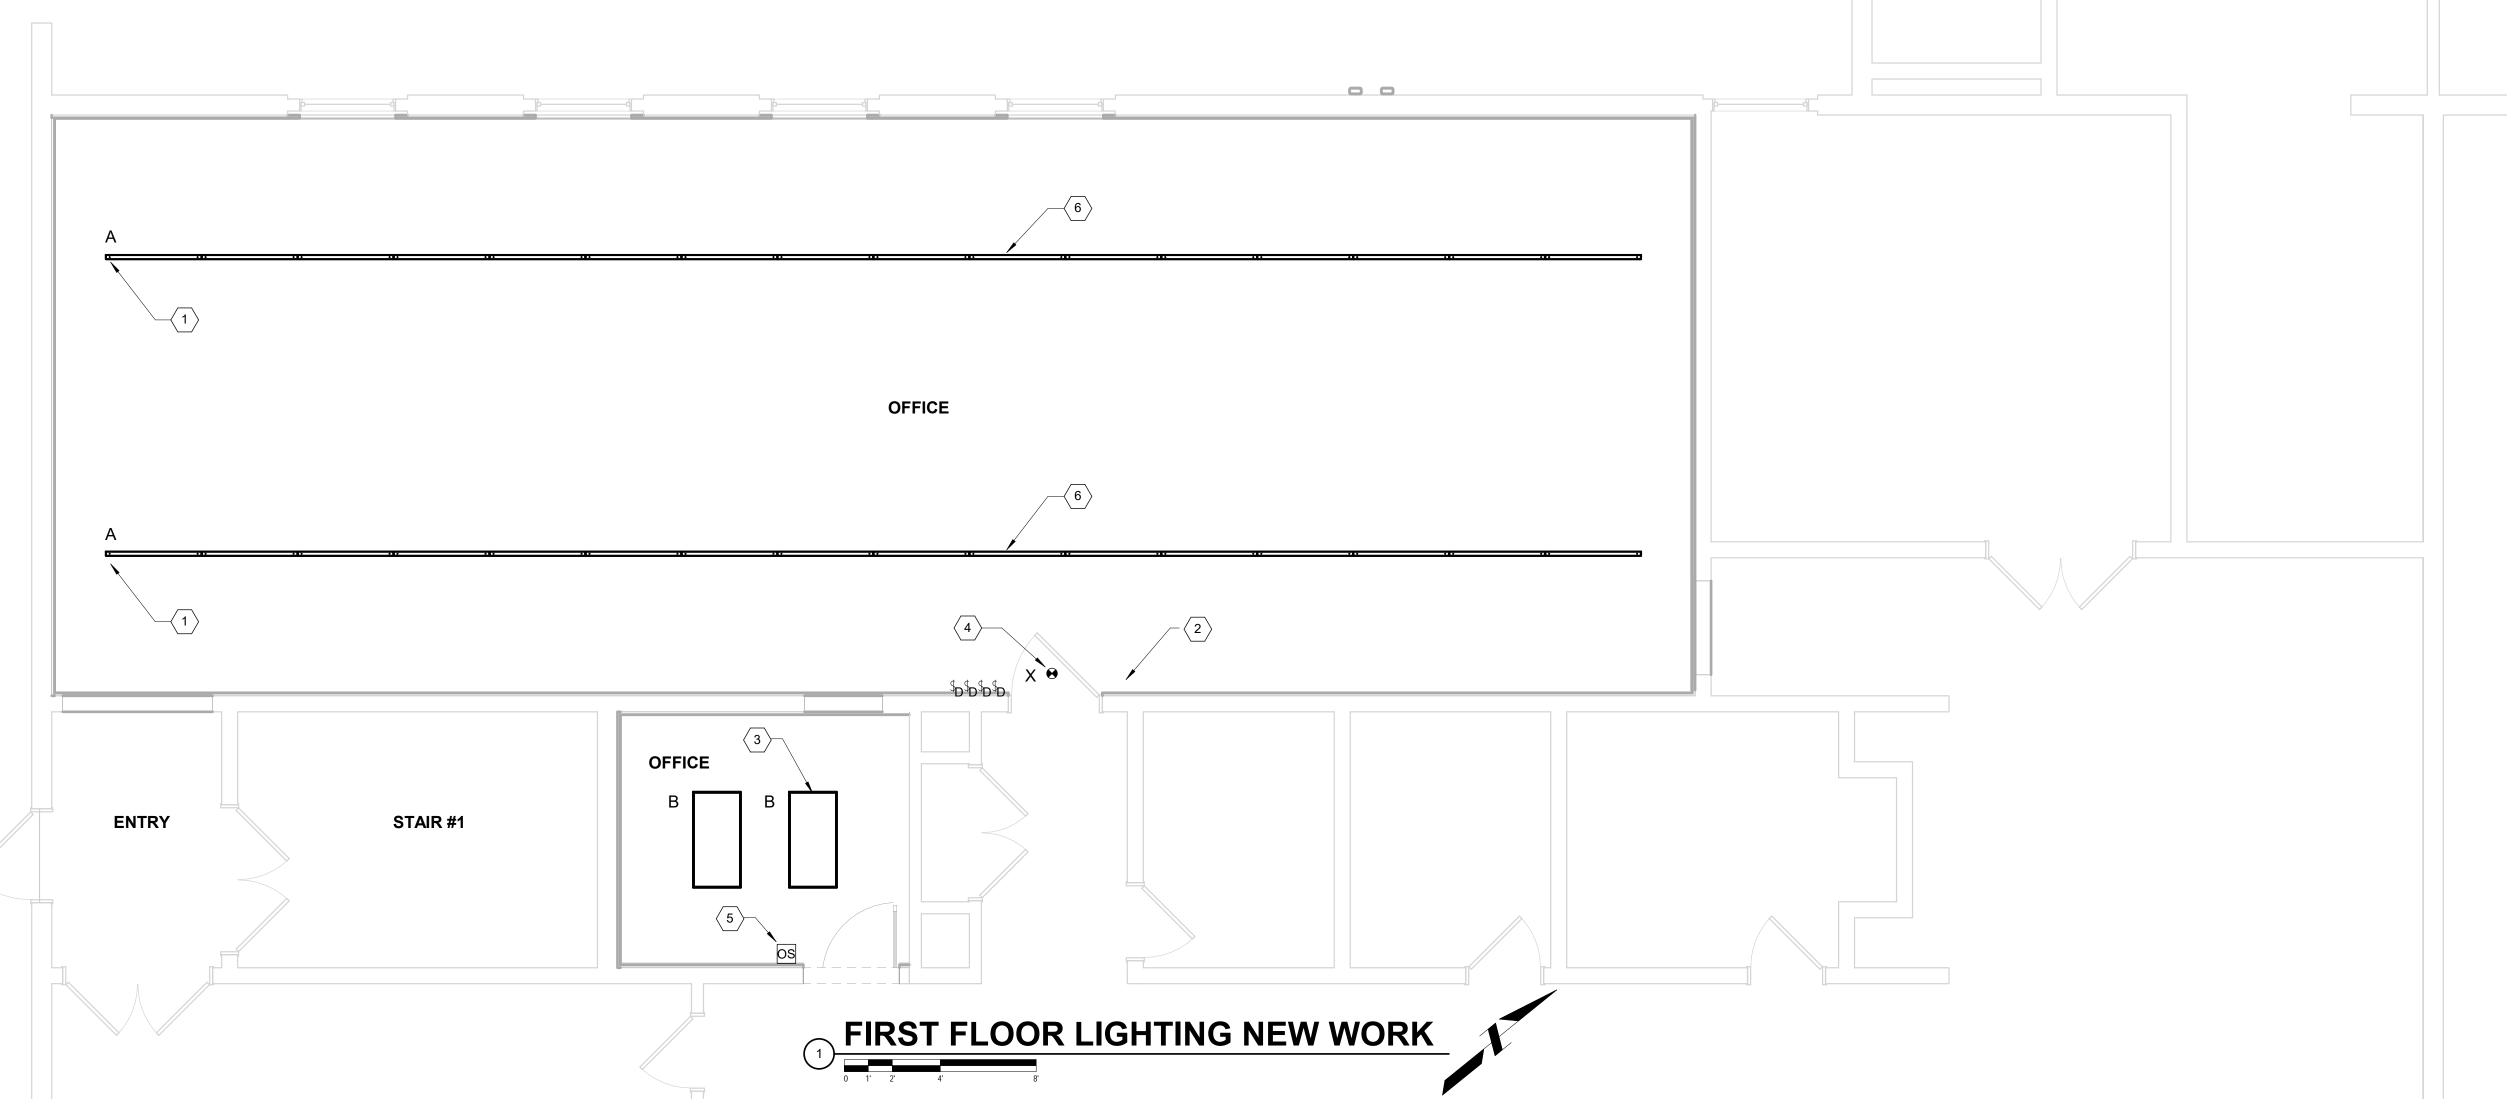
FIRST FLOOR LIGHTING DEMOLITION

DRAWN: PLZ	SHEET NO.
CHECKED: NTP	E400
DESIGNED: PLZ	E100
JOB NO: M160001	0

ALL SURFACE RACEWAY SHALL BE IVORY WIREMOLD 500 OR EQUAL.

KEYNOTES (THIS SHEET)

- PROVIDE NEW CABLE HUNG LIGHT FIXTURES. MOUNT FIXTURES 8'-8" ABOVE FINISHED FLOOR TO BOTTOM OF FIXTURE. SEE FIXTURE SCHEDULE. PROVIDE NEW FEED POINTS AT THE PLAN EAST END OF EACH RUN. PROVIDE NEW CONDUIT AND WIRE TO THE NEW SWITCHES INDICATED BELOW. ALL POWER AND CONTROL CABLING SHALL BE INSTALLED IN CONDUIT. NO FREE AIR CABLING SHALL BE ALLOWED. CONCEAL AS MUCH CONDUIT AS POSSIBLE IN THE NEW 1-1/2" STUD WALLS. PROVIDE SURFACE RACEWAY ROUTED ALONG THE EXPOSED BEAMS FROM THE PLAN SOUTH WALL TO THE FIXTURE FEED POINTS. NEW SURFACE RACEWAY AT THE BEAM SHALL BE MOUNTED MINIMUM 1-1/2" BELOW THE CEILING DECK IN ACCORDANCE WITH NEC 300.4(E). PROVIDE JUNCTION BOX WITH FLEXIBLE WHIP TO FIXTURE AT BEAM.
- PROVIDE NEW COMBINATION SWITCH/DIMMERS FOR CONTROL OF NEW LIGHTING AS FOLLOWS:
 - (2) LUTRON #DVSTV-WH OR EQUAL SINGLE POLE SWITCH WITH 0-10V SLIDE DIMMER NEAR DOOR FOR CONTROL OF THE FIRST ROW OF LIGHT FIXTURES INSIDE THE DOOR. (2) LUTRON #DVSTV-WH OR EQUAL SINGLE POLE SWITCH WITH 0-10V SLIDE DIMMER ADJACENT TO PART A DIMMER FOR CONTROL OF THE ROW OF LIGHT FIXTURES CLOSEST TO THE
- PROVIDE NEW RECESSED LIGHT FIXTURES. SEE FIXTURE SCHEDULE.
- PROVIDE NEW EXIT FIXTURE. SEE FIXTURE SCHEDULE.
- PROVIDE NEW WALL MOUNT OCCUPANCY SENSOR WITH DIMMER, LUTRON #MS-Z101-V-WH OR EQUAL.
- BATTERY BACKED UP SECTION OF LIGHT FIXTURE. PROVIDE WIRING PER MANUFACTURERS INSTRUCTIONS.



TYPE MANUFACTURER CATALOG NUMBER TYPE MANUFACTURER FP-2ID-64'-S-H-835-TG-F-96LG-120V-DC-FA-FE-C4 FINELITE FP-2ID-64'-S-H-835-TG-F-96LG-120V-DC-FA-FE-C4 FINELITE FINELITE	PS BALLASTS BALLASTS				LAMPS	[UMINAIRE
LED NA - 27 WATTS DIMMING DRIVER - 120V RECESSED LED SEPARATE DIMMABLE CONTROL FOR DOWNLIGHT AND UPLIGHT FINELITE HPR-LED-F-2X4-DCO-S-835-120V-SC-C1 LED NA - 27 WATTS DIMMING DRIVER - 120V RECESSED LED SEPARATE DIMMABLE CONTROL FOR DOWNLIGHT AND UPLIGHT 27 WATTS DIMMING DRIVER - 120V RECESSED LED HIGH PERFORMANCE FLAT LENS DIMMABLE SURELITES APX7R WHITE PLASTIC EXIT SIGN WITH RED LETTERS	CATALOG # NO. WATTS/LAMP TYPE NO. VOLT MOUNT DESCRIPTION	ATTS/LA	NO. \	CATALOG#	TYPE	1	CATALOG NUMBER	YPE MANUFACTURER
FINELITE HPR-LED-F-2X4-DCO-S-835-120V-SC-C1 LED NA - 27 WATTS DIMMING DRIVER - 120V RECESSED GRID CEILING SEPARATE DIMMABLE CONTROL FOR DOWNLIGHT AND UPLIGHT 2'X4' RECESSED GRID CEILING LED HIGH PERFORMANCE FLAT LENS DIMMABLE SURELITES APX7R WHITE PLASTIC EXIT SIGN WITH RED LETTERS		WATTS	_ 2	NA	LED		FP-2ID-64'-S-H-835-TG-F-96LG-120V-DC-FA-FE-C4	FINELITE
LED NA - 27 WATTS DIMMING DRIVER - 120V RECESSED LED HIGH PERFORMANCE FLAT LENS DIMMABLE SURELITES APX7R DIMMABLE SURDITION OF THE PLASTIC EXIT SIGN WITH RED LETTERS	SEPARATE DIMMABLE CONTROL FOR DOWNLIGHT AND UPLIGHT			177				
SURELITES APX7R DIMMABLE WHITE PLASTIC EXIT SIGN WITH RED LETTERS					╡		HPR-LED-F-2X4-DCO-S-835-120V-SC-C1	FINELITE
		WATTS	- 2	NA	LED	L		
LED NA99 WATTS STANDARD DRIVER - 120V WALL LED							APX7R	SURELITES
	NA99 WATTS STANDARD DRIVER - 120V WALL LED	WATTS		NA	LED	L		

ABBREVIATIONS:

F - FLUORESCENT

I - INCANDESCENT

PS - PULSE START

REFER TO LIGHTING PLAN FOR MOUNTING HEIGHT.

H - HIGH INTENSITY DISCHARGE EOL - END OF LIFE PROTECTION

E - ELECTRONIC HIGH FREQUENCY S - STANDARD ENERGY-SAVING MAGNETIC

O - OTHER (SEE NOTES) SCWA - SUPER CONSTANT WATTAGE AUTO TRANSFORMER L - LED

WU - WITH UNIT EX - EXISTING NA - NOT AVAILABLE

EP - ELECTRONIC PROGRAMMED RAPID START

UNV - UNIVERSAL VOLTAGE 120/277

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FIRST FLOOR LIGHTING PLANS


DRAWN: PLZ SHEET NO. CHECKED: NTP E200 DESIGNED: PLZ JOB NO: M1600010

GENERAL NOTES

SEE SHEET E-401 FOR FIRST FLOOR POWER AND SYSTEMS NEW WORK PLAN.

KEYNOTES (THIS SHEET)

- 1. REMOVE EXISTING RECEPTACLE RECESSED IN BLOCK WALL AND WIRING AS FOLLOWS:
 - A. REMOVE WIRE BACK TO SOURCE IF ALL RECEPTACLES ON THE CIRCUIT ARE REMOVED. REMOVE ASSOCIATED CONDUIT AND BOXES.
 - B. REMOVE WIRE BACK TO NEAREST JUNCTION BOX IF CIRCUIT SERVES RECEPTACLES TO REMAIN. REMOVE ASSOCIATED CONDUIT AND BOXES.
 - C. IN THE EVENT THAT THE CIRCUIT EXTENDS TO OTHER RECEPTACLES THROUGH THE RECEPTACLE JUNCTION BOX, PROVIDE SPLICES AS REQUIRED TO MAINTAIN EXISTING TO REMAIN RECEPTACLES. PROVIDE BLANK COVER AT BOX TO REMAIN.
- 2. EXISTING RECEPTACLE SERVING BUILDING AUDIO SYSTEM. AUDIO SYSTEM AND SHELF TO REMAIN. REMOVE EXISTING SURFACE MOUNT RACEWAY CONTAINING SPEAKER WIRING. PROTECT SPEAKER WIRING DURING CONSTRUCTION. REMOVE SHELF AND PROTECT FOR REUSE. AUDIO SYSTEM SHALL REMAIN IN SERVICE DURING CONSTRUCTION. PROVIDE TEMPORARY POWER AND TEMPORARY SUPPORTS AS REQUIRED TO MAINTAIN SYSTEM DURING CONSTRUCTION. PROVIDE PLASTIC SHEETING TO PROTECT EQUIPMENT FROM CONSTRUCTION DUST. PLASTIC SHEETING SHALL BE INSTALLED IN A MANNER THAT ALLOWS VENTILATION FOR EQUIPMENT. SEE SHEET E401 FOR ADDITIONAL INFORMATION.
- 3. DISCONNECT EXISTING SMOKE DETECTOR. PROTECT AND STORE DETECTOR FOR REUSE. PROTECT EXISTING WIRING AND SURFACE MOUNT RACEWAY. PROVIDE CONNECTIONS TO MAINTAIN SYSTEM FUNCTIONALITY DURING CONSTRUCTION.
- 4. DISCONNECT EXISTING SMOKE DETECTOR. REMOVE EXISTING WIRING AND SURFACE MOUNT RACEWAY TO ACCOMODATE CEILING REMOVAL. PROVIDE CONNECTIONS AND WIRING TO MAINTAIN SYSTEM FUNCTIONALITY DURING CONSTRUCTION.
- 5. DISCONNECT EXISTING FIRE ALARM HORN. PROTECT AND STORE DEVICE FOR REUSE. REMOVE EXISTING WIRING AND SURFACE MOUNT RACEWAY. PROVIDE CONNECTIONS TO MAINTAIN SYSTEM FUNCTIONALITY DURING CONSTRUCTION.
- 6. REMOVE EXISTING FLOOR MOUNTED MAGNETIC DOOR HOLD, CONDUIT AND WIRE BACK TO SOURCE.
- 7. REMOVE EXISTING FLEXIBLE WHIP SERVING FURNITURE WALLS THROUGH THE FLOOR BACK TO JUNCTION BOX BELOW. CAP CIRCUITS AT JUNCTION BOX. MARK JUNCTION BOX WITH CIRCUIT NUMBER.
- 8. REMOVE EXISTING SURFACE MOUNT DATA BOX AND CONDUIT FED THROUGH THE FLOOR. PULL EXISTING DATA CABLES BACK BELOW FLOOR, COIL AND SUPPORT AT THE CEILING BELOW. MARK CABLES WITH ANY IDENTIFIERS SHOWN ON DATA PLATE.
- 9. REMOVE EXISTING RECEPTACLE AND RACEWAY TO ALLOW WALL REMOVAL. PROVIDE CONDUIT, CONDUCTORS, JUNCTION BOXES AND SPLICES AS REQUIRED TO MAINTAIN CIRCUIT IF NECESSARY.

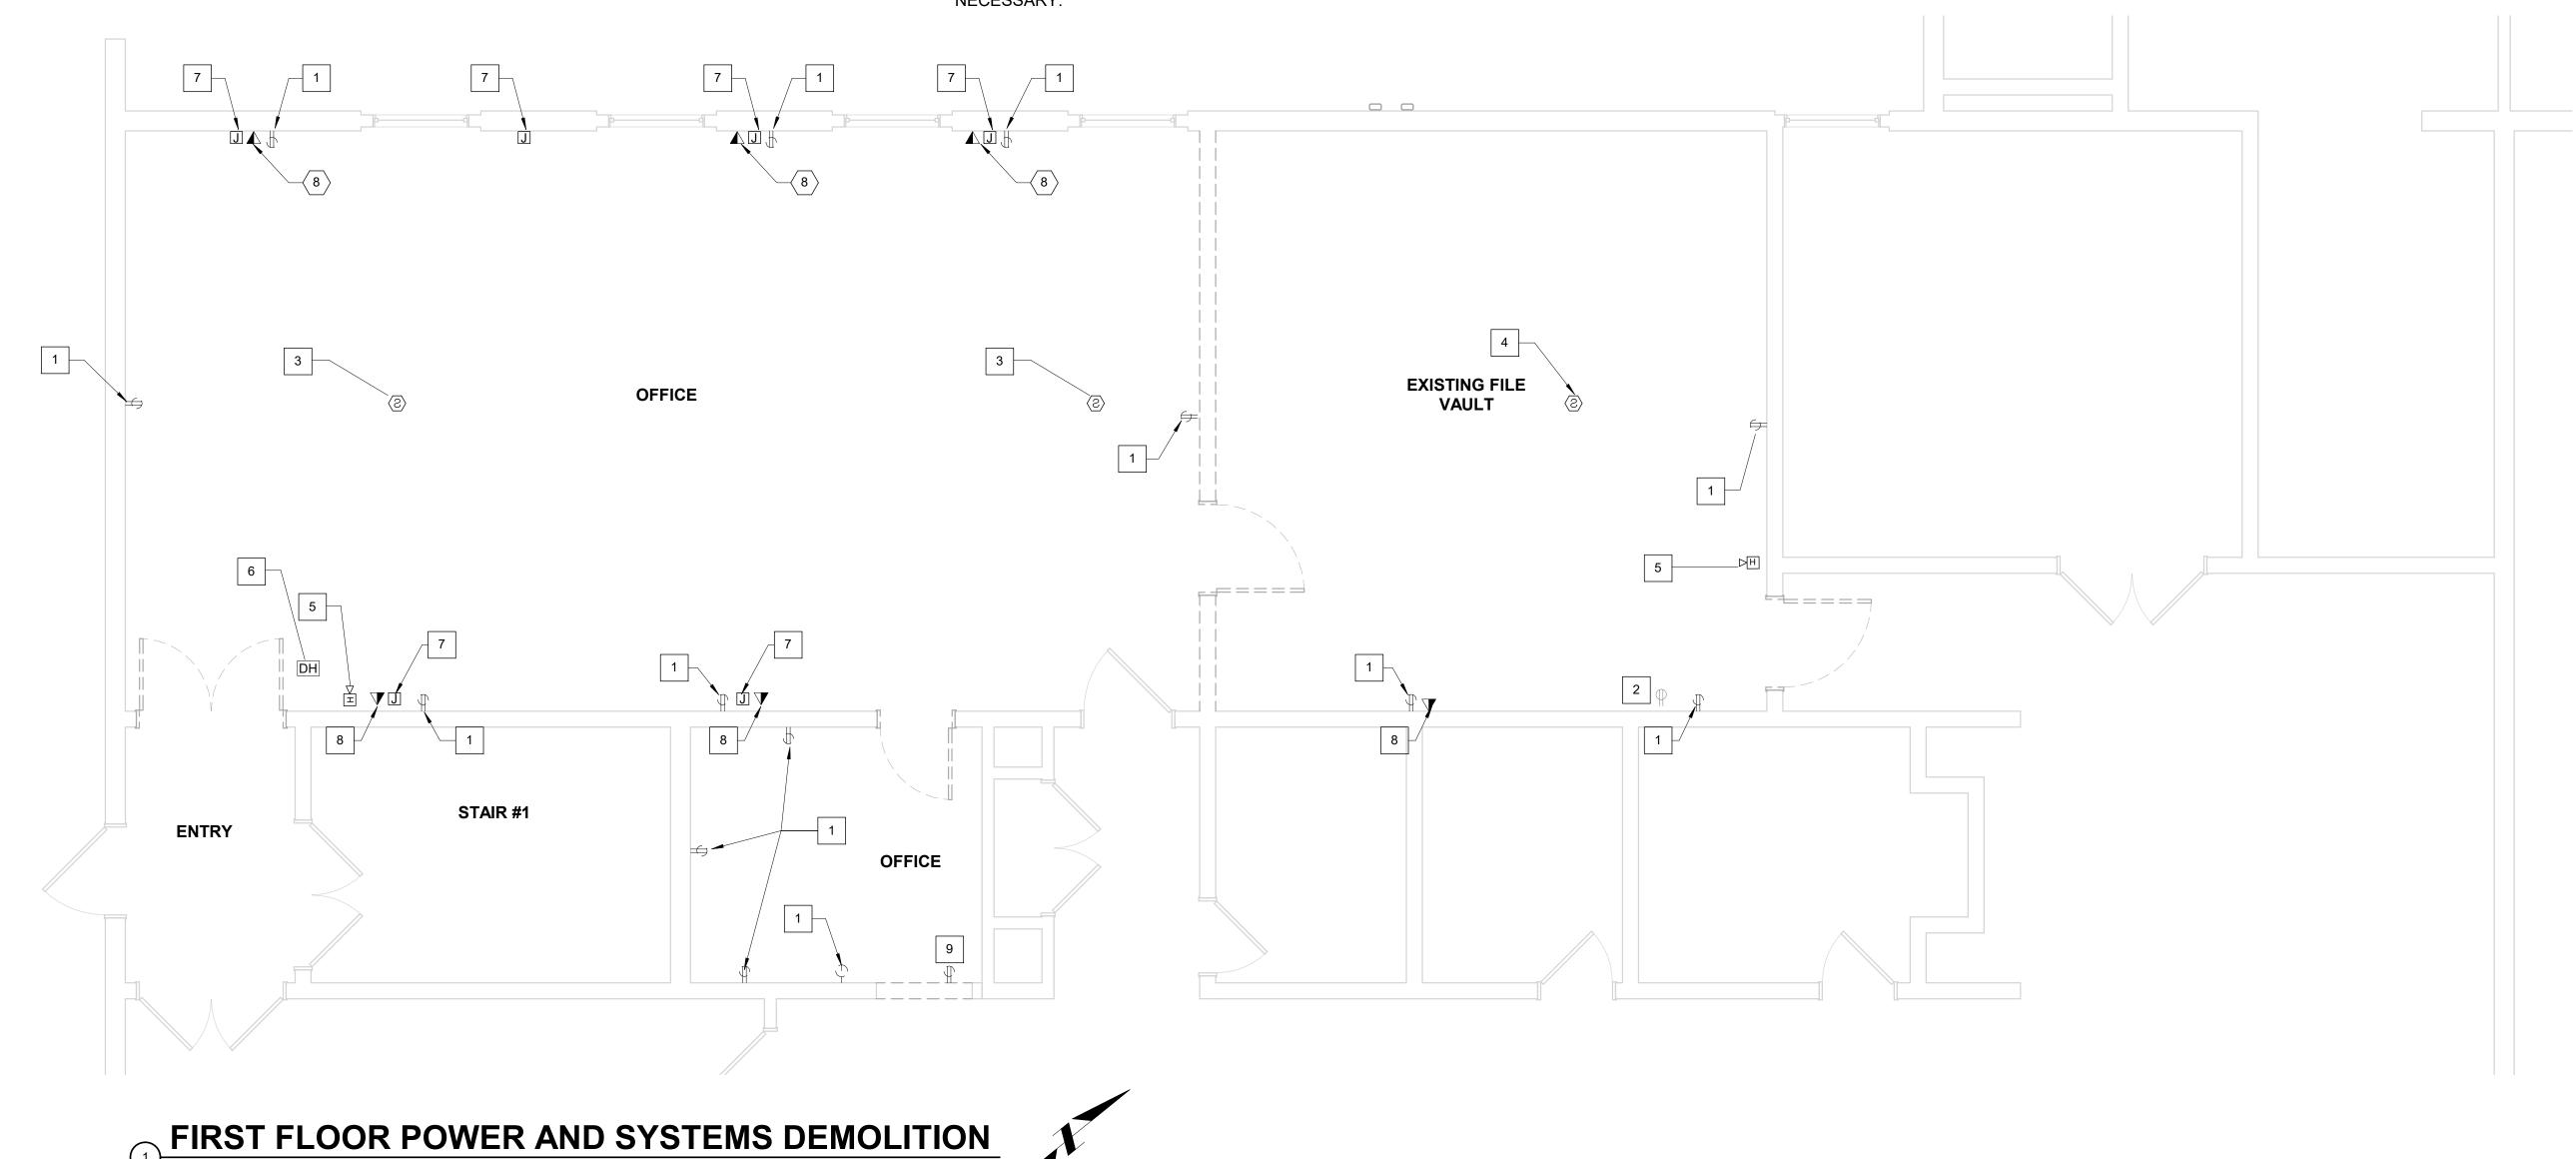



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FIRST FLOOR POWER AND SYSTEMS DEMOLITION

DRAWN: PLZ	SHEET NO.
CHECKED: NTP	E300
DESIGNED: PLZ	E300
JOB NO: M1600010	



GENERAL NOTES

SEE SHEET E-401 FOR FIRST FLOOR POWER AND SYSTEMS NEW WORK PLAN.

KEYNOTES (THIS SHEET)

- EXISTING PANEL MDP.
- EXISTING PANEL RPA.
- EXISTING PANEL RPIG.
- PROJECT AREA LOCATED ON FIRST FLOOR ABOVE THIS ROOM. STORAGE AREA HAS EXPOSED CEILING. ROUTE ALL NEW CONDUITS IN THIS EXPOSED CEILING AND UP THROUGH FLOOR TO LOCATIONS SHOWN.

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LOWER LEVEL ELECTRICAL POWER AND SYSTEMS

DRAWN: PLZ CHECKED: NTP E400 DESIGNED: PLZ JOB NO: M1600010

- 2. CIRCUIT NUMBERS ARE SHOWN TO INDICATE NUMBER OF CIRCUITS REQUIRED. EXISTING CIRCUITS MADE AVAILABLE DURING THE DEMOLITION PHASE MAY BE REUSED, PROVIDE NEW CIRCUITS FROM THE ELECTRICAL ROOM SHOWN ON SHEET E-400 FOR ADDITIONAL REQUIRED CIRCUITS. RECORD ACTUAL CIRCUIT NUMBERS ON AS BUILT DRAWINGS. UPDATE PANELBOARD DIRECTORIES.
- 3. EXISTING FIRE ALARM SYSTEM IS A NOTIFIER FIRE ALARM SYSTEM SERVICED BY ALARM DETECTION SYSTEMS 630.844.6300. FIRE ALARM SYSTEM SHALL BE TESTED AND CERTIFIED BY A MANUFACTURERS REPRESENTATIVE. CERTIFICATION FEES SHALL BE INCLUDED IN THE BID FOR THIS WORK.
- 4. ALL SURFACE RACEWAY SHALL BE IVORY WIREMOLD 500 OR EQUAL.
- 5. ALL WALL MOUNTED DEVICES SHALL HAVE BOXES RECESSED IN THE FURRING WALL AND CONDUITS ROUTED DOWN THROUGH THE FLOOR TO THE EXPOSED CEILING BELOW.

KEYNOTES (THIS SHEET)

- 1. PROVIDE NEW JUNCTION BOX WITH FLEXIBLE WHIP CONNECTION TO POWERED FURNITURE PANELS. COORDINATE ROUGH IN LOCATION WITH FURNITURE SHOP DRAWINGS. JUNCTION BOX SHALL BE INSTALLED IN NEW 1-1/2" FURRING WALL AND CONDUIT SHALL BE ROUTED THROUGH FLOOR TO THE CEILING SPACE BELOW.
- 2. PROVIDE NEW VOICE/DATA ROUGH IN CONSISTING OF 4" SQUARE BOX WITH 1" CONDUIT BEHIND FURRED WALLS STUBBED DOWN TO ACCESSIBLE CEILING SPACE BELOW. COORDINATE ROUGH IN LOCATION WITH FURNITURE SHOP DRAWINGS.
- 3. REINSTALL EXISTING SMOKE DETECTORS AND PROVIDE NEW SMOKE DETECTORS AS REQUIRED TO PROVIDE COVERAGE SHOWN. PROVIDE SURFACE RACEWAY AND WIRE AS REQUIRED TO EXTEND EXISTING WIRING TO NEW LOCATION. SURFACE RACEWAY SHALL BE ROUTED NORTH TO SOUTH ALONG THE SIDE OF THE BEAMS MINIMUM 1-1/2" BELOW DECK UNTIL TRANSITIONING TO EACH SMOKE DETECTOR. SMOKE DETECTORS SHALL BE MOUNTED TO THE BOTTOM OF THE DECK CENTERED IN THE BEAM CAVITY.
- PROVIDE NEW FIRE ALARM HORN/STROBE. PROVIDE CONDUIT AND WIRE AS REQUIRED TO EXTEND EXISTING WIRING TO NEW LOCATION. CONDUIT AND WIRE SHALL BE ROUTED DOWN THROUGH THE FLOOR TO THE CEILING SPACE BELOW.
- PROVIDE RECEPTACLE FOR BUILDING AUDIO EQUIPMENT. INSTALL OUTLET AT SAME HEIGHT AS EXISTING REMOVED OUTLET. REUSE EXISTING CIRCUIT. REINSTALL EXISTING SHELF AND EXISTING AUDIO EQUIPMENT REINSTALL EXISTING SURFACE RACEWAY TO CONCEAL EXISTING SPEAKER WIRING. RECONNECT EXISTING SPEAKER WIRING.
- 5. PROVIDE NEW FIRE ALARM STROBE. PROVIDE CONDUIT AND WIRE AS REQUIRED TO EXTEND WIRING TO NEW LOCATION.
- PROVIDE NEW DUPLEX RECEPTACLE FOR MINI FRIDGE. COORDINATE LOCATION WITH OWNER.
- 8. PROVIDE NEW DUPLEX RECEPTACLE FOR COFFEE MACHINE. COORDINATE LOCATION WITH OWNER.



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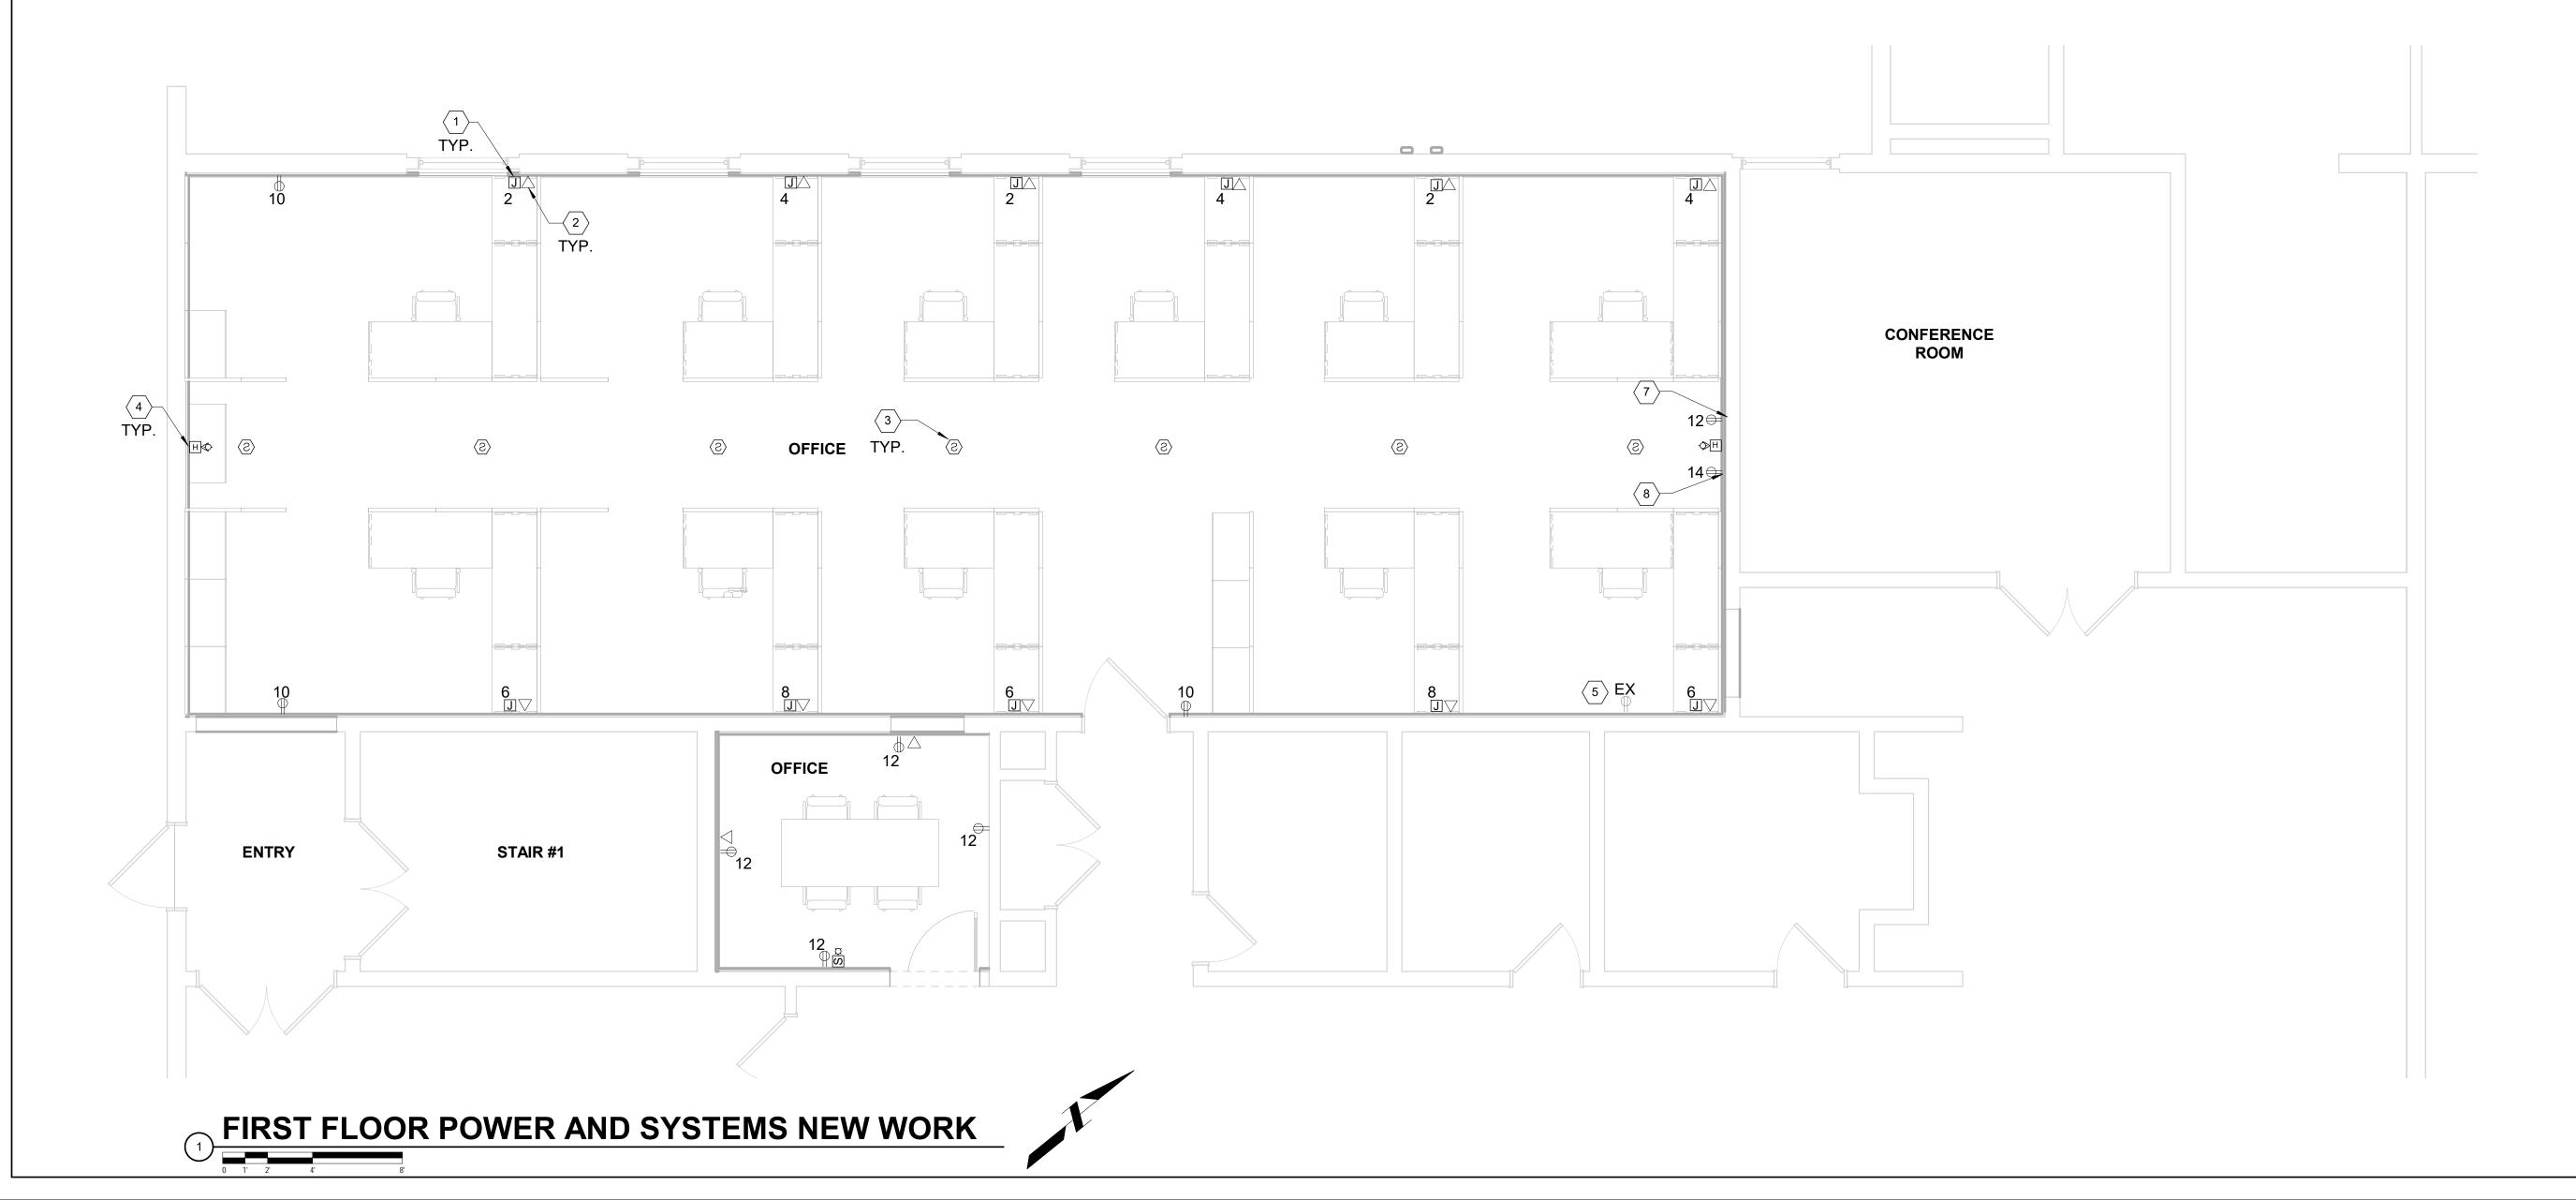
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JOB NO: M1600010



(WITH HARD DUCT)

(WITH FLEXDUCT)

ROUND DUCTWORK

FLAT OVAL DUCTWORK

FLEXIBLE DUCTWORK

24/24

XØ Ż

X/X Ø

EXHAUST GRILLE OR REGISTER

ARE INSIDE CLEAR DIMENSIONS

RECTANGULAR DUCT (FIRST FIGURE IS

SIDE SHOWN) ALL DUCT DIMENSIONS

<u>SYMBOL</u>

DESCRIPTION

90° ELBOW WITH TURNING VANES

BRANCH DUCT TAP

____ :

ACCESS DOOR (HORIZONTAL/VERTICAL)

MOTORIZED DAMPER

TRANSITION FROM RECTANGULAR TO ROUND DUCT

FLEXIBLE DUCT CONNECTION TO EQUIPMENT

TO BE REMOVED

XX-X

THERMOSTAT W/EQUIPMENT NUMBER

ROOF MOUNTED EXHAUST FAN W/ EQUIPMENT NUMBER



DIRECTION OF AIRFLOW

HEATING/VENTILATION ABBREVIATIONS

SUPPLY AIR RA **RETURN AIR** EΑ EXHAUST AIR **OUTDOOR AIR** OA CUBIC FEET PER MINUTE

INTAKE LOUVER **RELIEF LOUVER** MBTU THOUSAND BRITISH THERMAL UNITS PER HOUR

FIRE DAMPER NOISE CRITERIA

GENERAL HEATING/VENTILATION NOTES

- DUCTWORK AND PIPING IS SHOWN IN SCHEMATIC FORM ONLY, OFFSETS AND CHANGES IN ELEVATION ARE NOT NECESSARILY SHOWN. ROUTE DUCTWORK AND PIPING IN AN ORDERLY MANNER AS REQUIRED FOR CLEARANCE WITH STRUCTURAL CONDITIONS. COORDINATE LOCATION OF DUCTWORK AND PIPING WITH OTHER TRADES PRIOR TO INSTALLATION. WHERE POSSIBLE RACK PIPING HORIZONTALLY AND VERTICALLY.
- COORDINATE LOCATIONS AND SIZES OF DUCT CONNECTIONS AND PIPING CONNECTIONS TO EQUIPMENT BEING PROVIDED BY OTHERS.
- PROVIDE AND INSTALL MANUAL BALANCING DAMPERS IN ALL BRANCH DUCTWORK AND AT EACH AIR INLET AND OUTLET.
- LOCATE ALL MANUAL BALANCING DAMPERS IN AN ACCESSIBLE LOCATION. WHERE DAMPERS ARE NOT ACCESSIBLE PROVIDE A MINIMUM 18X18 ACCESS
- UNLESS OTHERWISE NOTED, CONCEAL ALL DUCTWORK AND PIPING ABOVE CEILINGS, IN WALLS, OR INSIDE CHASES.
- CONTRACTOR SHALL BE RESPONSIBLE FOR PROVIDING ADEQUATE SUPPORTING SYSTEMS AND DEVICES FOR ALL DUCTWORK, EQUIPMENT, PIPING AND
- PROVIDE AND INSTALL SLEEVES FOR ALL DUCTWORK AND PIPING PASSING THROUGH WALLS AND FLOORS.
- FOR DUCT CONNECTIONS TO TERMINAL DEVICES, FANS, AND OTHER EQUIPMENT SEE MECHANICAL DETAILS.
- COORDINATE LOCATIONS OF ALL DIFFUSERS, GRILLES, AND REGISTERS WITH ARCHITECTURAL PLANS.
- LOCATE AND INSTALL ALL MECHANICAL EQUIPMENT TO PROVIDE MANUFACTURER'S MINIMUM SERVICE CLEARANCES.

HVAC GENERAL DEMOLITION NOTES

- VERIFY EXACT SIZE AND LOCATION OF EXISTING UTILITIES PRIOR TO START OF DEMOLITION.
- DISCONNECT ALL HEATING DUCTWORK AND PIPING CONNECTIONS TO EQUIPMENT BEING REMOVED. CONTRACTOR SHALL COORDINATE WORK WITH ALL TRADES.
- UNLESS OTHERWISE NOTED, REMOVAL DUCTWORK, PIPING AND/OR EQUIPMENT SHALL INCLUDE ALL INSULATION, DAMPERS, VALVES, HANGERS, SUPPORTS, EQUIPMENT PADS, FLASHING, CONTROLS, CONTROLS TUBING/WIRING AND ASSOCIATED ACCESSORIES.
- UNLESS OTHERWISE NOTED, REMOVAL OF PIPING SHALL BE BACK TO THE MAIN OR LAST ACTIVE SERVICE.
- ALL OPENINGS OR HOLES LEFT IN EXISTING WALLS, FLOORS, AND CEILINGS TO REMAIN, INCLUDING CHASES, SHALL BE PATCHED TO MATCH EXISTING CONDITIONS. PATCHING SHALL BE IN ACCORDANCE WITH THE APPROPRIATE DIVISION OF THE SPECIFICATIONS.
- THE CONTRACTOR SHALL DISCONNECT EXISTING BUILDING TEMPERATURE CONTROL SYSTEM FROM THE NETWORK AND PROVIDE ALL WORK ASSOCIATED WITH DEMOLITION.
- THE CONTRACTOR SHALL PROVIDE ALL REQUIRED WORK TO MAINTAIN THE CONTINUITY OF THE EXISTING NETWORK UNTIL NEW NETWORK HAS BEEN ESTABLISHED.



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ABBREVIATIONS

HEATING AND

SHEET NO. JOB NO: M1600010

VENTILATION GENERAL

NOTES, SYMBOLS AND

GENERAL NOTES (THIS SHEET)

- SEE SHEET H-001 FOR GENERAL NOTES, SYMBOLS AND ABBREVIATIONS.
- 2. CONTRACTOR SHALL BE RESPONSIBLE FOR LOCATING ALL UTILITIES PRIOR TO CONSTRUCTION. VARIOUS EXISTING UTILITIES TO REMAIN. CONTRACTOR SHALL COORDINATE LOCATION AND ELEVATION OF ALL EXISTING UTILITIES AND AVOID CONFLICT.
- 3. REMOVE EXISTING FIRE DAMPERS ASSOCIATED WITH DEMOLISHED DUCTWORK. REPAIR WALL TO MEET FIRE RATING
- 4. PATCH AND PAINT EXISTING OPENINGS IN WALLS CREATED FROM HVAC WORK TO MATCH EXISTING.
- 5. REMOVE EXISTING SOFFITS IN BASEMENT TO ALLOW ACCESS TO DUCTWORK. REPLACE SOFFIT WITH SAME CONSTRUCTION TO MAINTAIN ROOM RATING.
- 6. COORDINATE PAINTING OF EXISTING/NEW DUCTWORK WITH ARHICTECT.
- 7. CONTRACTOR SHALL VERIFY OPERATION OF ALL EXISTING EQUIPMENT AND SUBMIT TESTING AND BALANCING REPORT FOR AIR AND WATER SYSTEMS TO ENGINEER FOR REVIEW PRIOR TO ANY CONSTRUCTION.


MECHANICAL DEMO NOTES (THIS SHEET)

- 1. REMOVE EXISTING SA BRANCH DUCTS UP TO FIRST FLOOR. PATCH OPENING IN DUCTWORK AIR TIGHT. EXISTING DUCT HEADER TO REMAIN IN PLACE.
- REMOVE EXISTING SA DUCT ENDCAP TO MAKE CONNECTION TO NEW
- 3. REMOVE EXISTING SA DUCTWORK TO APPROXIMATE LOCATION SHOWN FOR CONNECTION TO NEW SA DUCTWORK.
- 4. REMOVE LOW PRESSURE SA DUCTWORK FROM VAV BOX TO FLOOR GRILLE. SEE H-200 FOR NEW WORK.
- 5. REMOVE THREE (3) EXISTING SA GRILLES. PATCH OPENING IN DUCTWORK AIR TIGHT.

MECHANICAL KEYNOTES (THIS SHEET)

- 1. EXISTING MEDIUM PRESSURE DUCTWORK CONTINUES AND IS NOT
- SHOWN. NO WORK BEYOND THIS POINT.

 2. EXISTING SA DUCTWORK UP TO FLOOR GRILLE TO REMAIN.
- EXISTING SA DUCTWORK OF TO FLOOK GRILLE TO REMAIN.
 EXISTING MEDIUM PRESSURE DUCTWORK TO REMAIN AND BE
- REUSED.
- 4. EXISTING VAV BOX AND REHEAT COIL TO REMAIN AND BE REUSED. EXISITNG HWS AND HWR PIPING INCLUDING CONTROL VALVES AND BALANCING VALVES TO REMAIN.
- EXISTING FIRE DAMPER TO REMAIN.
- 6. EXISTING MEDIUM PRESSURE SA DUCTWORK TO REMAIN. EXISTING EQUIPMENT, RETURN DUCTWORK, AND DUCTWORK ASSOCIATED WITH AHU-2 NOT SHOWN.
- 7. EXISTING AIR HANDLING UNIT TO REMAIN.
- EXISTING SA DUCT ALONG WALL TO REMAIN.
- 9. EXISTING VAV BOX, LOW PRESSURE SA DUCTWORK, FLEX DUCT, AND CELING GRILLES SERVING BASEMENT TO REMAIN.

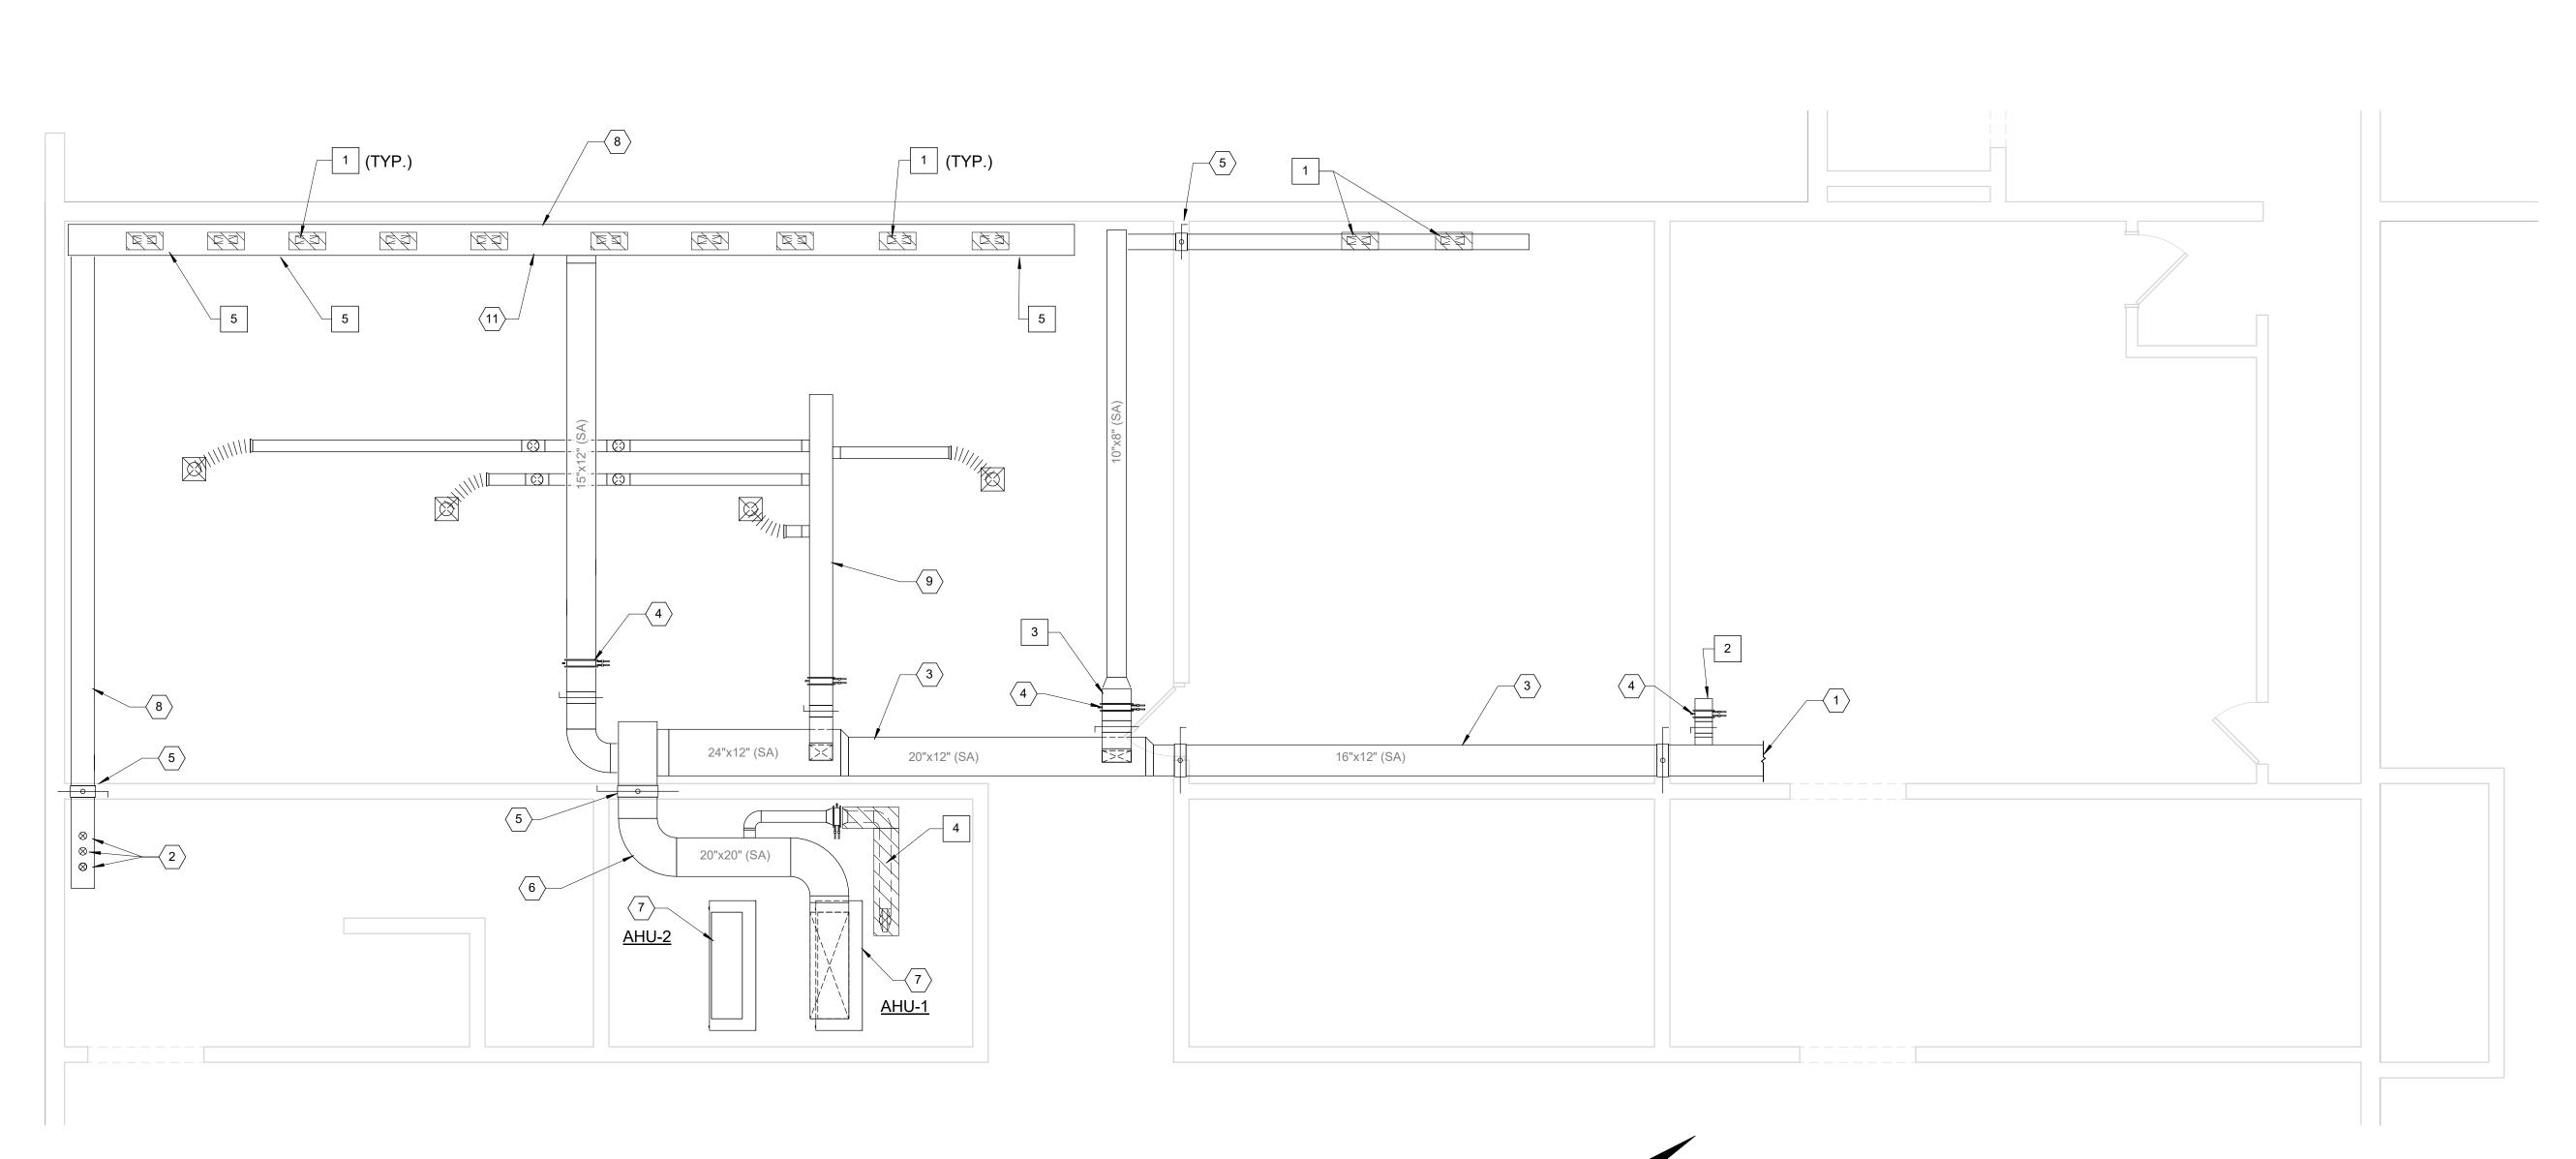



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KANE COUNTY DEPARTMENT OF TRANSPORTATION (KDOT) OFFICE RENOVATION

41W011 BURLINGTON ROAD CAMPTON HILLS, IL 60175

Professional Seals

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No.	Description	Date
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2	ISSUED FOR 30% DESIGN	07/23/201
3	ISSUED FOR 100% DESIGN	09/12/201

LOWER LEVEL HVAC DEMOLITION PLAN

H100

DRAWN:	AJM
CHECKED:	NTP
DESIGNED:	AJM
JOB NO: M1	600010

BASEMENT HVAC DEMOLITION PLAN

GENERAL NOTES (THIS SHEET)


- SEE SHEET H-001 FOR GENERAL NOTES, SYMBOLS AND ABBREVIATIONS. CONTRACTOR SHALL BE RESPONSIBLE FOR LOCATING ALL UTILITIES PRIOR TO CONSTRUCTION. VARIOUS EXISTING UTILITIES TO REMAIN. CONTRACTOR SHALL COORDINATE LOCATION AND ELEVATION OF ALL
- EXISTING UTILITIES AND AVOID CONFLICT. PATCH AND PAINT EXISTING OPENINGS IN WALLS CREATED FROM HVAC WORK TO MATCH EXISTING.
- CONTRACTOR SHALL BE RESPONSIBLE FOR REMOVING AND REPLACING ALL CEILING TILES REQUIRED TO INSTALL THEIR WORK.
- PROVIDE NEW CEILING TILES WHERE EXISTING CEILING TILES ARE DAMAGED DURING WORK OR REPLACEMENT CEILING TILES ARE REQUIRED WHERE EXISTING GRILLES/DIFFUSERS ARE REMOVED.
- PROVIDE NEW CEILING GRID WHERE REQUIRED TO ALLOW INSTALLATION OF NEW DUCT/DIFFUSER/GRILLES.

MECHANICAL DEMO NOTES (THIS SHEET)

- REMOVE EXISTING LINEAR AIR TERMINAL ALONG WALL, INCLUDING ASSOCIATED VERTICAL DUCTWORK. SEE ARCHITECTURAL SHEETS FOR FLOOR FINISHING.
- REMOVE EXISTING WALL MOUNTED RETURN GRILLE. GRILLE WILL BE REPLACED WITH LARGER GRILLE. SEE NEW WORK PLAN.
- REMOVE EXISTING FLOOR REGISTER. REGISTER WILL BE REPLACED WITH A LARGER REGISTER. SEE NEW WORK PLAN. REFER TO LOWER LEVEL DEMOLITION PLAN FOR DUCTWORK REMOVAL.
- REMOVE EXISITNG WALL MOUNTED RETURN GRILLE. EXISTING OPENING TO REMAIN AND BE REUSED.

MECHANICAL KEYNOTES (THIS SHEET)

- EXISTING FLOOR GRILLE TO REMAIN.
- EXISTING RA DUCTWORK ABOVE CEILING TO REMAIN.
- EXISTING MASTER THERMOSTAT TO REMAIN.
- EXISTING THERMOSTAT TO REMAIN. TAG INDICATES THERMOSTAT

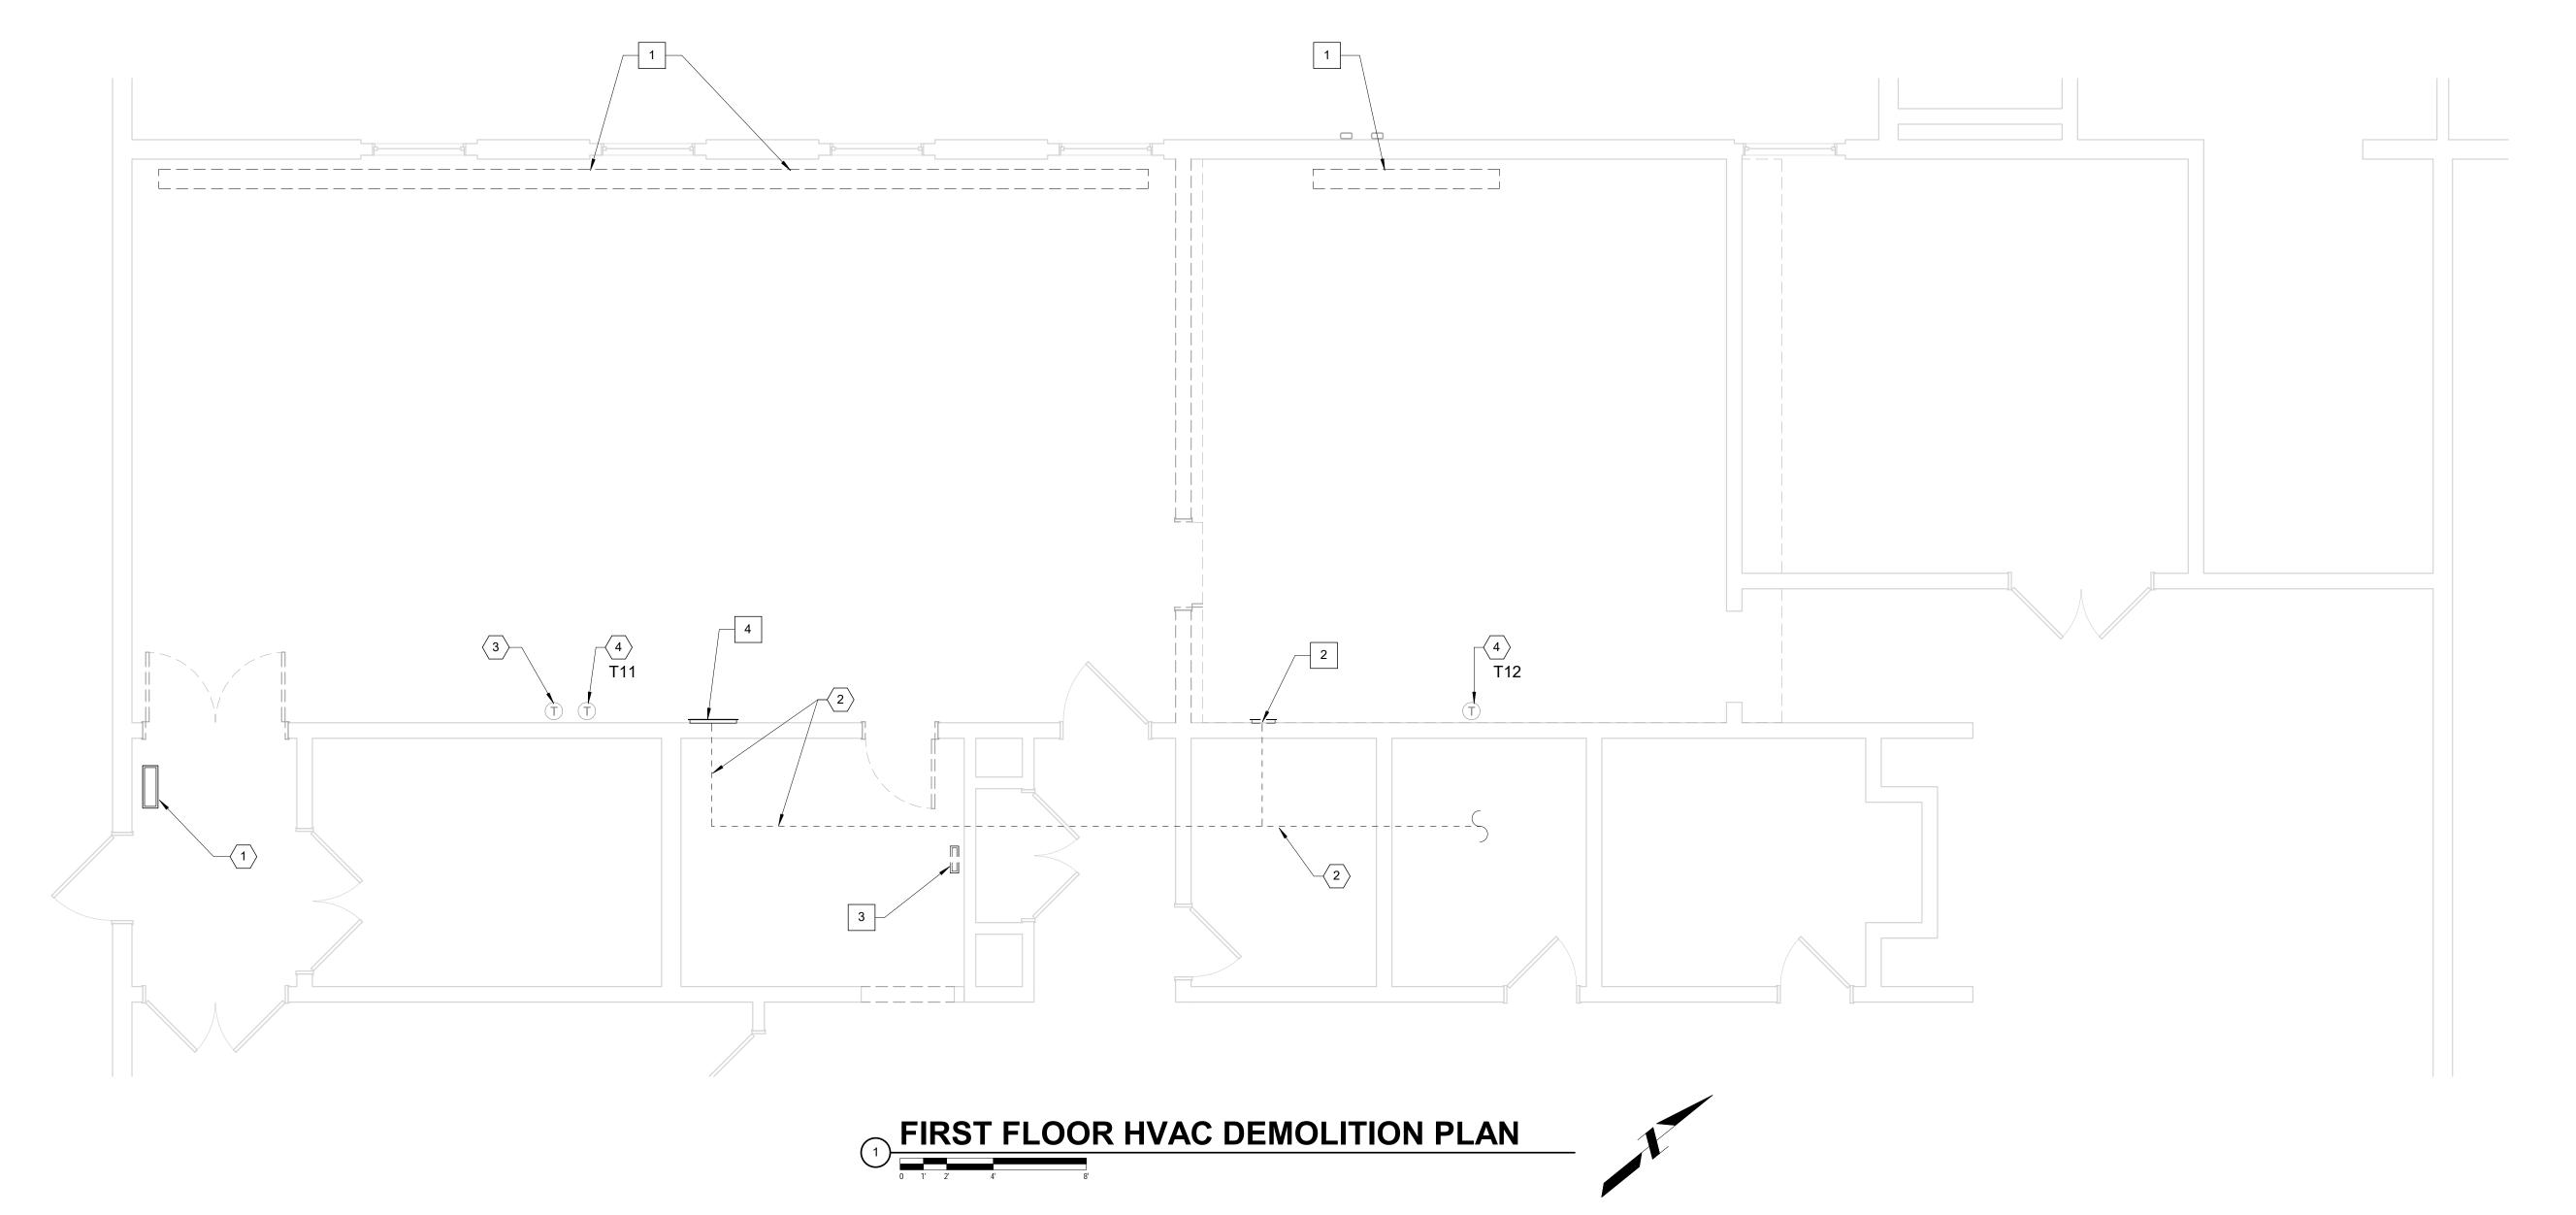



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KANE COUNTY DEPARTMENT OF TRANSPORTATION OFFICE RENOVATION

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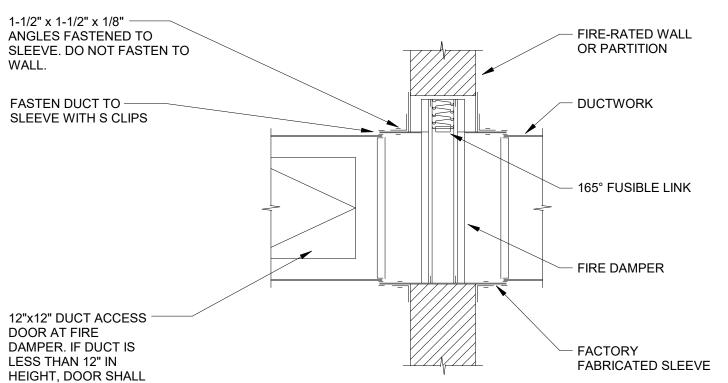
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FIRST FLOOR HVAC **DEMOLITION PLAN**

DRAWN:	AJM	
CHECKED:	NTP	
DESIGNED:	AJM	

H101 JOB NO: M1600010



BE 1" LESS THAN DUCT HEIGHT

FIRE DAMPER INSTALLATION DETAIL

N.T.S.

GENERAL NOTES

- SEE SHEET H-001 FOR GENERAL NOTES, SYMBOLS AND ABBREVIATIONS. CONTRACTOR SHALL BE RESPONSIBLE FOR LOCATING ALL UTILITIES
- PRIOR TO CONSTRUCTION. VARIOUS EXISTING UTILITIES TO REMAIN. CONTRACTOR SHALL COORDINATE LOCATION AND ELEVATION OF ALL EXISTING UTILITIES AND AVOID CONFLICT.
- PATCH AND PAINT EXISTING OPENINGS IN WALLS CREATED FROM HVAC WORK TO MATCH EXISTING.
- REMOVE EXISTING SOFFITS IN BASEMENT TO ALLOW ACCESS TO DUCTWORK. REPLACE SOFFIT WITH SAME CONSTRUCTION TO MAINTAIN ROOM RATING.
- COORDINATE PAINTING OF EXISTING/NEW DUCTWORK WITH ARHICTECT CONTRACTOR SHALL VERIFY OPERATION OF ALL EXISTING EQUIPMENT AND SUBMIT TESTING AND BALANCING REPORT FOR AIR AND WATER
- SYSTEMS TO ENGINEER FOR REVIEW PRIOR TO ANY CONSTRUCTION. RE-BALANCE EXISTING VAV BOXES, REHEAT COILS, GRILLES, DIFFUSERS, OPENINGS, FANS, AND AIR HANDLING UNITS TO AIR FLOW INDICATED ON DRAWINGS OR TO ACCOMMODATE FOR REVISED AIR AND WATER FLOWRATES.

MECHANICAL KEYNOTES (THIS SHEET)

- NEW 12x4 SA DUCT UP TO FLOOR GRILLE ON FLOOR ABOVE. COORDINATE EXACT LOCATION OF DUCTWORK AND GRILLE IN FIELD TO
- AVOID CONFLICT WITH NEW/EXISTING UTILITIES AND FURNITURE. NEW SA DUCTWORK ROUTED AT CEILING.
- EXISTING VAV BOX AND REHEAT COIL TO REMAIN.
- EXISTING SA DUCTWORK TO REMAIN.
- EXISTING AHU TO REMAIN. REBALANCE FAN TO PROVIDE REVISED AIRFLOW AS INDICATED ON DRAWINGS.
- VERIFY PRESENCE OF 3-HOUR RATED FIRE DAMPER AT WALL.
- BALANCING DAMPER.
- PROVIDE NEW 3-HOUR RATED FIRE DAMPER AT WALL. REFER TO DETAIL 2 THIS SHEET.
- MAKE CONNECTION TO EXISTING SA DUCTWORK WITH NEW DUCT.
- NEW SA DUCT FROM VAV BOX UP TO NEW FLOOR GRILLE. TRANSITION TO 18x4 FLOOR GRILLE SIZE. COORDINATE EXACT LOCATION OF DUCTWORK AND GRILLE IN FIELD TO AVOID CONFLICT WITH NEW AND **EXISTING UTILITIES.**
- EXISTING AHU TO REMAIN. UNIT IS NOT AFFECTED BY THIS WORK.



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KANE COUNTY DEPARTMENT OF TRANSPORTATION OFFICE RENOVATION


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LOWER LEVEL HVAC PLAN

DRAWN: AJM	SHEET NO.
CHECKED: NTP	H200
DESIGNED: AJM	ПZUU
JOB NO: M1600010	



SYMBOL	FACE SIZE	TYPE	BASIS OF DESIGN	MAX NC LEVEL	REMARKS
R1	12"x12"	SURFACE MOUNTED RETURN GRILLE	TITUS 300	30	NOTE 1
R2	12"x12"	SURFACE MOUNTED RETURN GRILLE	TITUS 300	30	NOTE 1
(A1)	12"x4"	SUPPLY AIR - LINEAR FLOOR GRILLE	PRICE LFG	30	NOTE 1
(A2)	18"x4"	SUPPLY AIR - LINEAR FLOOR GRILLE	PRICE LFG	30	NOTE 1
(E)	VARIES	EXISTING CONNECTION	VARIES	22	NOTE 2

SCHEDULE NOTES:

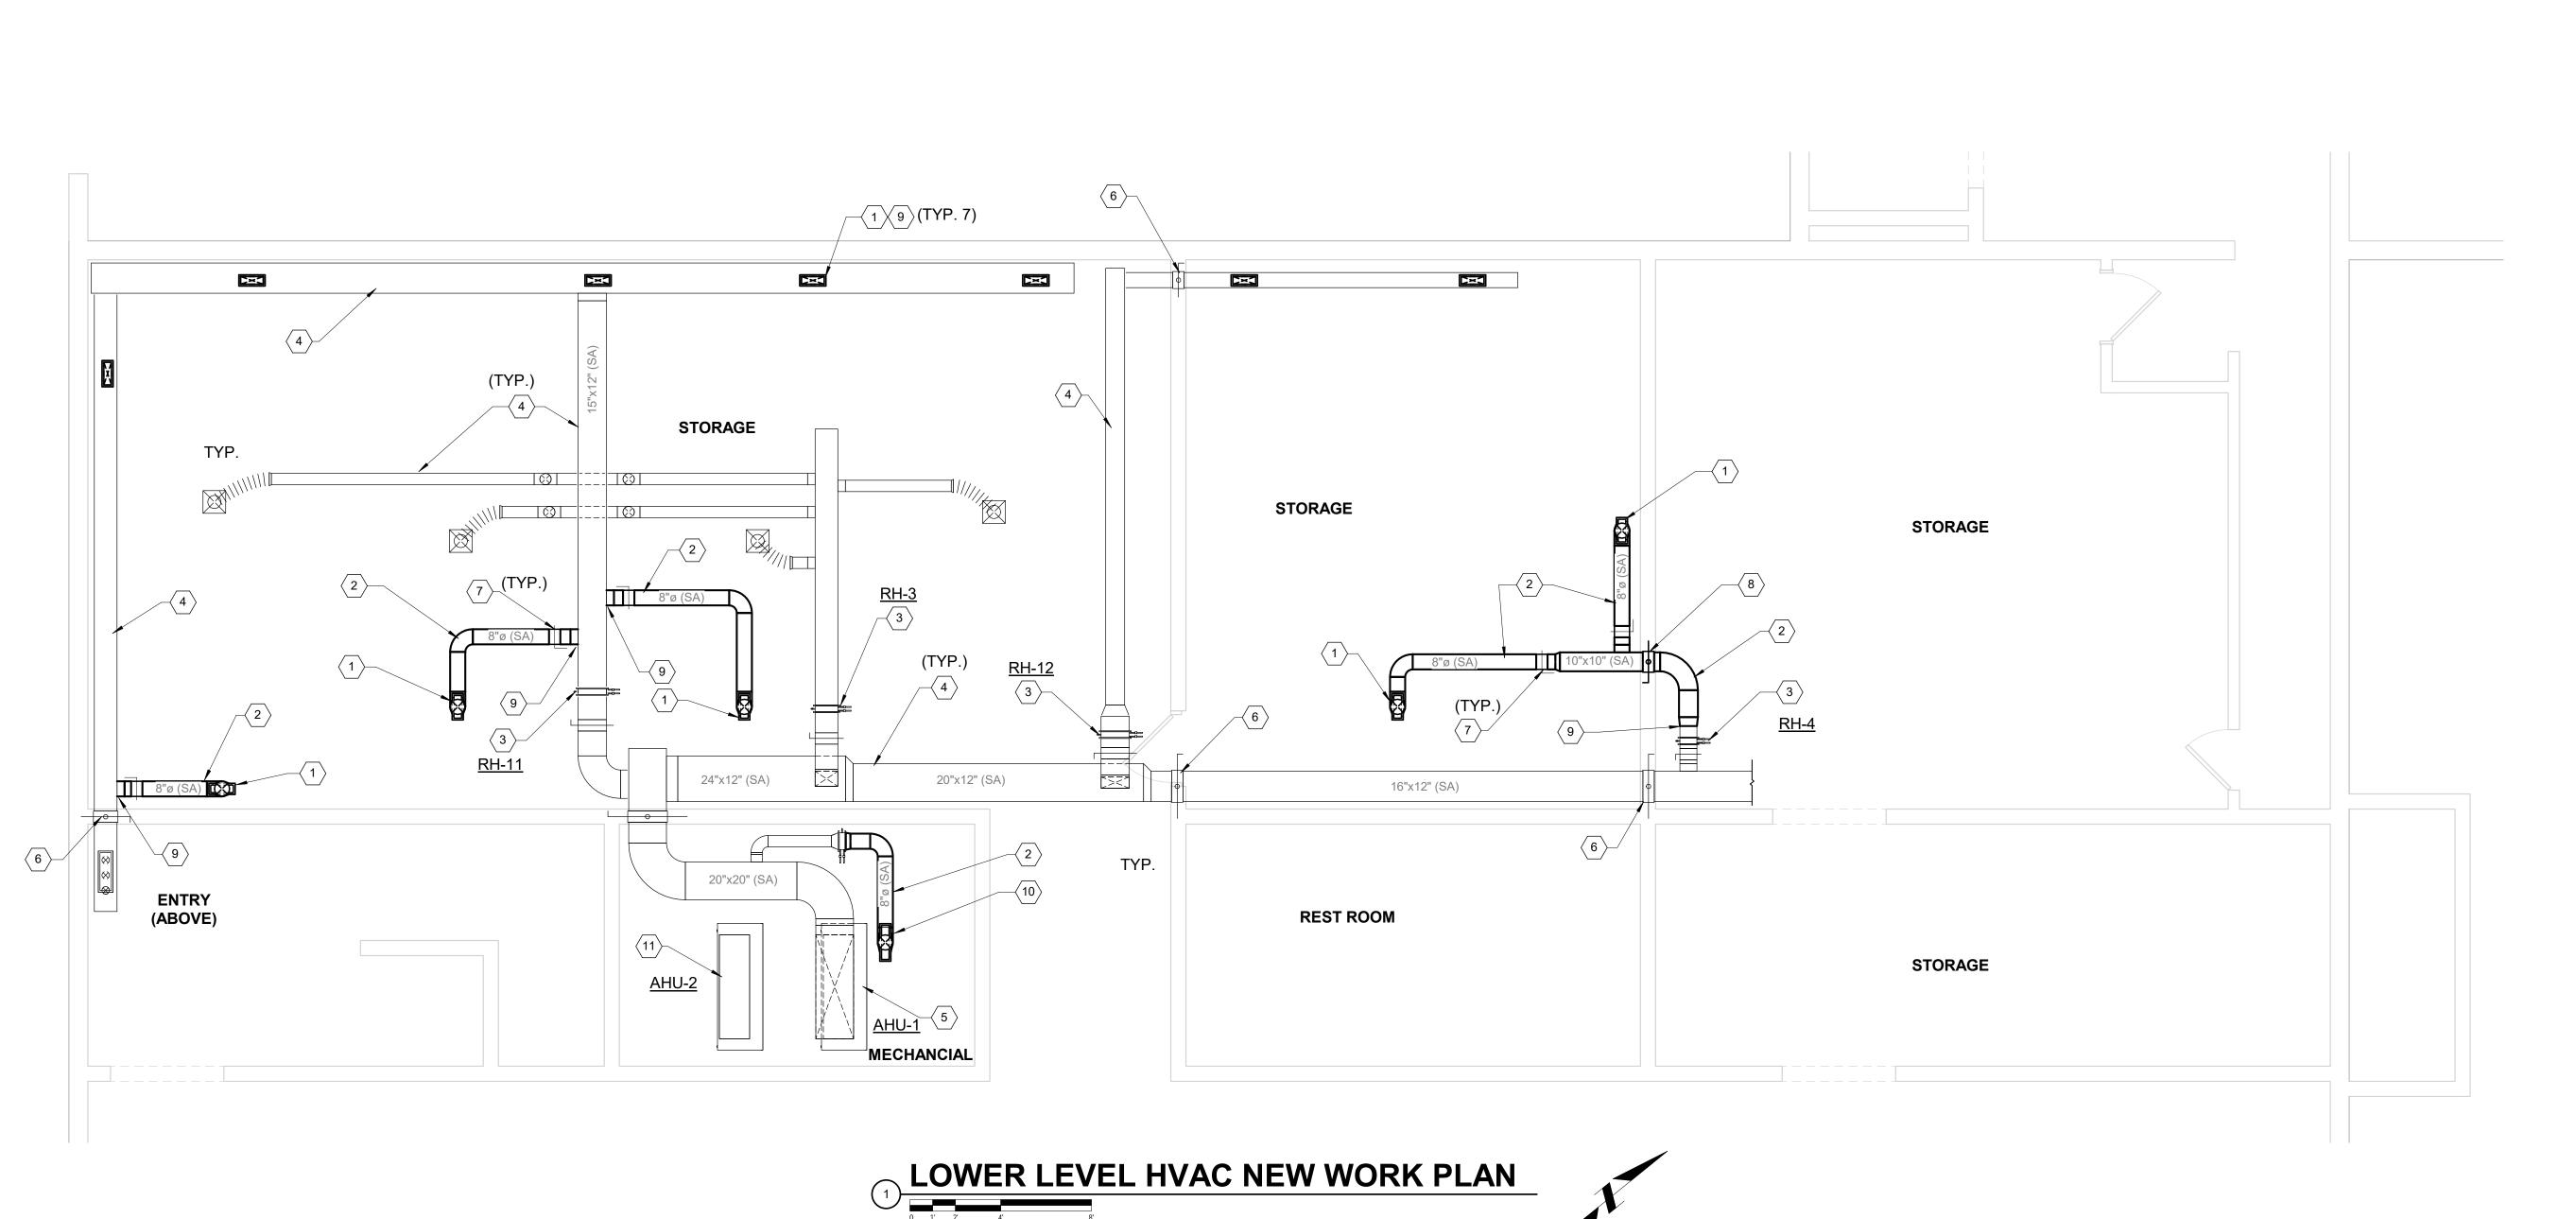- 1 PROVIDE TRANSITION TO DUCTWORK AS REQUIRED. VERIFY MAX NO LEVEL IS MET.
- 2 EXISTING GRILLE/DIFFUSER TO BE REUSED. REBALANCE TO THE CFM SHOWN ON PLAN.


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 3. PATCH AND PAINT EXISTING OPENINGS IN WALLS CREATED FROM HVAC WORK TO MATCH EXISTING.
- 4. CONTRACTOR SHALL BE RESPONSIBLE FOR REMOVING AND REPLACING ALL CEILING TILES REQUIRED TO INSTALL THEIR WORK.
- 5. PROVIDE NEW CEILING TILES WHERE EXISTING CEILING TILES ARE DAMAGED DURING WORK OR REPLACEMENT CEILING TILES ARE REQUIRED WHERE EXISTING GRILLES/DIFFUSERS ARE REMOVED.
- 6. PROVIDE NEW CEILING GRID WHERE REQUIRED TO ALLOW INSTALLATION OF NEW DUCT/DIFFUSER/GRILLES.
- 7. CONTRACTOR SHALL VERIFY OPERATION OF ALL EXISTING EQUIPMENT AND SUBMIT TESTING AND BALANCING REPORT FOR AIR AND WATER SYSTEMS TO ENGINEER FOR REVIEW PRIOR TO ANY CONSTRUCTION.
- 8. RE-BALANCE EXISTING VAV BOXES, REHEAT COILS, GRILLES, DIFFUSERS, OPENINGS, FANS, AND AIR HANDLING UNITS TO AIR FLOW INDICATED ON DRAWINGS OR TO ACCOMMODATE FOR REVISED AIR AND WATER FLOWRATES.

MECHANICAL KEYNOTES (THIS SHEET)

- NEW FLOOR SUPPLY GRILLE.
- EXISTING FLOOR SUPPLY GRILLE TO REMAIN.
- . NEW RETURN GRILLE OF SAME SIZE.
- 4. NEW RETURN GRILLE IN CEILING. CONNECT TO EXISTING RA DUCTWOK ABOVE CEILING.
- 5. EXISTING MASTER THERMOSTAT CONTROLLING THE CONDENSING UNIT TO REMAIN.
- 6. EXISTING THERMOSTAT TO REMAIN. TAG INDICATES EXISTING THERMOSTAT NUMBER. THERMOSTATS T11 AND T12 SHALL BE RECONFIGURED SUCH THAT NEW FIRST FLOOR OFFICE SPACE IS CONTROLLED AS A SINGLE ZONE.



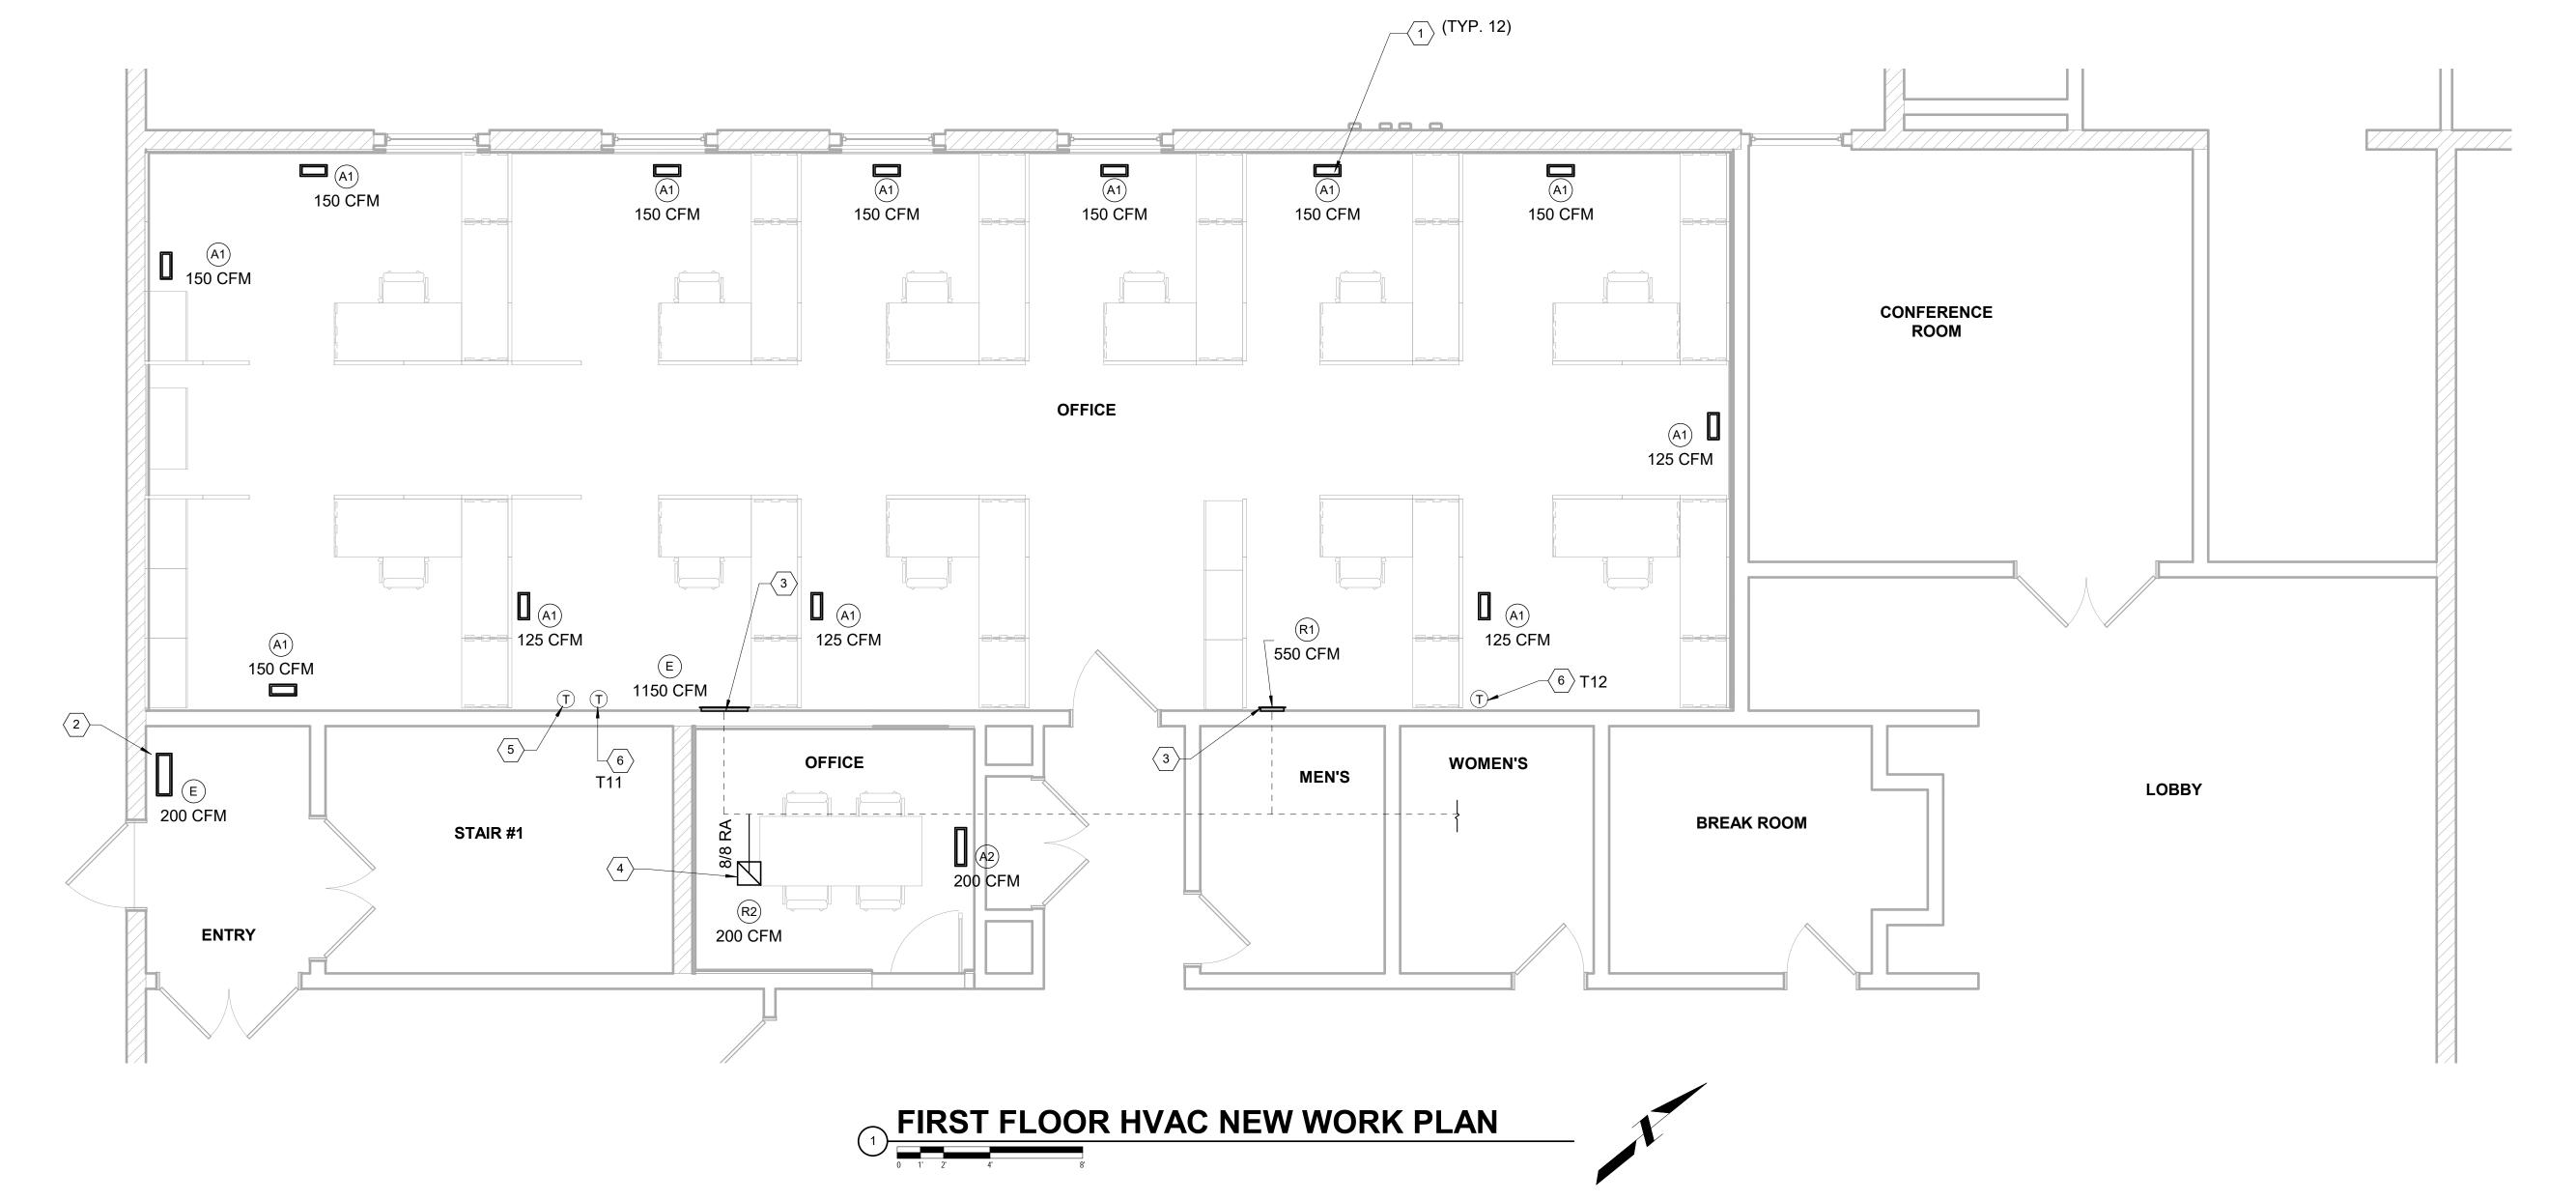

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FIRST FLOOR HVAC PLAN

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CHECKED: NTP	H201
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