
### STATE OF ILLINOIS

### KANE COUNTY DIVISION OF TRANSPORTATION

# FABYAN PARKWAY (C.H. 8) OVER FOX RIVER

## BRIDGE REPAIRS AND RESURFACING SECTION 17-00479-00-BR

### NOT ISSUED FOR CONSTRUCTION 90% SUBMITTAL OCTOBER 31, 2018

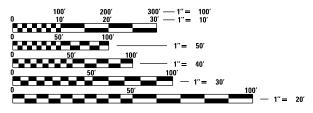

INDEX OF SHEETS

5 - 6

7 - 8 9 - 11

12 - 21 22 - 23

24 - 25

27 - 47

48 - 51

**DESCRIPTION** 

**COVER SHEET** 

ROADWAY PLAN SHEET

MAINTENANCE OF TRAFFIC

**EROSION CONTROL PLAN** 

PAVEMENT MARKING

LANDSCAPING PLAN

STRUCTURE PLANS


ROADWAY DETAILS
STANDARD DETAILS

GENERAL NOTES AND STANDARDS SUMMARY OF QUANTITIES TYPICAL SECTIONS


ALIGNMENT, TIES AND BENCHMARKS

FULL SIZE PLANS HAVE BEEN PREPARED USING STANDARD ENGINEERING SCALES. REDUCED SIZED PLANS WILL NOT CONFORM TO STANDARD SCALES. IN MAKING MEASUREMENTS ON REDUCED PLANS, THE ABOVE SCALES MAY BE USED.

J.U.L.I.E.
JOINT UTILITY LOCATION INFORMATION FOR EXCAVATION
1-800-892-0123
OR 811

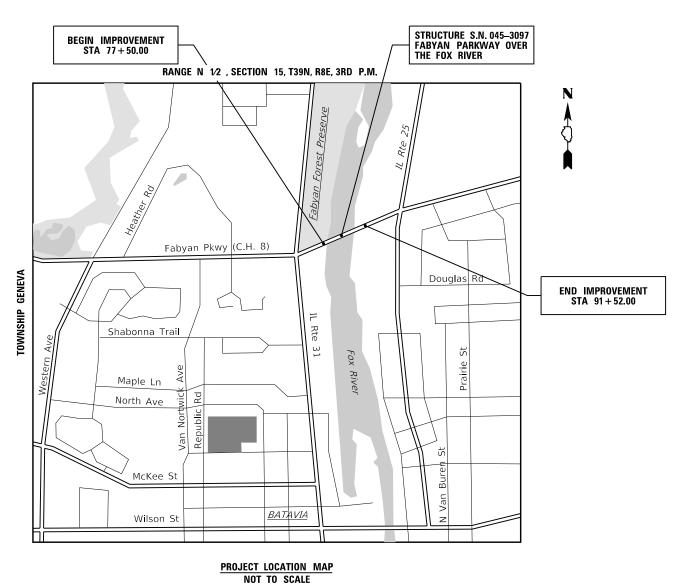

GROSS LENGTH = 4,750 FT. = 0.90 MILE NET LENGTH = 1.402 FT. = 0.27 MILE

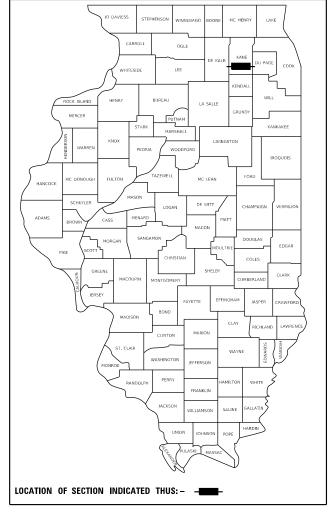



DATE: <u>6-30-2018</u>

DIANA DECKER, P.E. NO. 062-056649, EXP. DATE 11/30/2019

APPLIES TO DWG NUMBERS:



R KANE 56
ILLINOIS CONTRACT NO.

DATE: 6-30-2018 SCOTT ESHLEMAN, P.E. NO. 081-005155, EXP. DATE 11/30/2018 APPLIES TO DWG NUMBERS:

STATE OF ILLINOIS
KANE COUNTY DIVISION OF TRANSPORTATION

APPROVED \_\_\_\_\_\_\_ 20 \_\_\_\_\_

COUNTY ENGINEER

### **FABYAN PARKWAY GENERAL NOTES**

BEFORE STARTING ANY EXCAVATION, THE CONTRACTOR SHALL CALL "J.U.L.I.E."AT (800) 892-0123 OR 811 FOR FIELD LOCATIONS OF BURIED ELECTRIC, TELEPHONE AND GAS UTILITIES. 48 HOUR NOTIFICATION IS RECUIRED.

THE CONTRACTOR SHALL COORDINATE CONSTRUCTION ACTIVITIES WITH UTILITY COMPANIES AND KANE COUNTY DIVISION OF TRANSPORTATION.

THE REMOVAL OF GUARDRAIL TERMINAL SECTIONS SHALL BE INCLUDED IN THE UNIT PRICE PER FOOT FOR "GUARDRAIL REMOVAL."

THE THICKNESS OF THE HMA MIXTURE SHOWN ON THE PLANS IS THE NOMINAL THICKNESS. DEVIATIONS FROM THE NOMINAL THICKNESS WILL BE PERMITTED WHEN SUCH DEVIATIONS OCCUR DUE TO IRREGULARITIES IN THE EXISTING SURFACE OR BASE ON WHICH THE HMA MIXTURE IS PLACED.

THE FOLLOWING RATES OF APPLICATION HAVE BEEN USED IN CALCULATING PLAN QUANTITIES:

HMA RESURFACING	112	LBS / SQ YD / IN
PRIME COAT	0.05	LBS/ SQ FT

DO NOT SCALE PLANS FOR CONSTRUCTION DIMENSIONS.

THE CONTRACTOR SHALL VERIFY THE EXISTING TYPE/HEIGHT OF EXISTING GUARDRAIL BEFORE ORDERING THE NEW TERMINAL SECTION. COST INCLUDED WITH THE COST OF THE TERMINAL." THE TERMINAL SECTION SHALL MATCH THE HEIGHT OF THE EXISTING GUARDRAIL.

THE CONTRACTOR SHALL SUPPLY THE RESIDENT ENGINEER WITH THE MANUFACTURER'S INSTALLATION REQUIREMENTS FOR THE TYPE OF STEEL PLATE BEAM GUARDRAIL TERMINAL TYPE 1 SPECIAL (TANGENT).

ALL CONSTRUCTION SHALL BE IN CONFORMANCE WITH THE APPLICABLE REQUIREMENTS SET FORTH IN "THE STANDARD SPECIFICATIONS FOR ROAD AND BRIDGE CONSTRUCTION" ADOPTED APRIL 1, 2016 THEREINAFTER REFERRED TO AS STANDARD SPECIFICATIONS, THE LATEST EDITION OF THE "ILLINOIS MANUAL ON UNIFORM MANUAL TRAFFIC CONTROL DEVICES FOR STREETS AND HIGHWAYS" IN EFFECT ON THE DATE OF INVITATION FOR BIDS; THE "SUPPLEMENTAL SPECIFICATIONS AND RECURRING SPECIAL PROVISIONS" LATEST EDITION; INTERIM SPECIAL PROVISIONS AS INCLUDED IN THE CONTRACT DOCUMENTS; AND THE DETAILS AND STANDARDS CONTAINED IN THESE PLANS.

THE LOCATIONS OF THE EXISTING UTILITIES, AS SHOWN ON THE DRAWINGS, REPRESENT DATA RECEIVED FROM VARIOUS SOURCES, IT IS NOT GUARANTEED TO BE CORRECT OR ALL INCLUSIVE. THE CONTRACTOR SHALL CONDUCT HIS OWN INVESTIGATIONS INTO THE LOCATION, SIZE, DEPTH, AND NATURE OF ANY AND ALL EXISTING UTILITIES WHICH MAY INTERFERE WITH THE WORK UNDER THIS CONTRACT. ANY EXISTING UTILITIES WHICH ARE TO REMAIN IN SERVICE SHALL BE FULLY PROTECTED BY THE CONTRACTOR AND ANY DAMAGE CAUSED BY THE CONSTRUCTION SHALL BE IMMEDIATELY REPAIRED AT NO ADDITIONAL COST IN ACCORDANCE WITH ARTICLE 105.07.

TRAFFIC CONTROL DEVICES: ALL TRAFFIC CONTROL DEVICES USED FOR THE MAINTENANCE OF TRAFFIC AS DETAILED ON THE PLANS SHALL BE REFLECTORIZED PRIOR TO INSTALLATION AND CLEANED AS NECESSARY THROUGHOUT THE DURATION OF THE CONTRACT OR AS DIRECTED BY THE ENGINEER. CLEANING AND MAINTENANCE OF TRAFFIC CONTROL DEVICES, INCLUDING SIGNS, WILL NOT BE MEASURED SEPARATELY FOR PAYMENT BUT SHALL BE INCLUDED WITH THE APPLICABLE TRAFFIC CONTROL PAY ITEM.

ALL TRAFFIC CONTROL AND OTHER ADVISORY SIGNS NEEDED FOR CONSTRUCTION ARE TO BE FURNISHED BY THE CONTRACTOR IN ACCORDANCE WITH ARTICLE 107.14 OF THE STANDARD SPECIFICATIONS.

THE CONTRACTOR SHALL AT ALL TIMES PROVIDE PROTECTION FOR TRAFFIC AS CALLED FOR IN THE APPLICATION OF TRAFFIC CONTROL DEVICES, THE STANDARD SPECIFICATIONS AND THE PLANS.

ANY LOOSE MATERIAL DEPOSITED IN THE FLOW LINE OF DRAINAGE STRUCTURES WHICH OBSTRUCTS THE NATURAL FLOW OF WATER SHALL BE REMOVED AT THE CLOSE OF EACH WORKING DAY, PRIOR TO ACCEPTANCE OF THE IMPROVEMENT, ALL DRAINAGE STRUCTURES SHALL BE FREE OF DIRT AND DEBRIS. THIS WORK WILL NOT BE PAID FOR SEPARATELY BUT SHALL BE CONSIDERED INCLUDED IN THE COST OF THE CONTRACT.

### LIST OF IDOT HIGHWAY STANDARDS

000001-06	STANDARD SYMBOLS, ABBREVIATIONS AND PATTERNS
001001-02	AREAS OF REINFORCEMENT BARS
001006	DECIMAL OF AN INCH AND OF A FOOT
280001-07	TEMPORARY EROSION CONTROL SYSTEMS
606301-04	PC CONCRETE ISLANDS AND MEDIANS
630001-12	STEEL PLATE BEAM GUARDRAIL
631031-15	TRAFFIC BARRIER TERMINAL, TYPE 6
701426-09	LANE CLOSURE, MULTILANE INTERMITTENT OR MOVING OPERATION,
	FOR SPEEDS ≥45 MPH
701701-10	URBAN LANE CLOSURE, MULTILANE INTERSECTION
701901 <del>-</del> 07	TRAFFIC CONTROL DEVICES
720021-02	SIGN PANELS, EXTRUDED ALUMINUM TYPE
725001-01	OBJECT AND TERMINAL MARKERS
780001-05	TYPICAL PAVEMENT MARKINGS
782006	GUARDRAIL AND BARRIER WALL REFLECTOR MOUNTING DETAILS

### LIST OF IDOT DISTRICT 1 DETAILS

TC-10	TRAFFIC CONTROL AND PROTECTION FOR SIDE ROADS, INTERSECTIONS, AND DRIVEWAYS
TC-13	DISTRICT ONE TYPICAL PAVEMENT MARKINGS
TC-14	TRAFFIC CONTROL AND PROTECTION AT TURN BAYS (TO REMAIN OPEN TO TRAFFIC)
TC-22	ARTERIAL ROAD INFORMATION SIGN
TC-26	DRIVEWAY ENTRANCE SIGNING

### LIST OF KDOT DETAIL

KDOT 03 MEDIAN SIGN

Stanley Consultants INC.
Stanley Consultants INC.
SCHOOL Flight Not SAFE 173, Olicopa, Winds 695-790
INC. 107, Supervision Noted-69537
INC. 107, Supervision Noted-69537

USER NAME = 3690	DESIGNED	-	SP	REVISED -	Ξ
	DRAWN	-	ED	REVISED -	
PLOT SCALE = 2.0000 ' / in.	CHECKED	-	DLD	REVISED -	
PLOT DATE = 10/31/2018	DATE	-	10-31-2018	REVISED -	

		FABYAI	N PARK	WAY		C.H.	SECT	ION		COUNTY	TOTAL SHEETS	SHEET NO.
		CENIE	RAL NO	TFC		8	17-0047	9-00-BR		KANE	57	2
		GLIVE	IIAL INU	ILU						CONTRACT	NO.	
SCALE: NONE	SHEET 1	OF 1	SHEETS	STA.	TO STA.			ILLINOIS	FFD. AII	D PROJECT		

CODE NO.	ПЕМ	UNIT	TOTAL QUANTITY
20101700	SUPPLEMENTAL WATERING	UNIT	1.4
20200100	EARTH EXCAVATION	CU YD	31
25000210	SEEDING, CLASS 2A	ACRE	0.14
25000400	NITROGEN FERTILIZER NUTRIENT	POUND	13
25000500	PHOSPHORUS FERTILIZER NUTRIENT	POUND	13
25000600	POTASSIUM FERTILIZER NUTRIENT	POUND	13
25100630	EROSION CONTROL BLANKET	SQ YD	665
28000400	PERIMETER EROSION BARRIER	FOOT	925
28000500	INLET AND PIPE PROTECTION	EACH	8
28000510	INLET FILTERS	EACH	12
40600290	BITUMINOUS MATERIALS (TACK COAT)	POUND	32
40603565	POLYMERIZED HOT-MIX ASPHALT SURFACE COURSE, MIX "E", N70	TON	7
44003100	MEDIAN REMOVAL	SQ FT	57
440005:3	NEW MARKET NEW PROPERTY.	20.57	000
44003510	MEDIAN REMOVAL PARTIAL DEPTH	SQ FT	630
50102400	CONCRETE REMOVAL	CUYD	157

CODE NO.	ПЕМ	UNIT	TOTAL QUANTITY
50104650	SLOPE WALL REMOVAL	SQ YD	91
50300255	CONCRETE SUPERSTRUCTURE	CU YD	157
50300260	BRIDGE DECK GROOVING	SQ YD	7493
50300300	PROTECTIVE COAT	SQ YD	8742
50800205	REINFORCEMENT BARS, EPOXY COATED	POUND	6650
51100100	SLOPE WALL 4 INCH	SQ YD	92
59000200	EPOXY CRACK INJECTION	FOOT	254
60620400	CONCRETE MEDIAN, TYPE SB-9.06	SQ FT	64
63000001	STEEL PLATE BEAM GUARDRAIL, TYPE A, 6 FOOT POSTS	FOOT	88
63100167	TRAFFIC BARRIER TERMINAL, TYPE 1 (SPECIAL) TANGENT	EACH	2
63200310	GUARDRAIL REMOVAL	FOOT	600
67100100	MOBILIZATION	L SUM	1
70300904	PAVEMENT MARKING TAPE, TYPE IV 4"	FOOT	22533
70300906	PAVEMENT MARKING TAPE, TYPE IV 6"	FOOT	1036
72000100	SIGN PANEL - TYPE 1	SQ FT	10

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١	Stanley Consultants 🗝.
	850 Rest Higgins Rood, Suite 130, Chicogo, Illhois 6069-280 www.shonigor.cu.com Illhois Film Registration No.: 84-00533
	Innote hire Registration Moute4-c0533

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PLOT DATE = 10/31/2018	DATE - 10-31-2018	REVISED -

		FABYAI	N PARK	WAY		C.H.	SECTION	COUNTY	TOTAL SHEETS	SHEET NO.
	CI.	IMMARV	OF OIL	ANTITIES		8	17-00479-00-BR	KANE	57	3
		IVIIVIAIII	01 40	ANTITIES				CONTRACT	NO.	
SCALE: NONE	SHEET 1	OF 2	SHEETS	STA.	TO STA.		ILLINOIS FED.	AID PROJECT		

CODE NO.	ПЕМ	UNIT	TOTAL QUANTITY
72501000	TERMINAL MARKER - DIRECT APPLIED	EACH	2
72800100	TELESCOPING STEEL SIGN SUPPORT	FOOT	22
78009000	MODIFIED URETHANE PAVEMENT MARKING - LETTERS AND SYMBOLS	SQ FT	176.8
78009004	MODIFIED URETHANE PAVEMENT MARKING - LINE 4"	FOOT	12162
78009006	MODIFIED URETHANE PAVEMENT MARKING - LINE 6"	FOOT	917
78009012	MODIFIED URETHANE PAVEMENT MARKING - LINE 12"	FOOT	130
78009024	MODIFIED URETHANE PAVEMENT MARKING - LINE 24"	FOOT	77
78200005	GUARDRAIL REFLECTORS, TYPE A	EACH	12
JT525068	MODULAR EXPANSION JOINT STRIP SEAL REPLACEMENT, 6 IN	FOOT	176
X0327980	PAVEMENT MARKING REMOVAL - WATER BLASTING	SQ FT	2568
X7010216	TRAFFIC CONTROL AND PROTECTION, (SPECIAL)	EACH	1
X7010238	CHANGEABLE MESSAGE SIGN, SPECIAL	CAL MO	12
X7030005	TEMPORARY PAVEMENT MARKING REMOVAL	SQ FT	4877
Z0001906	STRUCTURAL STEEL REPAIR	LSUM	1
Z0006018	BRIDGE DECK LATEX CONCRETE OVERLAY, 3 INCHES	SQ YD	8075

CODE NO.	ITEM	UNIT	TOTAL QUANTITY
Z0010501	CLEANING AND PAINTING STEEL BRIDGE NO. 1	L SUM	1
Z0012148	BRIDGE DECK SCARIFICATION 3"	SQ YD	8075
Z0012754	STRUCTURAL REPAIR OF CONCRETE (DEPTH EQUAL TO OR LESS THAN 5 INCHES)	SQ YD	156
Z0016002	DECK SLAB REPAIR (FULL DEPTH, TYPE II)	SQ YD	81
Z0016200	DECK SLAB REPAIR (PARTIAL)	SQ YD	954
Z0018005	DRAINAGE SCUPPERS, DS-12M10	EACH	20
Z0018905	DRILL AND GROUT BARS	EACH	140
Z0024475	TUBULAR MARKER	EACH	2
Z0030850	TEMPORARY INFORMATION SIGNING	SQ FT	51.4
0	CLEANING AND PAINTING LIGHT POLES	L SUM	1
0	BASE WRAP, 24 INCH	EACH	12
0	PEDESTRIAN CANOPY	L SUM	1
0			0
0			0
0			0


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	Stanley Consultants Inc.
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PLOT DATE = 10/31/2018	DATE -	10-31-2018	REVISED -

	FABYAN PARKWAY SUMMARY OF QUANTITIES				C.H. SECTION		COUNTY	TOTAL SHEETS	SHEET NO.				
					8	17-0047	9-00-BR		KANE	57	4		
	SUMMANT OF QUANTITIES									CONTRACT	NO.		
	SCALE: NONE	SHEET 2	OF 2	SHEETS	STA.	TO STA.			ILLINOIS	FED. AI	ID PROJECT		

### FABYAN PARKWAY EXISTING TYPICAL SECTION

STA 73+75 TO STA 77+53.66 STA 91+52 TO STA 94+00

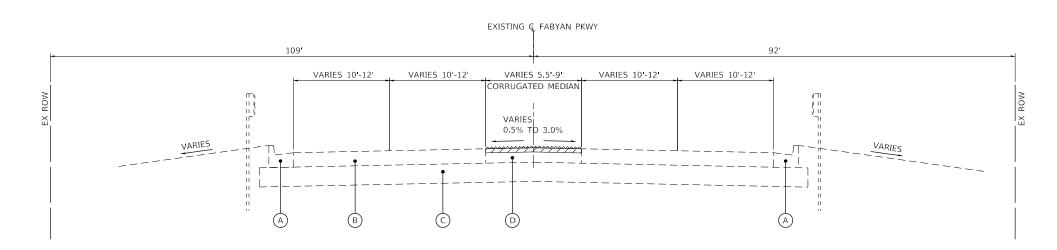

### FABYAN PARKWAY EXISTING TYPICAL SECTION

STA 90+66.17 TO STA 91+52

### **EXISTING LEGEND:**

- A COMBINATION CURB AND GUTTER, B-6.12
- B HMA PAVEMENT, 8"
- C SUB-BASE GRANULAR MATERIAL, 12"
- D CORRUGATED MEDIAN

MEDIAN REMOVAL PARTIAL DEPTH, 2-3/4"

Stanley Consultants Inc.


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SCALE: NONE

	FABYAN PARKWAY		C.H.	C.H. SECTION		COUNTY	TOTAL SHEETS	SHEET NO.	
EXISTING TYPICAL SECTIONS				8	17-00479-00-BR		KANE	57	5
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### FABYAN PARKWAY PROPOSED TYPICAL SECTION

STA 73+75 TO STA 77+53.66 STA 91+52 TO STA 94+00



### PROPOSED LEGEND:

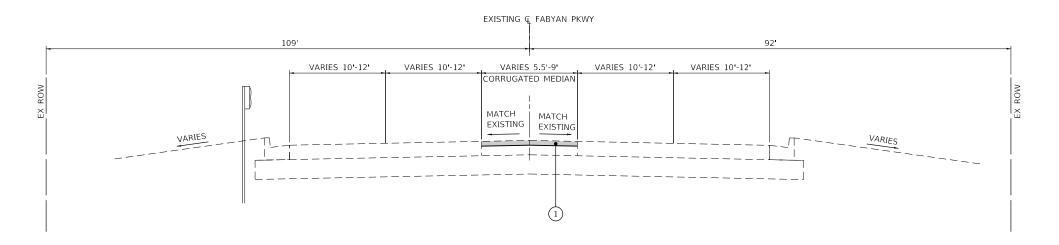1 POLYMERIZED HOT-MIX ASPHALT SURFACE COURSE, MIX "E", N70, 1 3/4"

### FABYAN PARKWAY PROPOSED TYPICAL SECTION

STA 90+66.17 TO STA 91+52

HOT-MIX ASPHALT MIXTURE REQUIREMENTS	S
MIXTURE TYPE	AIR VOIDS @Ndes
PAVEMENT RESURFACING	
POLY HMA SURF IL-9.5 mm MIX "E", N70	4% @ 70 Gyr.

THE UNIT WEIGHT USED TO CALCULATE ALL HMA SURFACE MIXTURE QUANTITIES IS 112 LBS/SQ YD/ IN.

THE "AC TYPE" FOR POLYMERIZED HMA MIXES SHALL BE "SBS/SBR PG 76-22" AND FOR NON-POLYMERIZED HMA THE "AC TYPE" SHALL BE "PG 64-22" UNLESS MODIFIED BY DISTRICT ONE SPECIAL PROVISIONS.

FOR HMA FULL DEPTH "AC TYPE" SEE SPECIAL PROVISIONS.


SCALE: NONE

FOR USE OF RECYCLED MATERIALS SEE SPECIAL PROVISIONS.

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ž	Stanley Consultants IIIc.
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Ξ	BSO Best Higgins Rood, Suite 130, Chicago, Illhois 6069-280 www.shallege.cuc.com Illhois Firm Registration No.: IB4-00633
	linals Firm Registration No. 184-00533 (773-693-9624

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PLOT DATE = 10/31/2018	DATE -	10-31-2018	REVISED -

FABYAN PARKWAY	C.H. SECTION		COUNTY	TOTAL SHEETS	SHEET NO.
PROPOSED TYPICAL SECTIONS	8	17-00479-00-BR	KANE	57	6
THOI COLD TITICAL SECTIONS			CONTRACT	NO.	
SHEET 2 OF 2 SHEETS STA. TO STA.		ILLINOIS FED. A	ID PROJECT		-

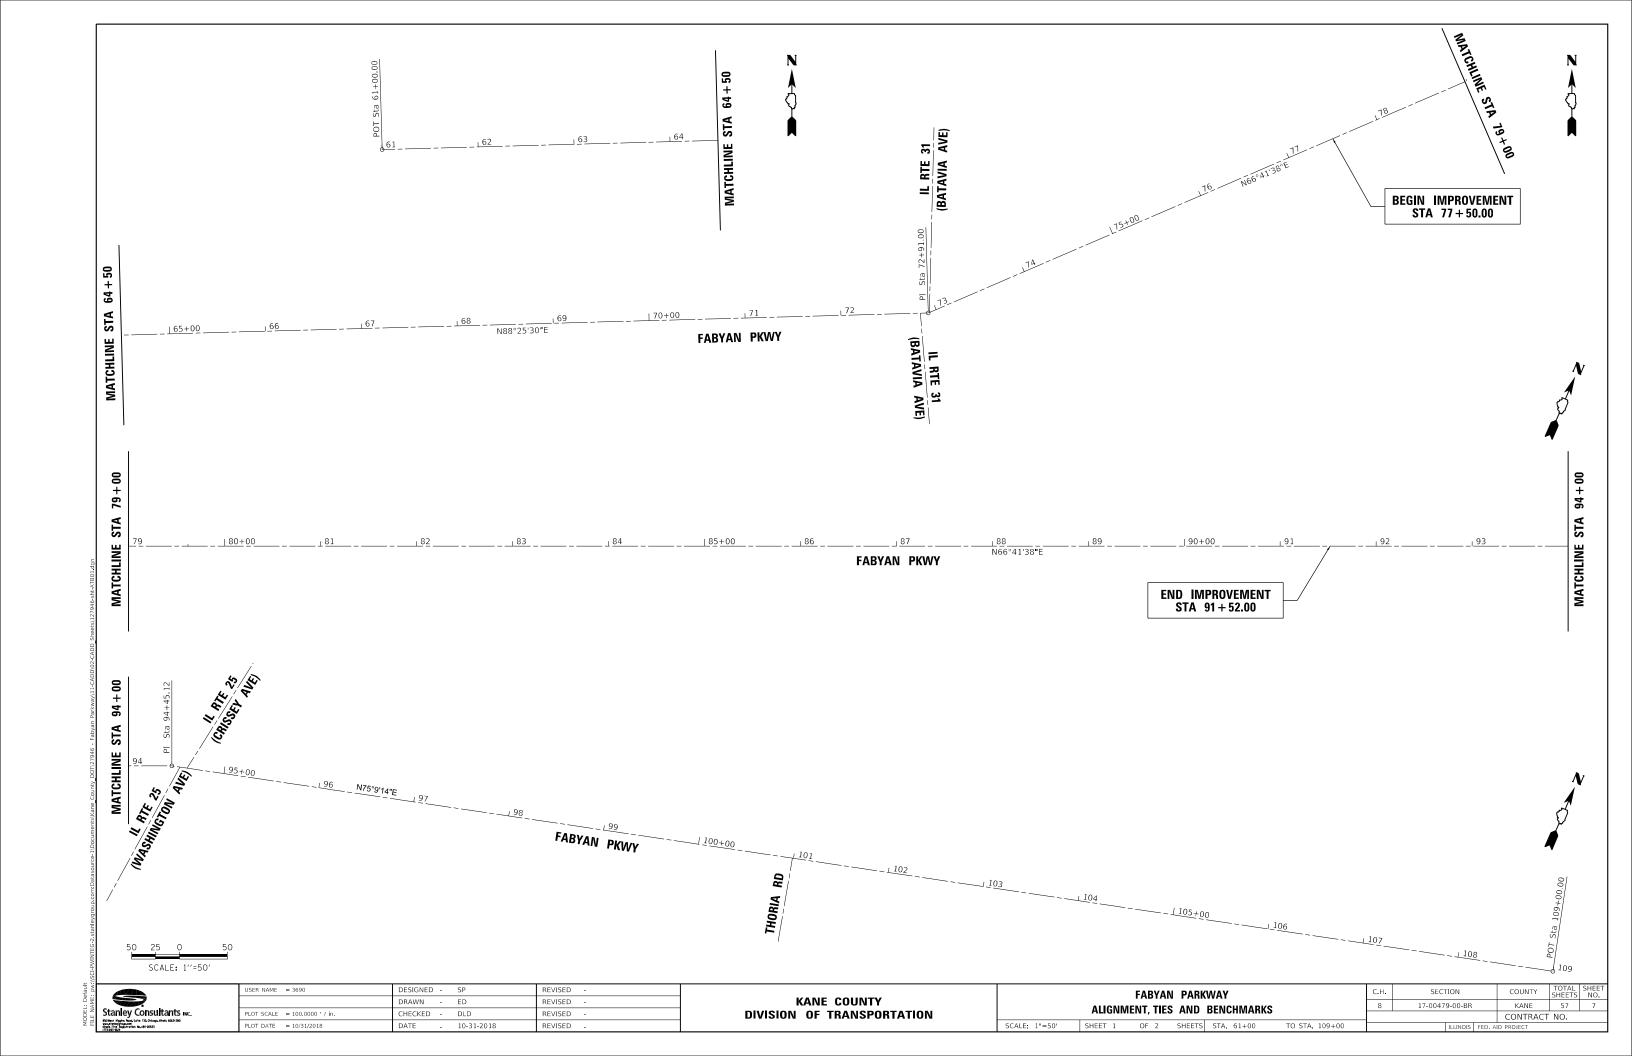

ALIGNMENT COORDINATES - CH8									
CH8	STATION	NORTHING	EASTING						
POT	61+00	1893072.6398	988386.5611						
PI	72+91.00	1893105.3773	989577.1164						
PI	94+45.12	1893957.6400	991555.4658						
POT	109+00	1894330.4161	992961.7798						

### **BENCHMARKS**:

CP #1 CUT CROSS ON NORTH CURB OF FABYAN PKWY AT EAST END OF PROJECT LIMITS

N 1894241.287 E 992499.068 EL 724.878

CP #2 CUT CROSS ON CURB AT SWC OF THORIA RD AND FABYAN PKWY

BM "A" NORTH BOLT ON FH EAST SIDE OF THORIA RD

CP #3 SET IRON ROD WITH CAP @ SEC OF ROUTE 25 AND FABYAN PKWY

N 1893925.015 E 991620.932 EL 711.650

CP #4 SET MAG NAIL IN ASPHALT PATH @ NWC OF ROUTE 25 AND FABYAN PKWY

N 1893986.503 E 991448.765 EL 704.283

BM "B" CUT CROSS ON SEC OF CONC SLAB/FOUNDATION ON NEC OF FABYAN BRIDGE OVER FOX RIVER

BM "C" CUT CROSS ON SOUTH FACE OF MAST ARM FOUNDATION ON NWC OF FOX RIVER AND FABYAN PKWY

N 1893309.30 E 989964.65 EL 694.524

CP #5 CUT CROSS ON CONCRETE SLAB @ NWC OF FOX RIVER AND FABYAN PKWY

N 1893287.019 E 989906.852 EL 694.386

CP #6 SET MAG NAIL IN ASPHALT PATH @ SWC OF ROUTE 31 AND FABYAN PKWY

N 1893065.256 E 989495.314 EL 703.680

CP #7 SET IRON ROD W/CAP IN PARKWAY ON SOUTH SIDE OF FABYAN PKWY

N 1893049.917 E 988741.965 EL 716.657

BM "D" SET BENCH TIE IN POWER POLE ON SOUTH SIDE OF FABYAN PKWY AT WEST END OF PROJECT

N 1893030.56 E 988588.29 EL 718.785

BM "E" DISK IN HEADWALL. NGS BM MF0014



JSER NAME = 3690 DESIGNED - SP REVISED DRAWN - ED REVISED CHECKED - DLD REVISED REVISED PLOT DATE = 10/31/2018 10-31-2018


KANE COUNTY **DIVISION OF TRANSPORTATION** 


FABYAN PARKWAY ALIGNMENT, TIES AND BENCHMARKS


COUNTY TOTAL SHEET NO.

KANE 57 8 SECTION COUNTY 17-00479-00-BR CONTRACT NO.

SHEET 2 OF 2 SHEETS STA.

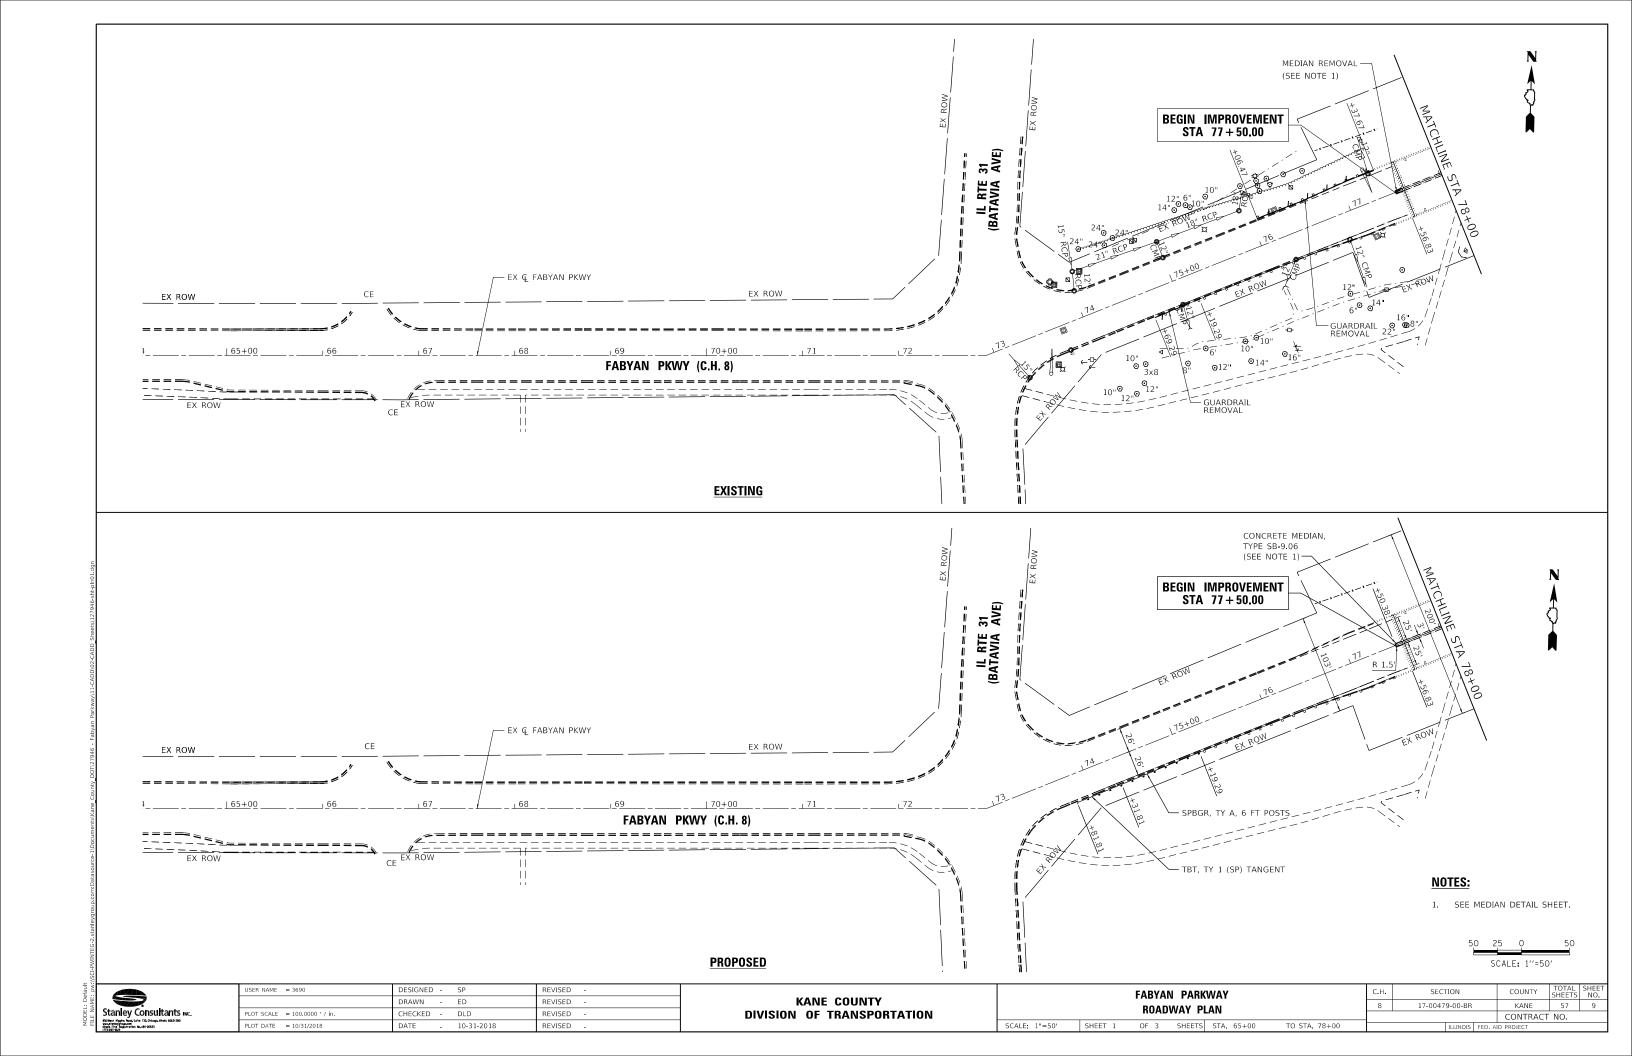

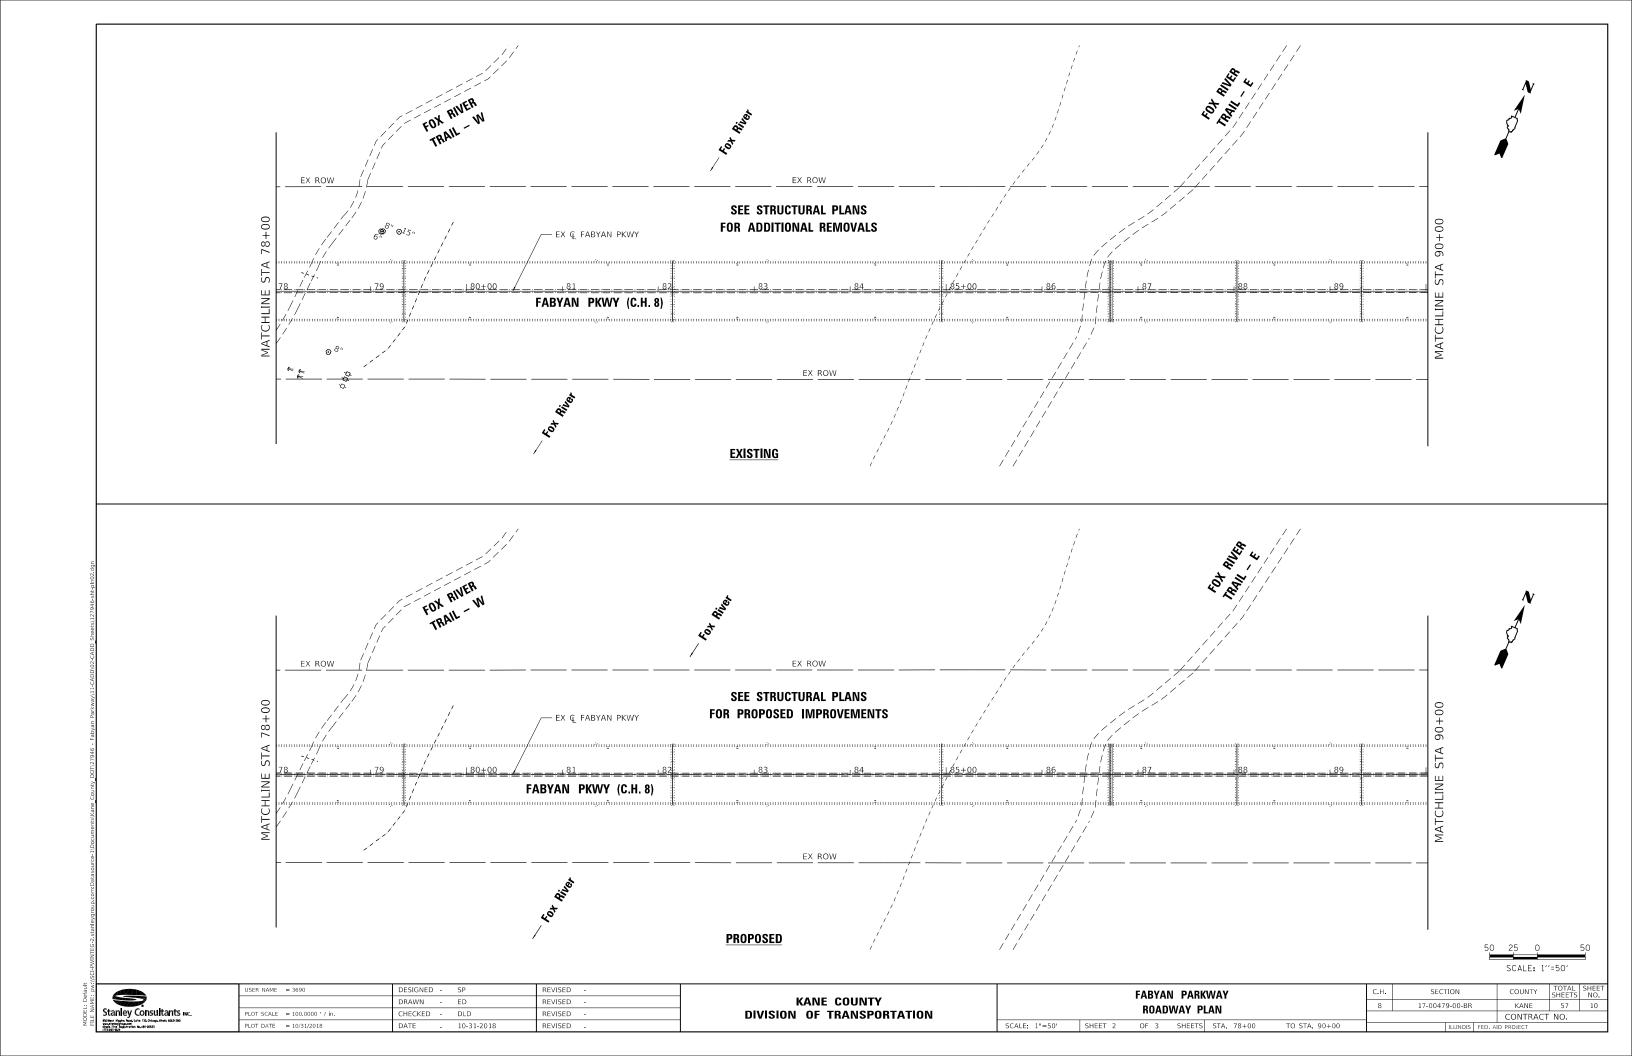

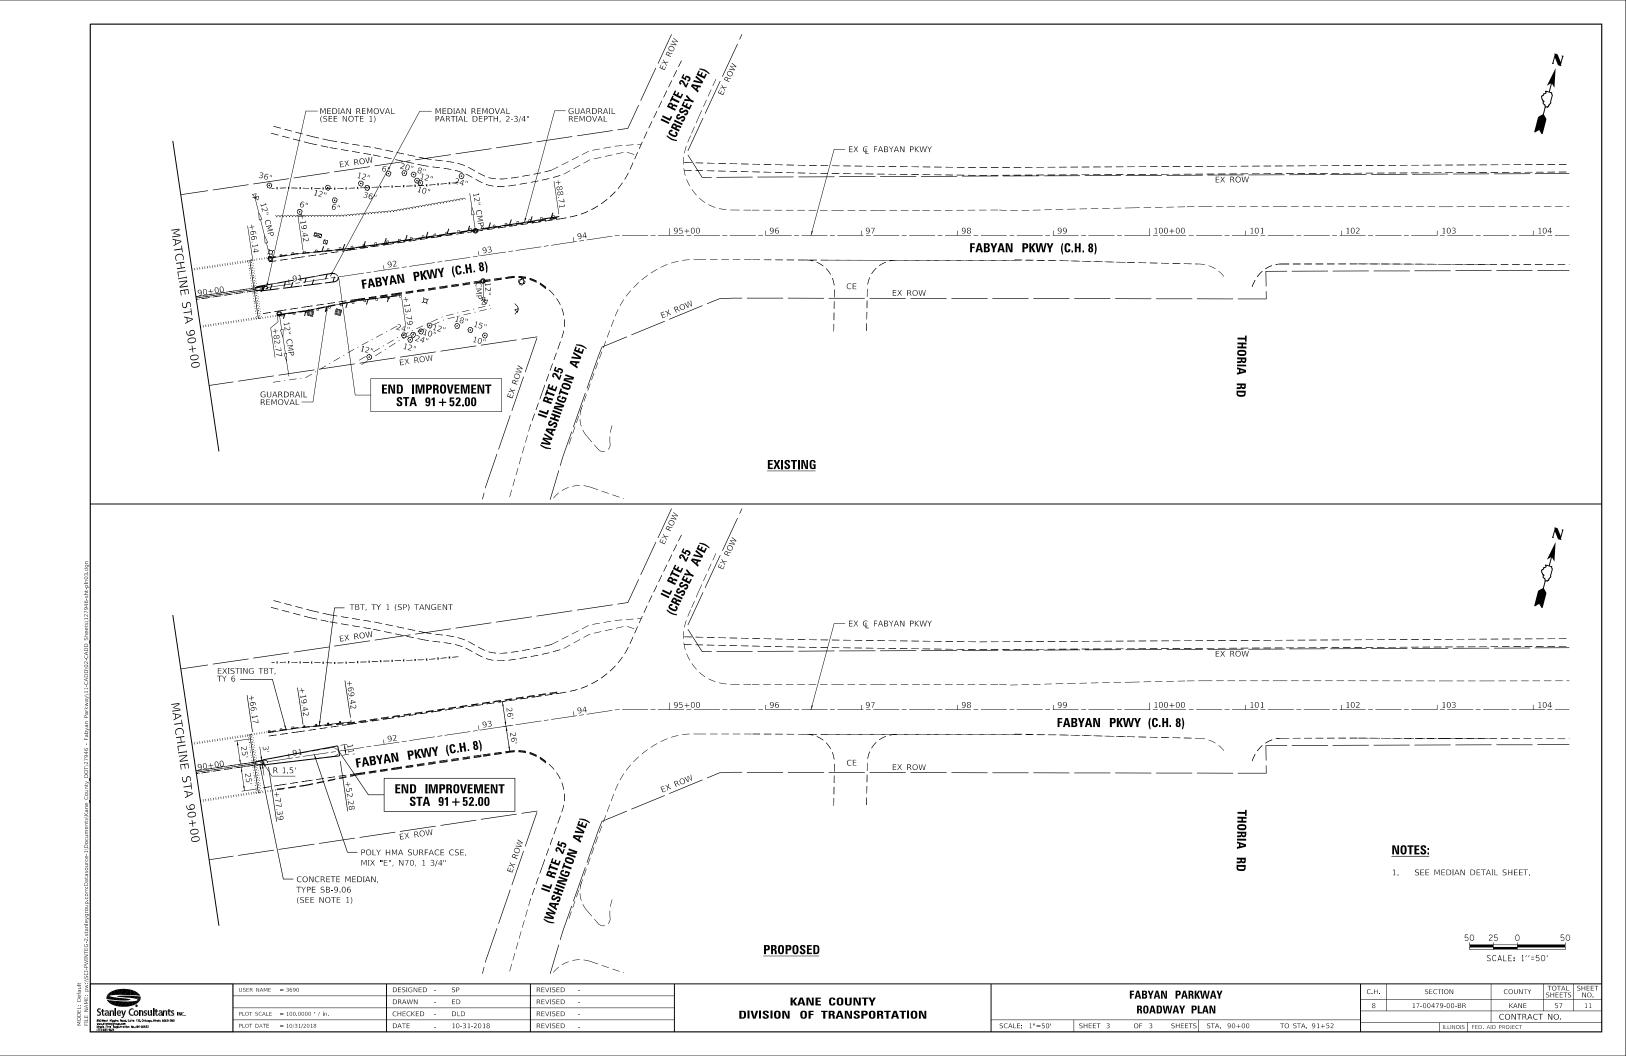

### **GENERAL NOTES**

- THE MAINTENANCE OF TRAFFIC PLANS SHALL SERVE AS A GUIDE FOR SAFE TRAFFIC DIVERSION DURING CONTRACT EXECUTION. THE CONTRACTOR MAY IMPROVE OR MODIFY THE TRAFFIC CONTROL PLANS TO MEET CONSTRUCTION NEEDS WITH THE APPROVAL OF THE ENGINEER, BUT NOT AT THE EXPENSE OF PUBLIC SAFETY OR CONVENIENCE. CHANGES TO THE TRAFFIC CONTROL PLAN SHALL BE SUBMITTED TO THE ENGINEER FOR REVIEW AND APPROVAL A MINIMUM OF 48 HOURS PRIOR TO THE SCHEDULED IMPLEMENTATION OF CHANGES.
- 2. ALL TRAFFIC CONTROL DEVICES SHALL BE IN ACCORDANCE WITH IDOT STANDARD 701901.
- ACCESS TO ALL PROPERTIES SHALL BE MAINTAINED.
- THE RESIDENT ENGINEER SHALL CONTACT THE COUNTY A MINIMUM OF 72 HOURS PRIOR TO THE PLACEMENT OF ANY TEMPORARY TRAFFIC CONTROL DEVICES.
- TRAFFIC CONTROL AT ALL SIDE ROADS, DRIVEWAYS AND ENTRANCES SHALL BE PER DISTRICT ONE DETAIL TC-10.
- DRIVEWAY ENTRANCE SIGNS SHALL BE INSTALLED AT ALL COMMERCIAL ENTRANCES AS PER DISTRICT ONE DETAIL TC-26.
- 7. ALL EXISTING SPEED LIMIT SIGNS SHALL BE REMOVED OR COVERED PRIOR TO STAGE 1.
- ALL TYPE ONE AND TYPE TWO BARRICADES WILL REQUIRE BALLAST (MINIMUM 2 SANDBAGS PER BARRICADE) TO HOLD THEM IN PLACE "SANDBAGS WILL BE PLACED ON BARRICADE LEGS. OVER STRIPED BOTTOM RAILS NOT FACING TRAFFIC. OVER UNSTRIPED BOTTOM RAILS, OR SUSPENDED FROM THE BARRICADE RAIL OR FRAME IN SUCH A MANNER SO THE BULK OF THE SAND IS AT LEAST 18 INCHES BELOW THE TOP OF THE BARRICADE.
- THE CONTRACTOR SHALL REMOVE EXISTING PAVEMENT MARKINGS THAT CONFLICT WITH THE STAGING. REMOVAL OF THE PAVEMENT MARKINGS WILL BE PAID FOR AS PAVEMENT MARKING REMOVAL - WATER BLASTING. CONTRACTOR SHALL NOT REMOVE EXISTING PAVEMENT MARKINGS BY GRINDING OR SANDBLASTING.
- 10. PAVEMENT MARKING TAPE, TYPE IV SHALL BE USED FOR WORK ZONE STAGES. THE COST OF THE PAVEMENT MARKING TAPE REMOVAL WILL BE PAID FOR AS TEMPORARY PAVEMENT MARKING REMOVAL. CONTRACTOR SHALL NOT REMOVE THE PAVEMENT MARKING TAPE BY GRINDING OR SANDBLASTING.
- 11. ACCESS SHAL BE MAINTAINED FOR BOTH OF THE FOX RIVER TRAILS AT ALL TIMES FOR

### MAINTENANCE OF TRAFFIC PAVEMENT MARKING

- (A) PAVEMENT MARKING LINE 4", DOUBLE YELLOW @ 11" CENTER
- (B) PAVEMENT MARKING LINE 4", YELLOW
- © PAVEMENT MARKING LINE 4", WHITE
- D PAVEMENT MARKING LINE 6", WHITE
- (E) PAVEMENT MARKING LINE 6", WHITE, 2' DASH, 6' SKIP
- (F) EXISTING PAVEMENT MARKING TO BE MAINTAINED
- (G) PAVEMENT MARKING LINE 4", WHITE, 10' DASH, 30' SKIP

- RESIDENT ENGINEER SHALL VERIFY LOCATION OF EXISTING PAVEMENT MARKINGS
- INSTALL TEMPORARY TRAFFIC CONTROL DEVICES.

### STAGE 1 CONSTRUCTION:

BRIDGE:

1. REMOVE AND REPLACE EXISTING MEDIAN.

REMOVE EXISTING CORRUGATED MEDIAN EAST OF BRIDGE FROM STA 90+73 TO STA 91+52 AND REPLACE WITH HMA BASE COURSE.

**LEGEND** 

WORK ARFA

BARRICADES OR DRUMS WITH

STEADY BURNING LIGHT 50' CENTERS IN TANGENT

20' CENTERS IN TAPER

TRAFFIC CONTROL SIGN

TRAFFIC DIRECTION

ARROW BOARD

REMOVE AND REPLACE RAMPED BARRIER MEDIAN NOSE EAST OF BRIDGE FROM STA 90+65 TO STA 90+73. REMOVE AND REPLACE RAMPED BARRIER MEDIAN NOSE WEST OF BRIDGE FROM STA 77+50 STA TO 77+58.

### **STAGE 2 CONSTRUCTION:**

1. BRIDGE DECK SCARIFICATION AND CONCRETE LATEX OVERLAY ON EXISTING EASTBOUND LANES.

- REMOVE AND REPLACE GUARDRAIL ON THE SOUTHWEST SIDE OF THE BRIDGE AS SHOWN ON THE PLANS.
- REMOVE EXISTING GUARDRAIL ON THE SOUTHEAST SIDE OF THE BRIDGE AS SHOWN ON THE PLANS.


### STAGE 3 CONSTRUCTION:

1. BRIDGE DECK SCARIFICATION AND CONCRETE LATEX OVERLAY ON EXISTING WESTBOUND LANES.

- REMOVE EXISTING GUARDRAIL ON NORTHWEST SIDE OF THE BRIDGE AS SHOWN ON THE PLANS.
- REMOVE AND REPLACE GUARDRAIL ON THE NORTHEAST SIDE OF THE BRIDGE AS SHOWN ON THE PLANS.


### STAGE 4 CONSTRUCTION:

1. PAVEMENT MARKING INSTALLATION AS SHOWN ON THE PLANS USING IDOT HIGHWAY STANDARD 701426-09.

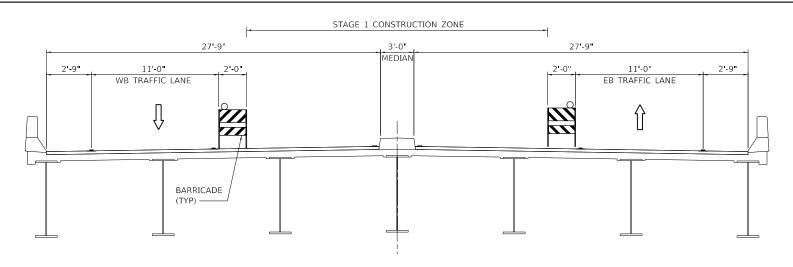

### **CROSS SECTION - STAGE 1**

LOOKING EAST

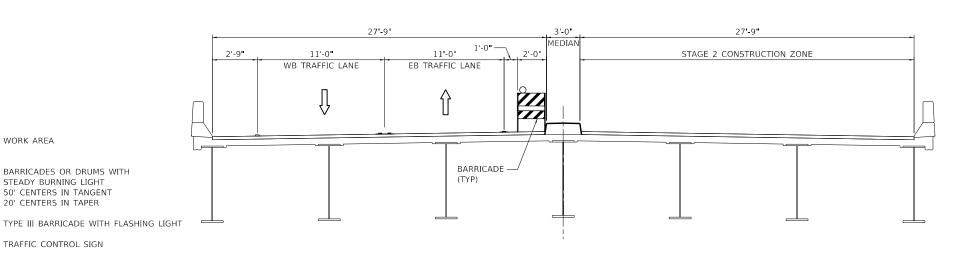

**CROSS SECTION - STAGE 2** LOOKING EAST

27**'-**9" 27'-9" MEDIAN - 1 -0 11'-0" STAGE 3 CONSTRUCTION ZONE 11-0 WB TRAFFIC LANE EB TRAFFIC LANE - BARRICADE (TYP)

> CROSS SECTION - STAGE 3 LOOKING EAST


**FABYAN PARKWAY** KANE COUNTY MAINTENANCE OF TRAFFIC STAGING NOTES AND TYPICAL SECTIONS



DESIGNED SP JSER NAME = 3690 REVISED DRAWN - ED REVISED REVISED OT SCALE = 2.0000 / in. REVISED LOT DATE = 10/31/2018 10-31-2018

**DIVISION OF TRANSPORTATION** 

SECTION COUNTY 17-00479-00-BR KANE 57 CONTRACT NO. SHEET 1 OF 1 SHEETS STA.

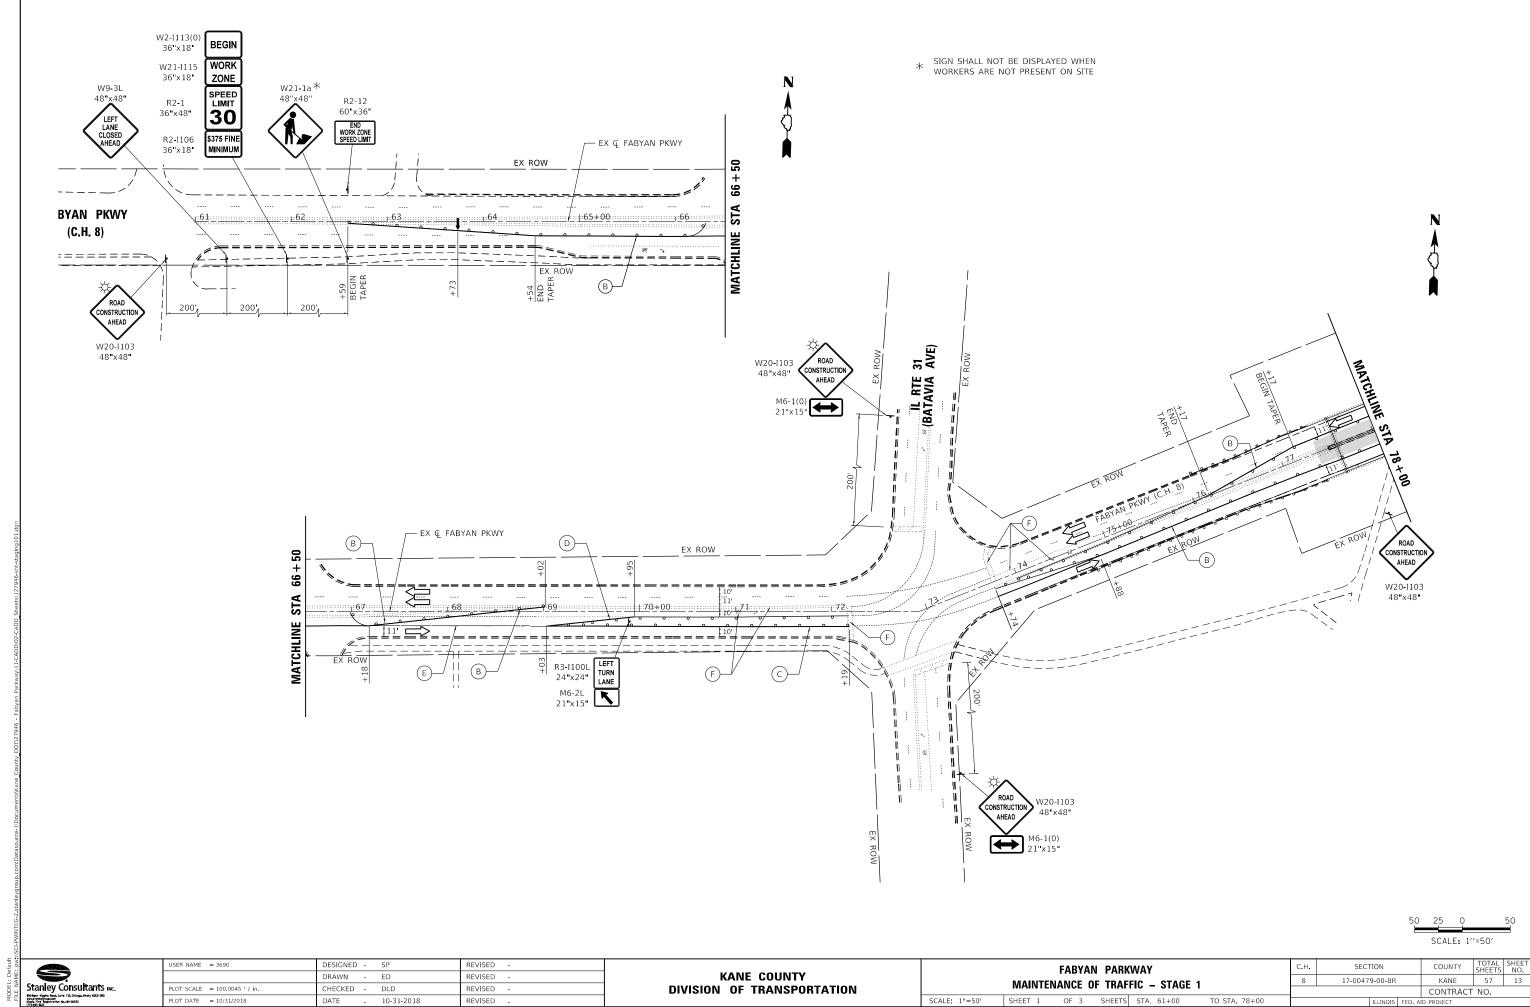


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**DIVISION OF TRANSPORTATION** 

MAINTENANCE OF TRAFFIC - STAGE 1 SHEET 1 OF 3 SHEETS STA. 61+00

17-00479-00-BR TO STA. 78+00

KANE 57 13 CONTRACT NO.

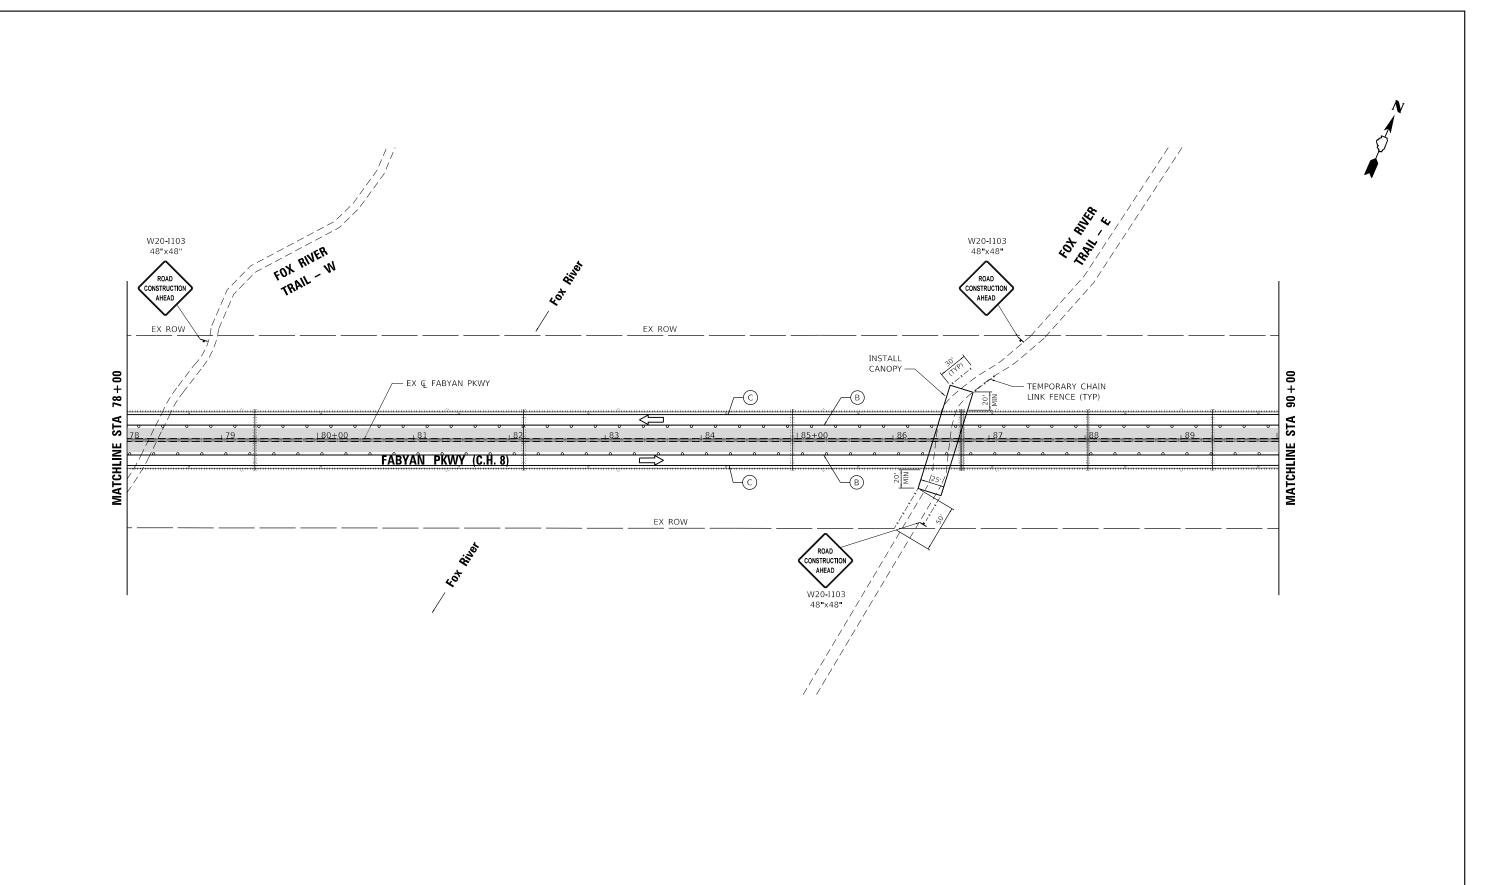

SCALE: 1"=50"



USER NAME = 3690	DESIGNED - SP	REVISED -
	DRAWN - ED	REVISED -
PLOT SCALE = 100.0000 ' / in.	CHECKED - DLD	REVISED -
PLOT DATE = 10/31/2018	DATE - 10-31-2018	REVISED -


KANE COUNTY					
DIVISION	OF TRANSPORTATION				


FABYAN PARKWAY							
MAINTENANCE OF TRAFFIC - STAGE 1							
	WANTE	TAITOL O	1111/11	IIO - DIAGE	•		
SCALE: 1"=50"	SHEET 2	OF 3	SHEETS	STA. 78+00	TO STA. 90+00		


COUNTY TOTAL SHEET NO.

KANE 57 14

CONTRACT NO. SECTION 17-00479-00-BR

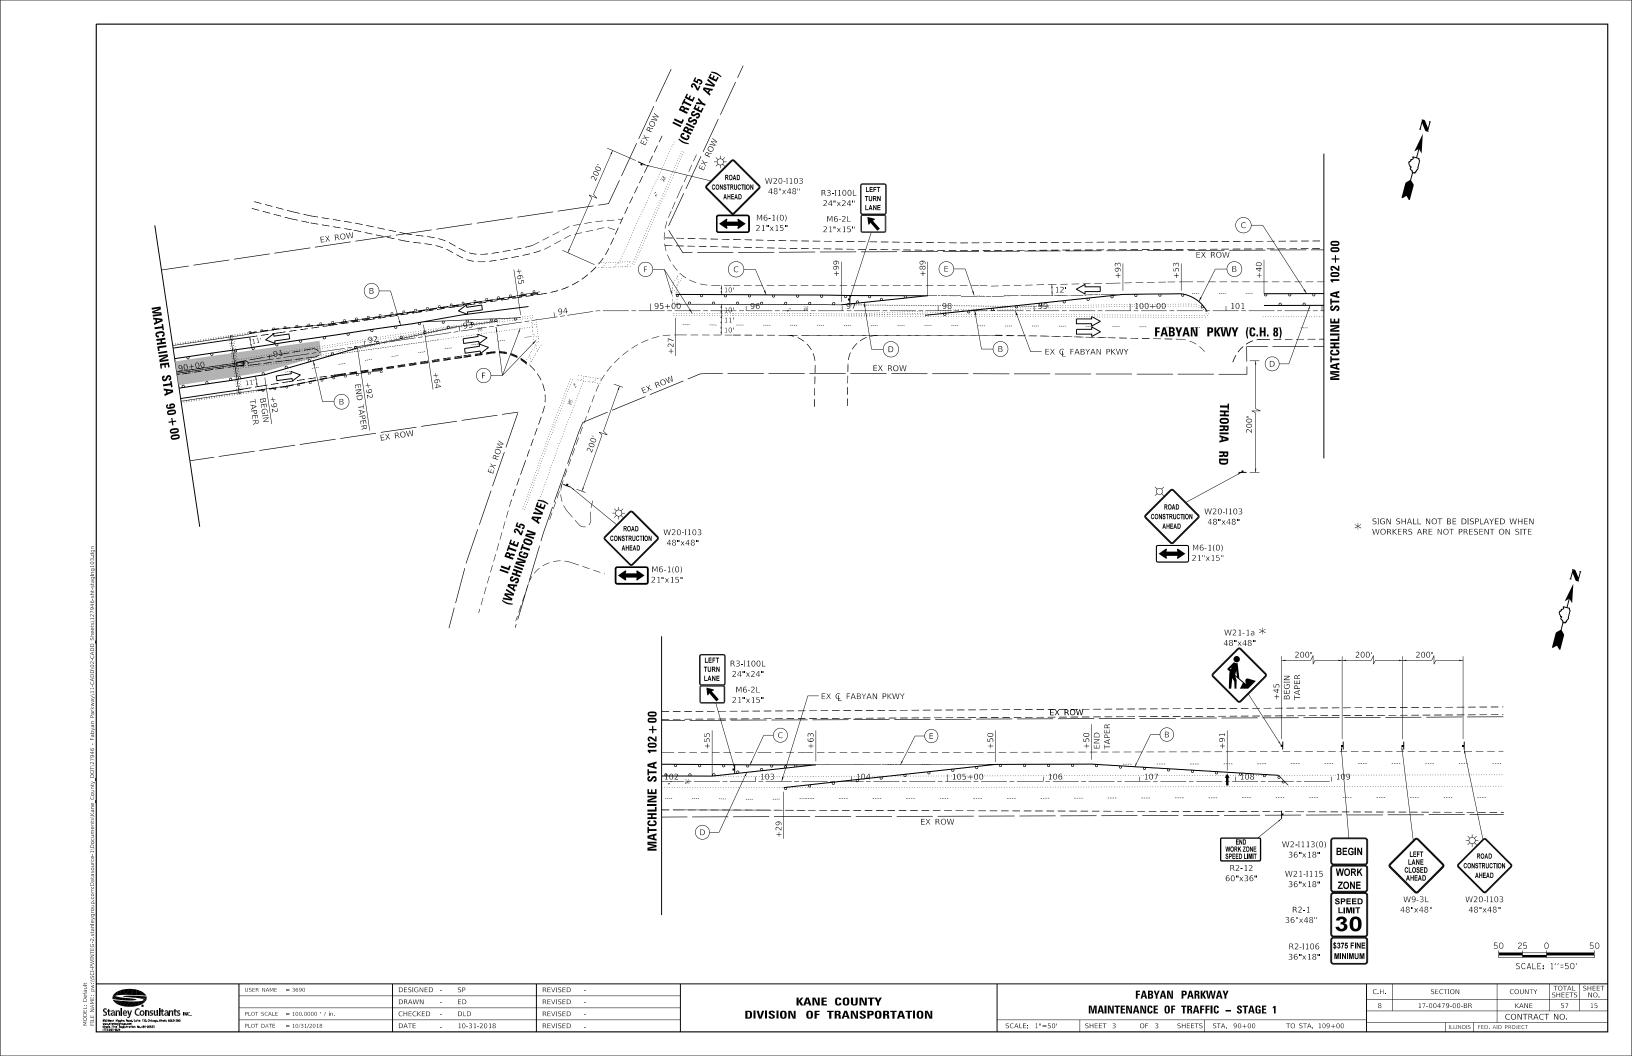

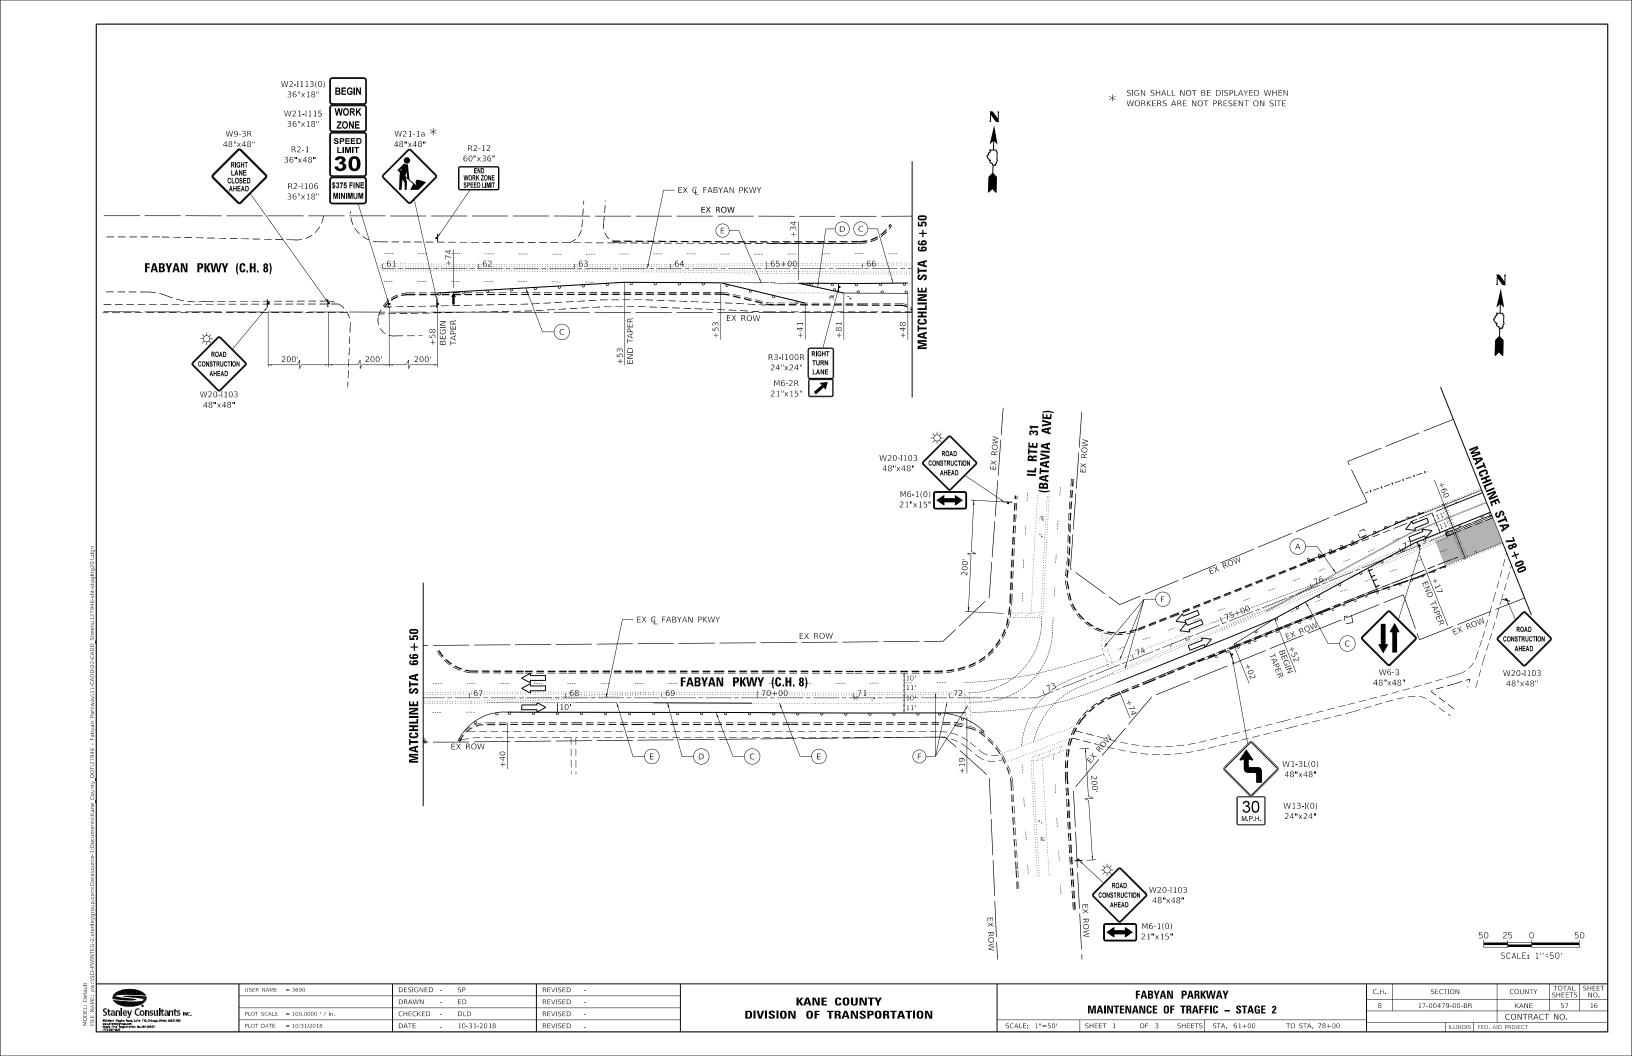

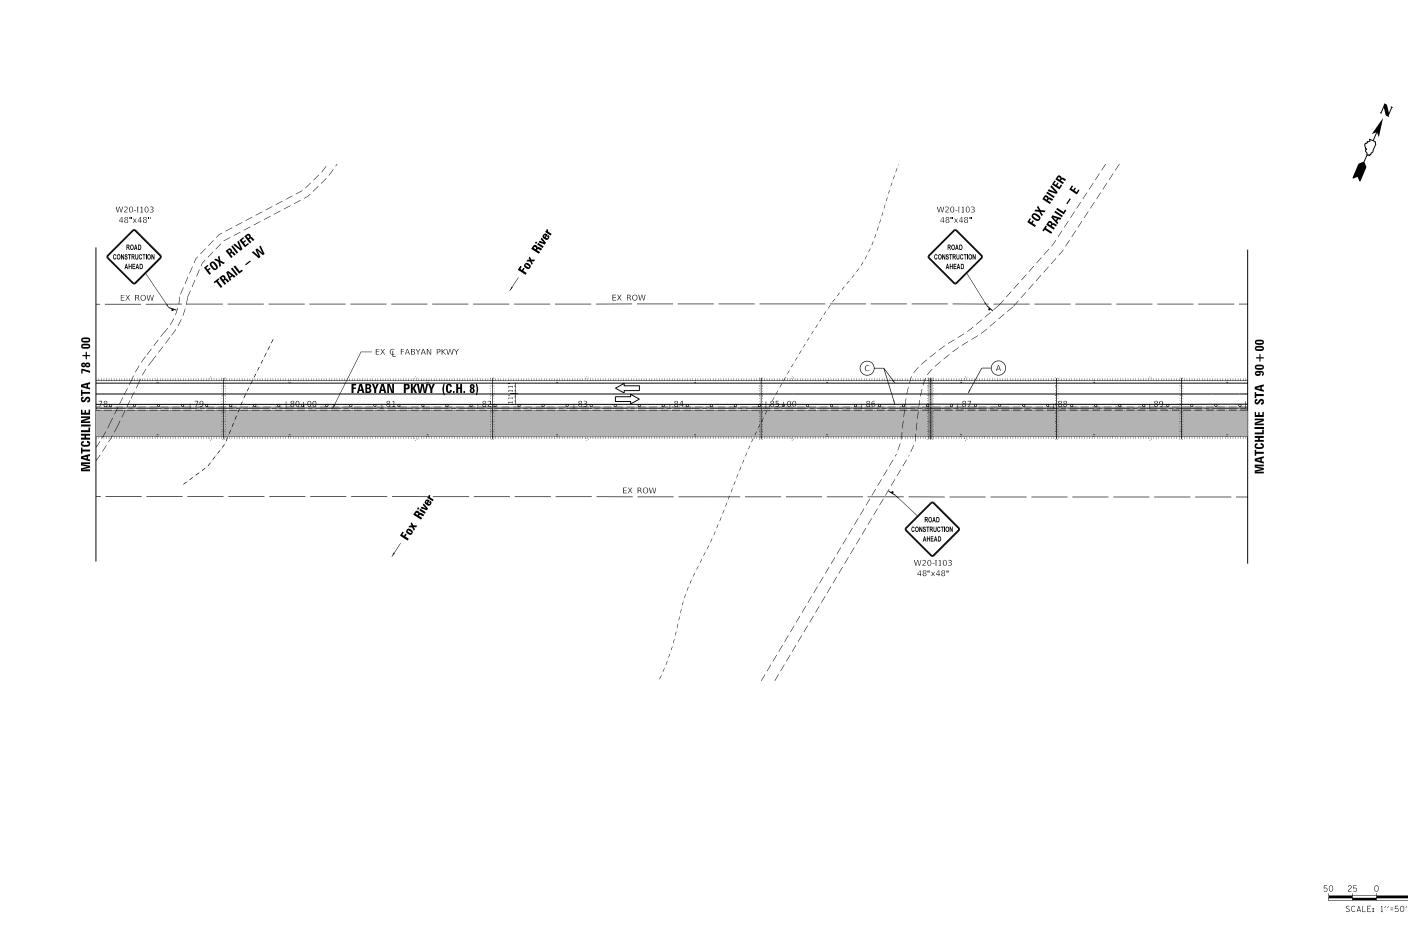


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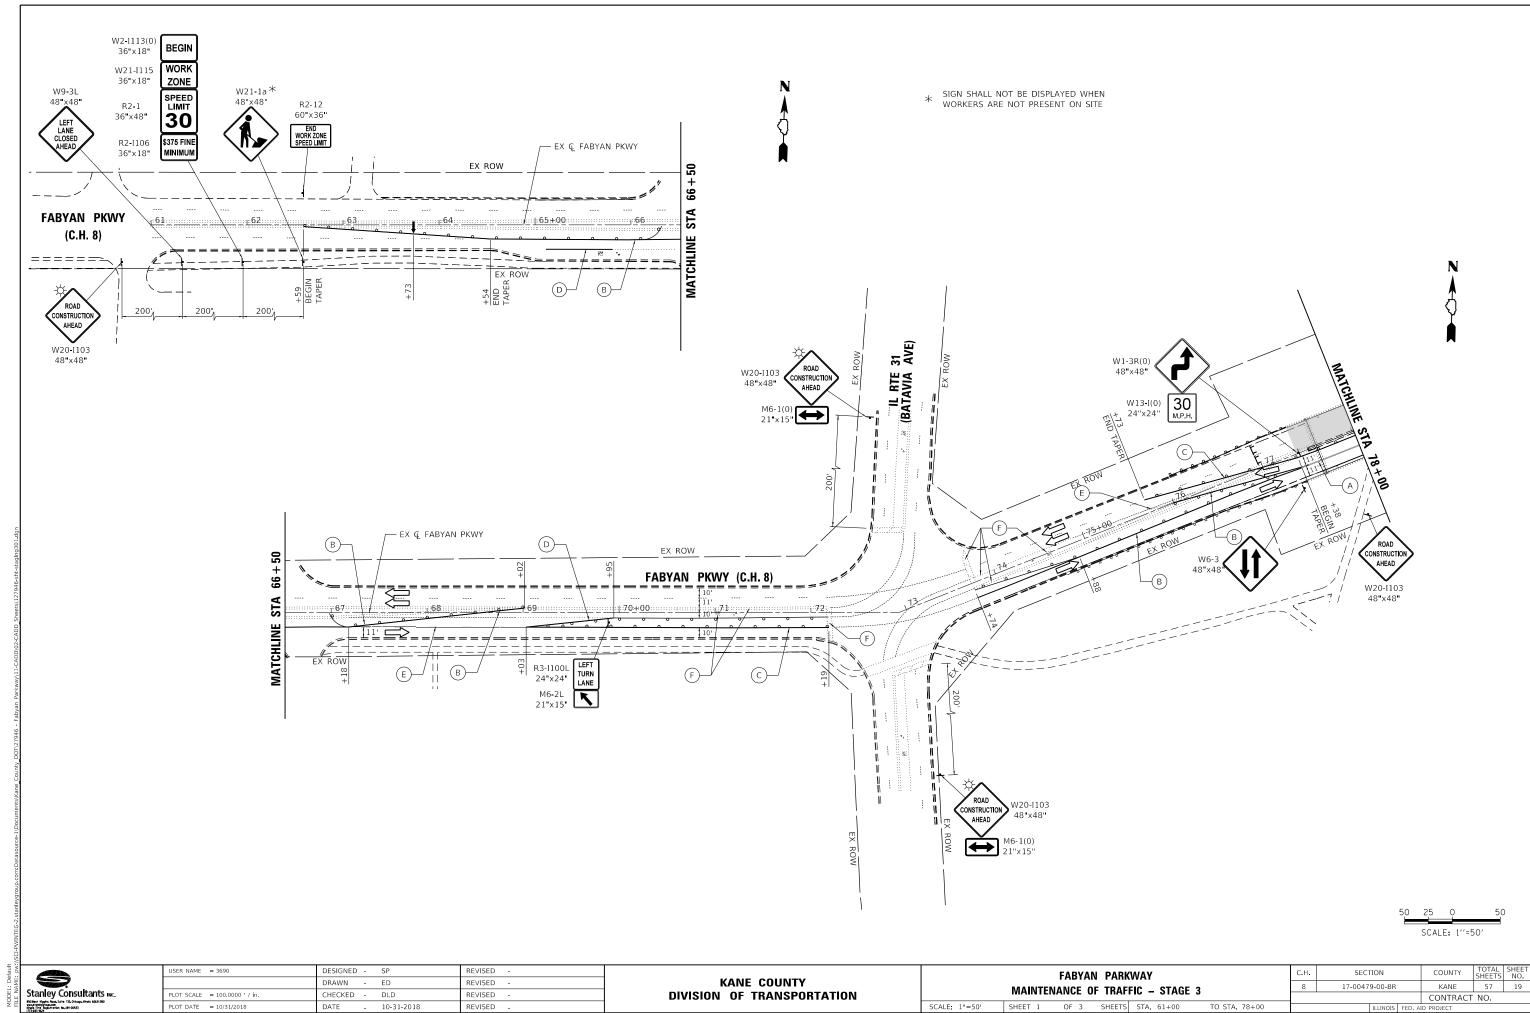
KANE COUNTY DIVISION OF TRANSPORTATION

FABYAN PARKWAY MAINTENANCE OF TRAFFIC - STAGE 2 SCALE: 1"=50' SHEET 2 OF 3 SHEETS STA. 78+00 TO STA. 90+00

COUNTY TOTAL SHEET NO. KANE 57 17 SECTION COUNTY 17-00479-00-BR


CONTRACT NO.



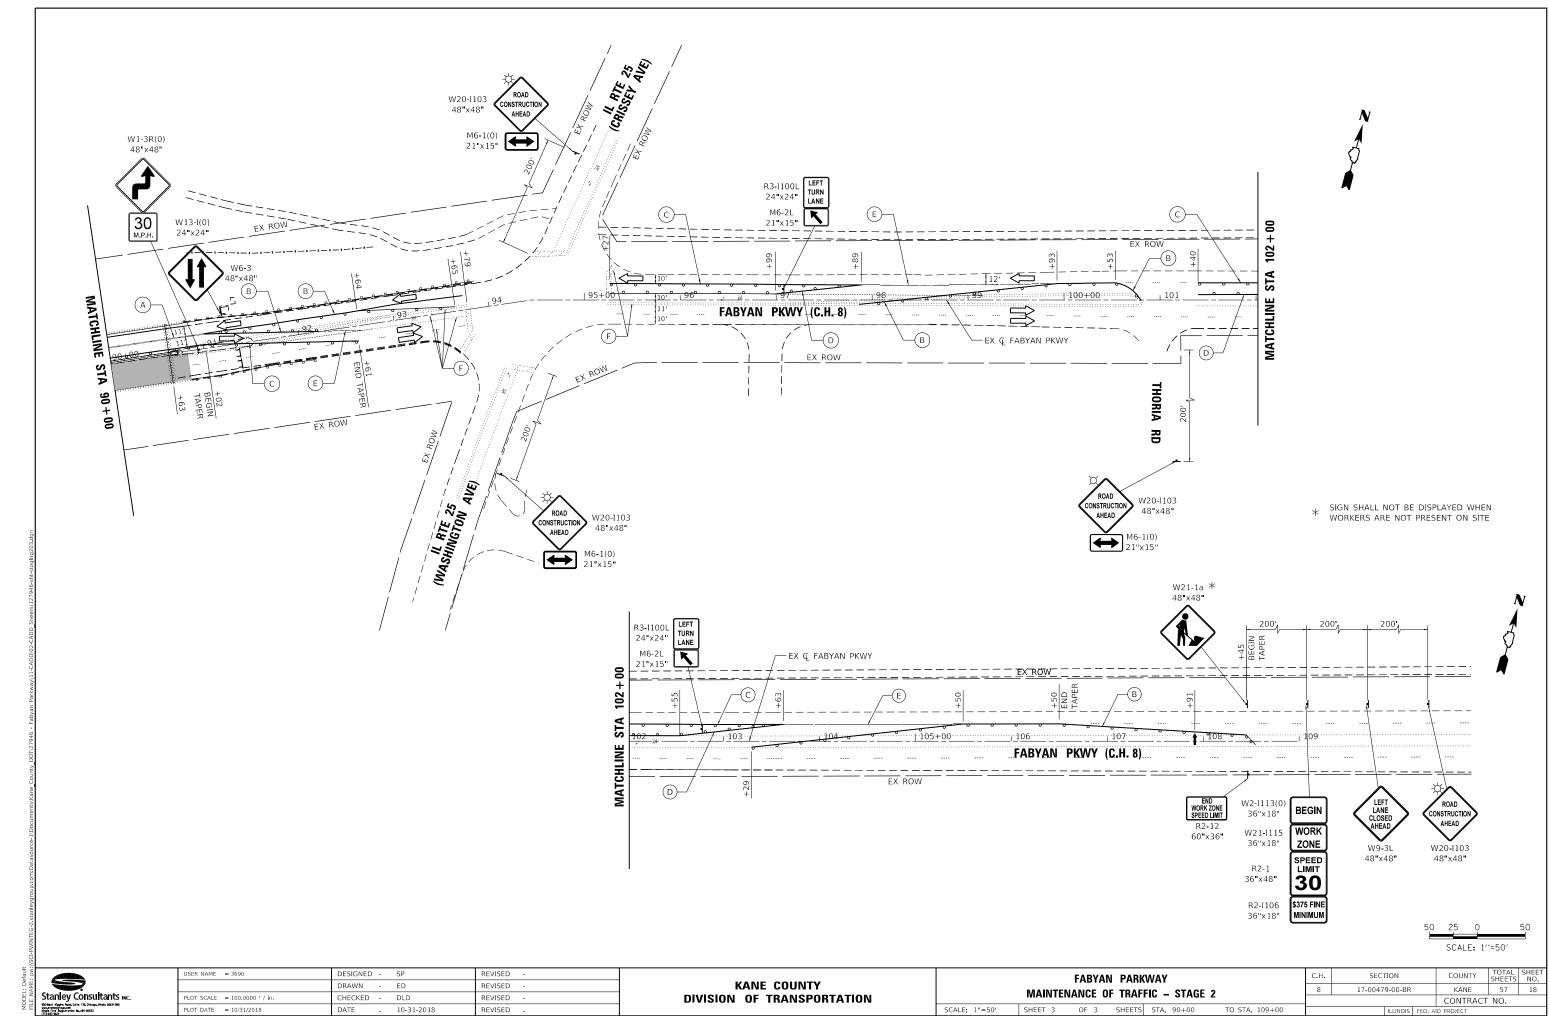

PLOT DATE = 10/31/2018 10-31-2018

OF 3 SHEETS STA. 61+00 TO STA. 78+00

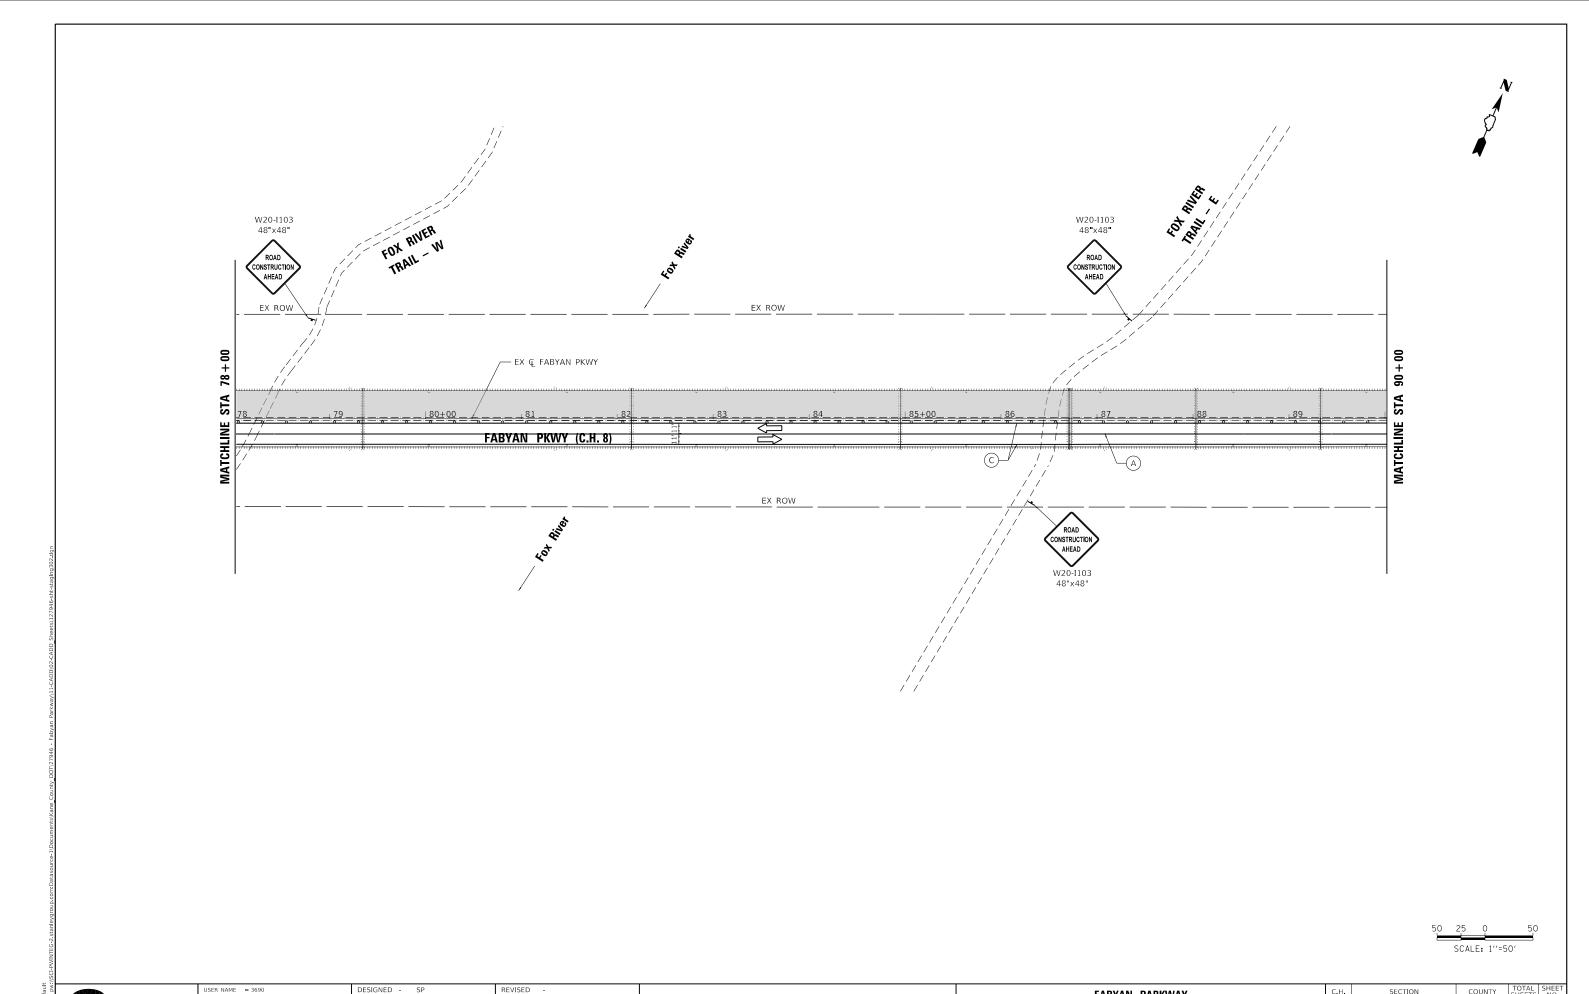

Stanley Consultants INC.

800 Near Single Roots Safe 178, Orloops World 6403-200

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707 New 756 Orloops World 6403-200

707 New 756 Orloops

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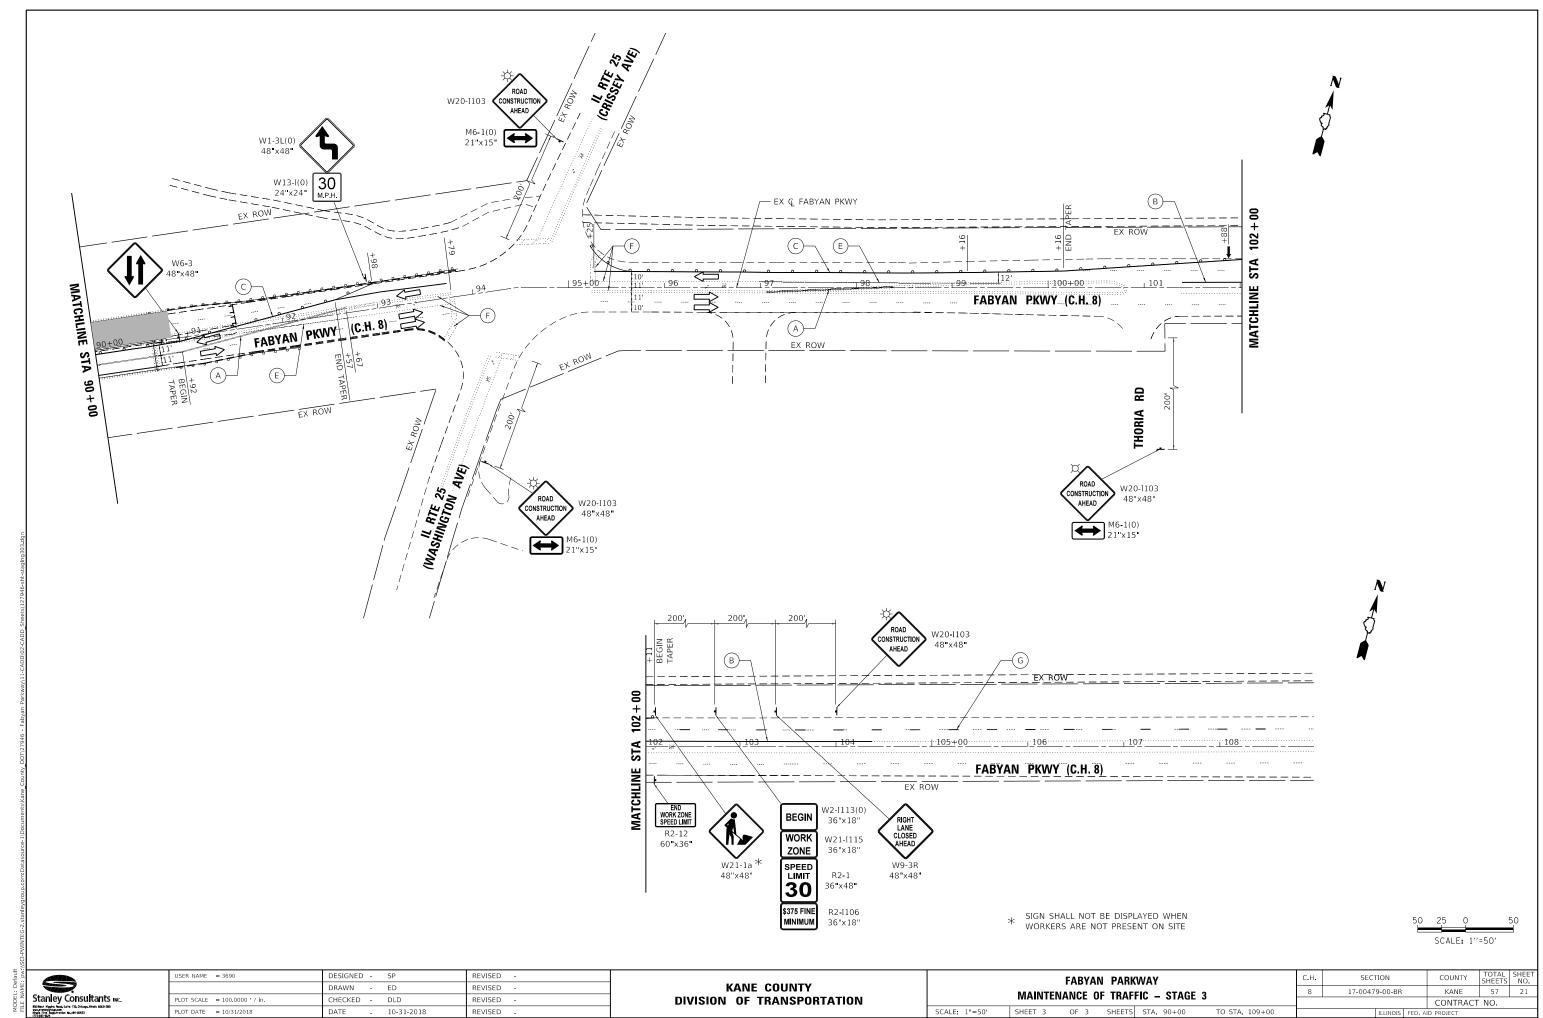
KANE COUNTY DIVISION OF TRANSPORTATION

FABYAN PARKWAY MAINTENANCE OF TRAFFIC - STAGE 3 SHEET 2 OF 3 SHEETS STA. 78+00 TO STA. 90+00

COUNTY TOTAL SHEET NO.

KANE 57 20

CONTRACT NO. SECTION 17-00479-00-BR



OF 3 SHEETS STA. 90+00

TO STA. 109+00

### **EROSION CONTROL GENERAL NOTES**

- 1. THE KANE COUNTY DIVISION OF TRANSPORTATION WILL FOLLOW THE IDOT SUGGESTED POLICY FOR ADMINISTRATION OF THE NPDES REQUIREMENTS. THE ILLINOIS DEPARTMENT OF TRANSPORTATION SUGGESTED POLICY IS OUTLINED IN THE IDOT BLR MEMO ON EROSION AND SEDIMENT CONTROL POLICY, #02-22.
- 2. SEDIMENT AND EROSION CONTROL DEVICES SHALL BE FUNCTIONAL BEFORE THE PROJECT SITE IS OTHERWISE DISTURBED
- 3. UNLESS OTHERWISE INDICATED, ALL VEGETATIVE AND STRUCTURAL EROSION AND SEDIMENT CONTROL PRACTICES WILL BE CONSTRUCTED ACCORDING TO MINIMUM STANDARDS AND SPECIFICATIONS IN IDOT STANDARD SPECIFICATIONS FOR ROAD AND BRIDGE CONSTRUCTION AND THE ILLINOIS URBAN MANUAL LATEST UPDATE.
- 4. A COPY OF THE APPROVED EROSION AND SEDIMENT CONTROL PLAN SHALL BE MAINTAINED ON SITE AT ALL TIMES. A COPY SHALL ALSO BE KEPT AT KDOT PERMIT DEPARTMENT.
- 5. THE CONTRACTOR IS RESPONSIBLE FOR INSTALLATION OF ANY ADDITIONAL EROSION CONTROL MEASURES NECESSARY TO PREVENT EROSION AND SEDIMENTATION AS DETERMINED BY THE REGULATORY AUTHORITIES. THESE ADDITIONAL ITEMS ARE INCLUDED IN THE CONTRACT.
- 6. IT IS THE RESPONSIBILITY OF THE GENERAL CONTRACTOR TO INFORM ANY SUB-CONTRACTORS WHO MAY PERFORM WORK ON THIS PROJECT, OF THE REQUIREMENTS IN IMPLEMENTING AND MAINTAINING THESE EROSION CONTROL PLANS AND THE NATIONAL POLLUTANT DISCHARGE ELIMINATION SYSTEMS NPDES PERMIT REQUIREMENTS SET FORTH BY THE ILLINOIS EPA.
- 7. PERIMETER EROSION CONTROL BARRIER SHALL BE ERECTED ADJACENT TO TEMPORARY CONSTRUCTION FENCE IN SELECTED LOCATIONS. THE RESIDENT ENGINEER SHALL HAVE FINAL DETERMINATION OF THE PLACEMENT AND LOCATION OF THE PERIMETER EROSION CONTROL BARRIER.
- 8. CLEANING OF VEHICLES AND EQUIPMENT SHALL BE PERFORMED IN A MANNER TO REDUCE THE AMOUNT OF POLLUTANTS TRIBUTARY TO STORM SEWERS AND OPEN WATERS TO THE MAXIMUM EXTENT POSSIBLE.
- 9. ALL NECESSARY MEASURES SHALL BE TAKEN TO CONTAIN ANY FUEL OR POLLUTION RUN OFF. LEAKY EQUIPMENT OR SUPPLIES SHALL BE IMMEDIATELY REPAIRED OR REMOVED FROM THE SITE.
- 10. THE EROSION CONTROL MEASURES INDICATED ON THE PLANS ARE THE MINIMUM REQUIREMENTS. ADDITIONAL MEASURES MAY BE REQUIRED, AS DIRECTED BY THE ENGINEER.
- 11. THE MAINTENANCE AND REPAIR OR REPLACEMENT OF EROSION CONTROL ITEMS, WHEN DIRECTED BY THE ENGINEER, WILL NOT BE PAID FOR SEPERATELY, BUT SHALL BE INCLUDED IN THE COST OF THE ASSOCIATED PAY
- 12. DUST CONTROL MEASURES WILL BE IMPLEMENTED IN ACCORDANCE WITH ARTICLE 107.36 OF THE STANDARD SPECIFICATIONS.


- 13. WHENEVER DURING CONSTRUCTION OPERATIONS, LOOSE MATERIAL IS DEPOSITED IN THE FLOW LINE OF GUTTERS, DRAINAGE STRUCTURES, DITCHES, ETC., SUCH THAT THE NATURAL FLOW LINE OF WATER IS OBSTRUCTED, THE LOOSE MATERIAL SHALL BE REMOVED AT THE CLOSE OF EACH WORKING DAY. AT THE CONCLUSION OF THE CONSTRUCTION OPERATIONS, ALL DRAINAGE STRUCTURES AND FLOW LINES SHALL BE FREE FROM DIRT AND DEBRIS. THE CONTRACTOR'S FAILURE TO PROVIDE THE ABOVE WILL PRECLUDE ANY POSSIBLE ADDED COMPENSATION REQUESTED DUE TO DELAYS OR UNSUITABLE MATERIAL CREATED AS A
- 14. ALL PERIMETER EROSION BARRIER AND TEMPORARY FENCE SHALL BE INSTALLED WITHIN THE TEMPORARY EASEMENT, PROPOSED RIGHT-OF-WAY OR EXISTING RIGHT-OF-WAY.
- 15. WHERE APPLICABLE, PERIMETER EROSION BARRIER SHALL BE PLACED AT THE RIGHT-OF-WAY DURING CONSTRUCTION AND LEFT IN PLACE UNTIL NEW SEEDING IS 90% ESTABLISHED.
- 16. TEMPORARY EROSION CONTROL BLANKET SHALL BE PLACED IN ACCORDANCE WITH THE REQUIREMENTS OF THE STANDARD SPECIFICATIONS AFTER TEMPORARY EROSION CONTROL SEEDING HAS BEEN COMPLETED AS SHOWN ON THE PLANS, OR AS DIRECTED BY THE ENGINEER.
- 17. THE CONSTRUCTION LIMITS WILL BE STAKED BY THE ENGINEER PRIOR TO COMMENCING CONSTRUCTION. THE CONSTRUCTION LIMITS MAY BE ADJUSTED BY THE ENGINEER AND NO ADDITIONAL COMPENSATION WILL BE PAID TO THE CONTRACTOR FOR CHANGED CONSTRUCTION LIMITS.
- 18. ALL EROSION AND SEDIMENT CONTROL (ESC) MEASURES SHOULD BE CHECKED WEEKLY AND AFTER EACH RAINFALL, 0.5 INCHES OR GREATER IN A 24 HOUR PERIOD, OR EQUIVALENT SNOWFALL. ADDITIONALLY DURING WINTER MONTHS, ALL MEASURES SHOULD BE CHECKED AFTER EACH SIGNIFICANT SNOWFALL.
- 19. ALL DISTURBED AREAS SHALL RECEIVE A MINIMUM SEEDING CLASS 2A, FERTILIZER NUTRIENTS, AND EROSION CONTROL BLANKET (NORTH AMERICAN BRAND), OR APPROVED EQUIVALENT, OR SALT TOLERANT SOD WITH


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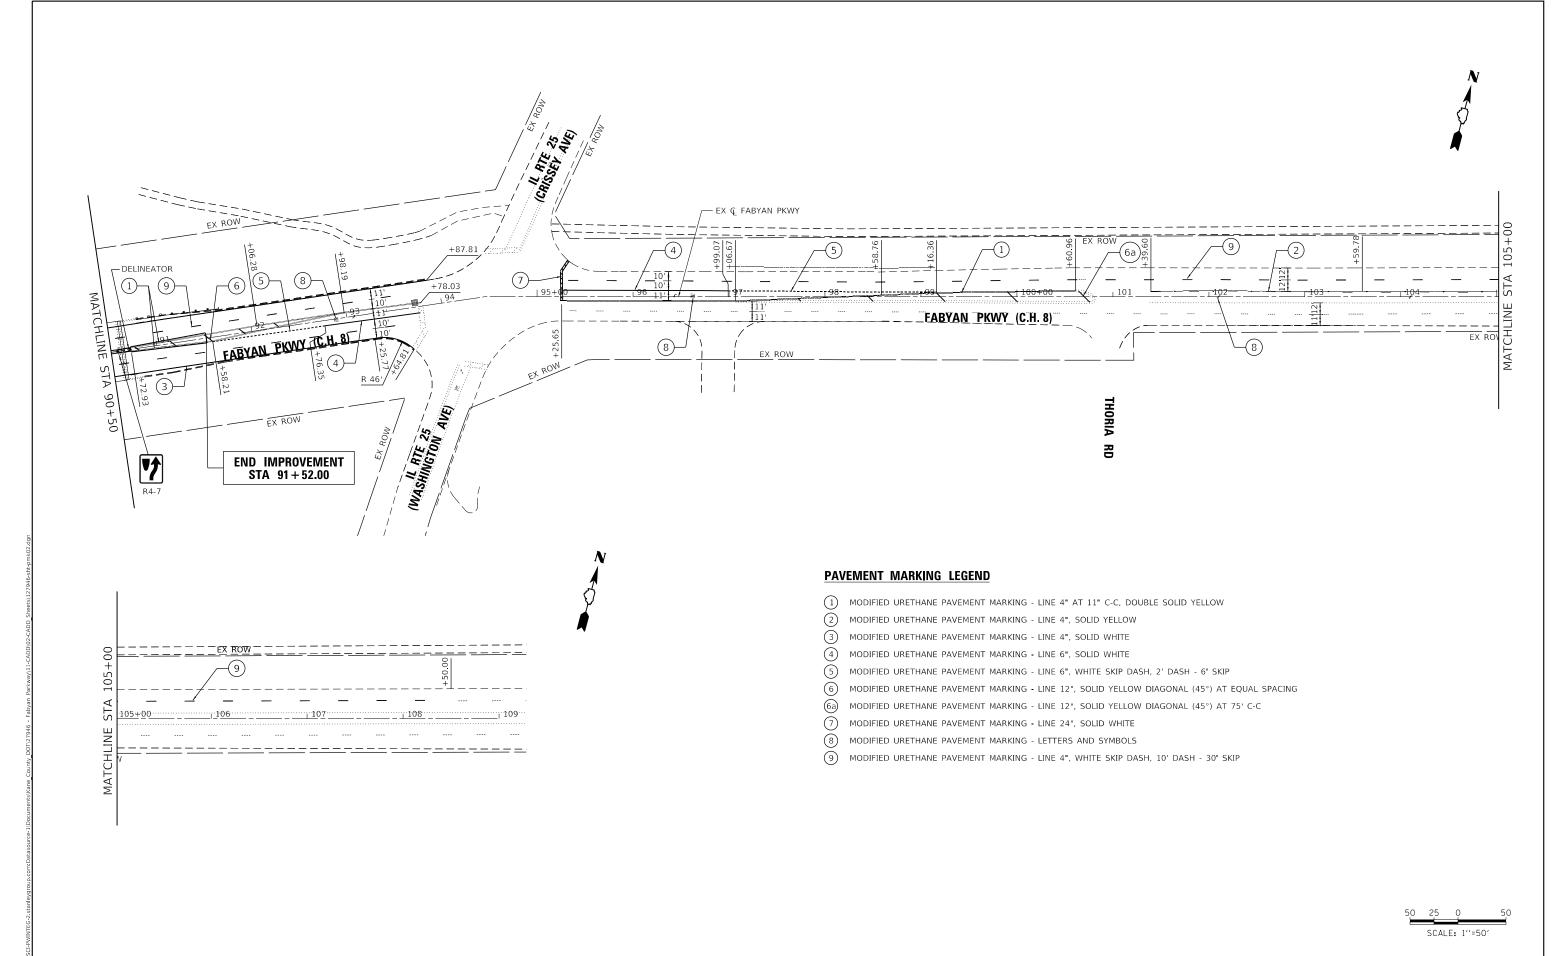
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SCALE: NONE

FABYAN PARKWAY	С.Н.	SECTION	COUNTY	TOTAL SHEETS	
EROSION CONTROL GENERAL NOTES	8	17-00479-00-BR	KANE	57	22
ENGSION CONTINUE GENERAL NOTES			CONTRAC	ΓNO.	
SHEET 1 OF 1 SHEETS STA. TO STA.		ILLINOIS	FED. AID PROJECT		





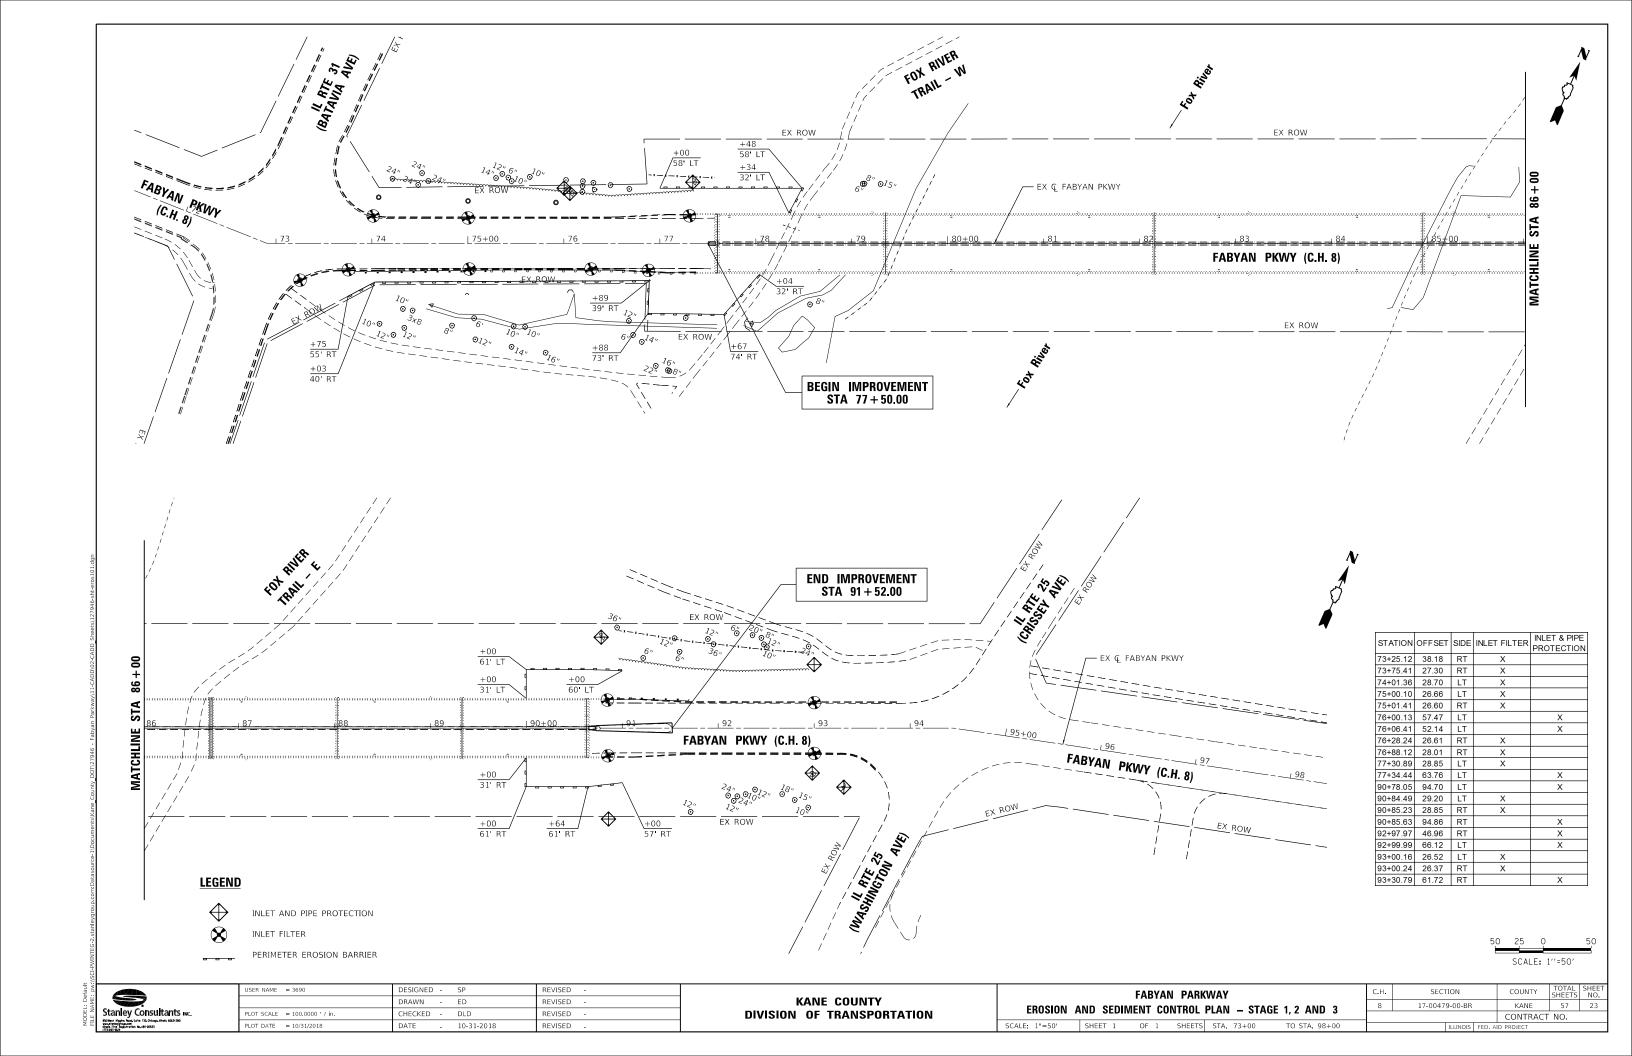

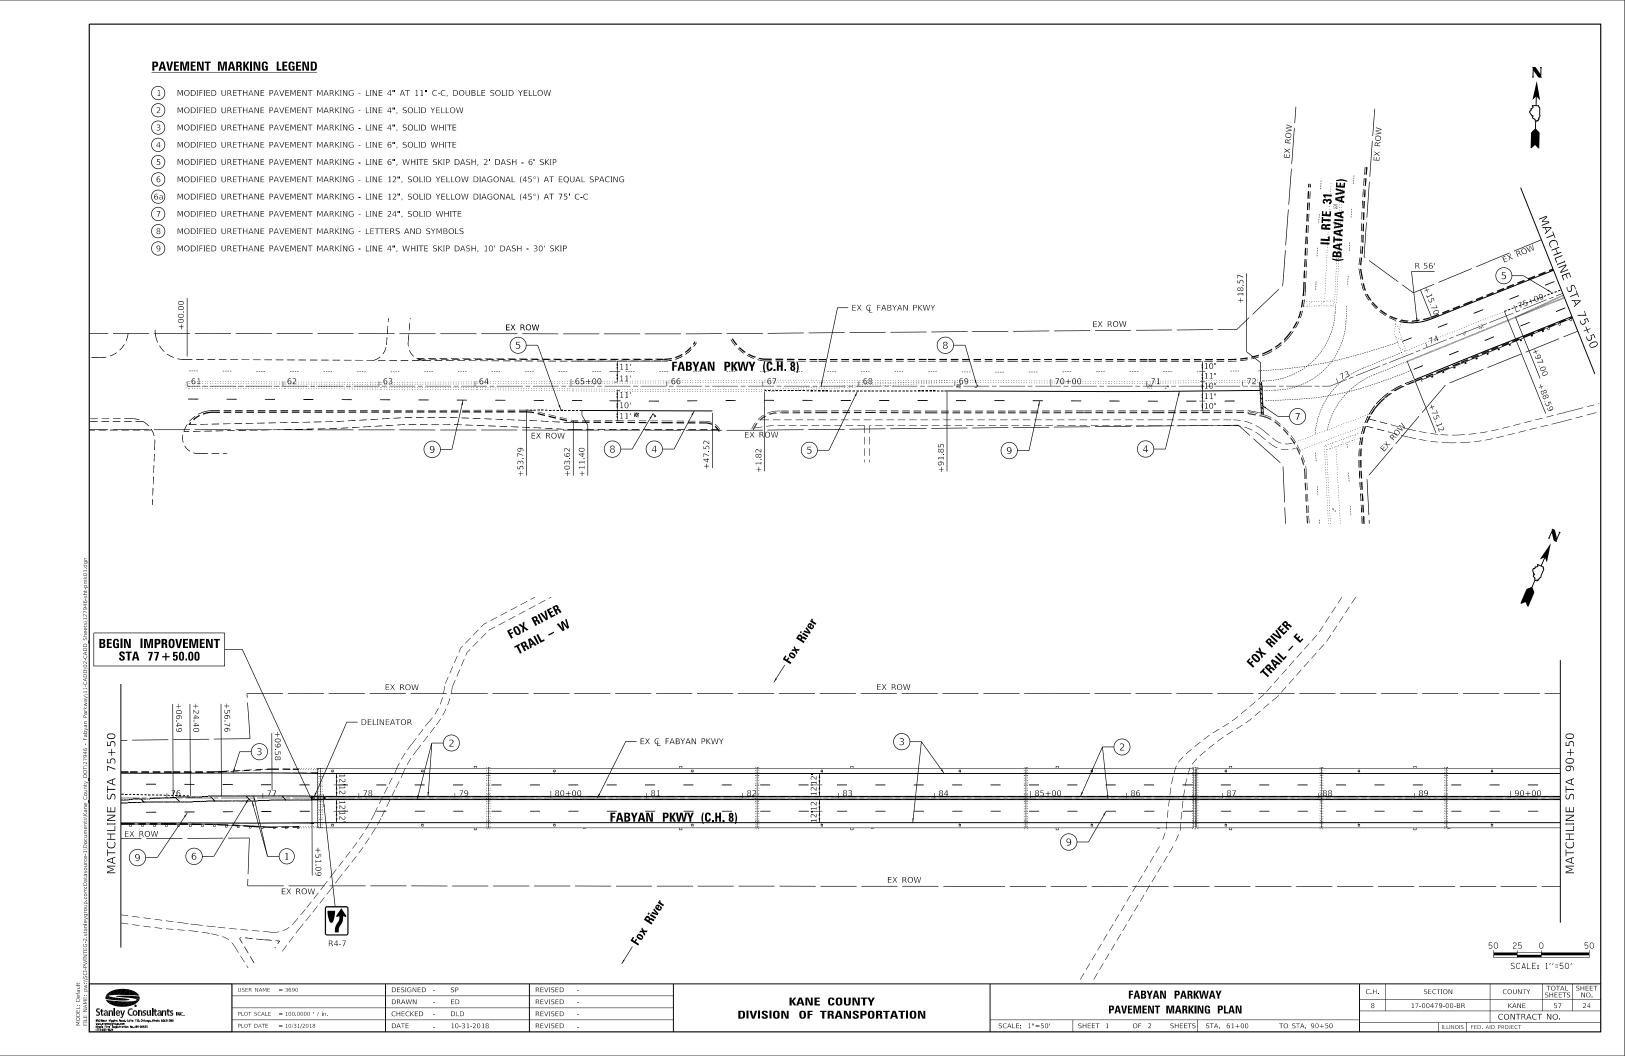Stanley Consultants INC.

600 Near Signer Roots Safe 175, Orloops Winds 6409-240

overstowning Concern


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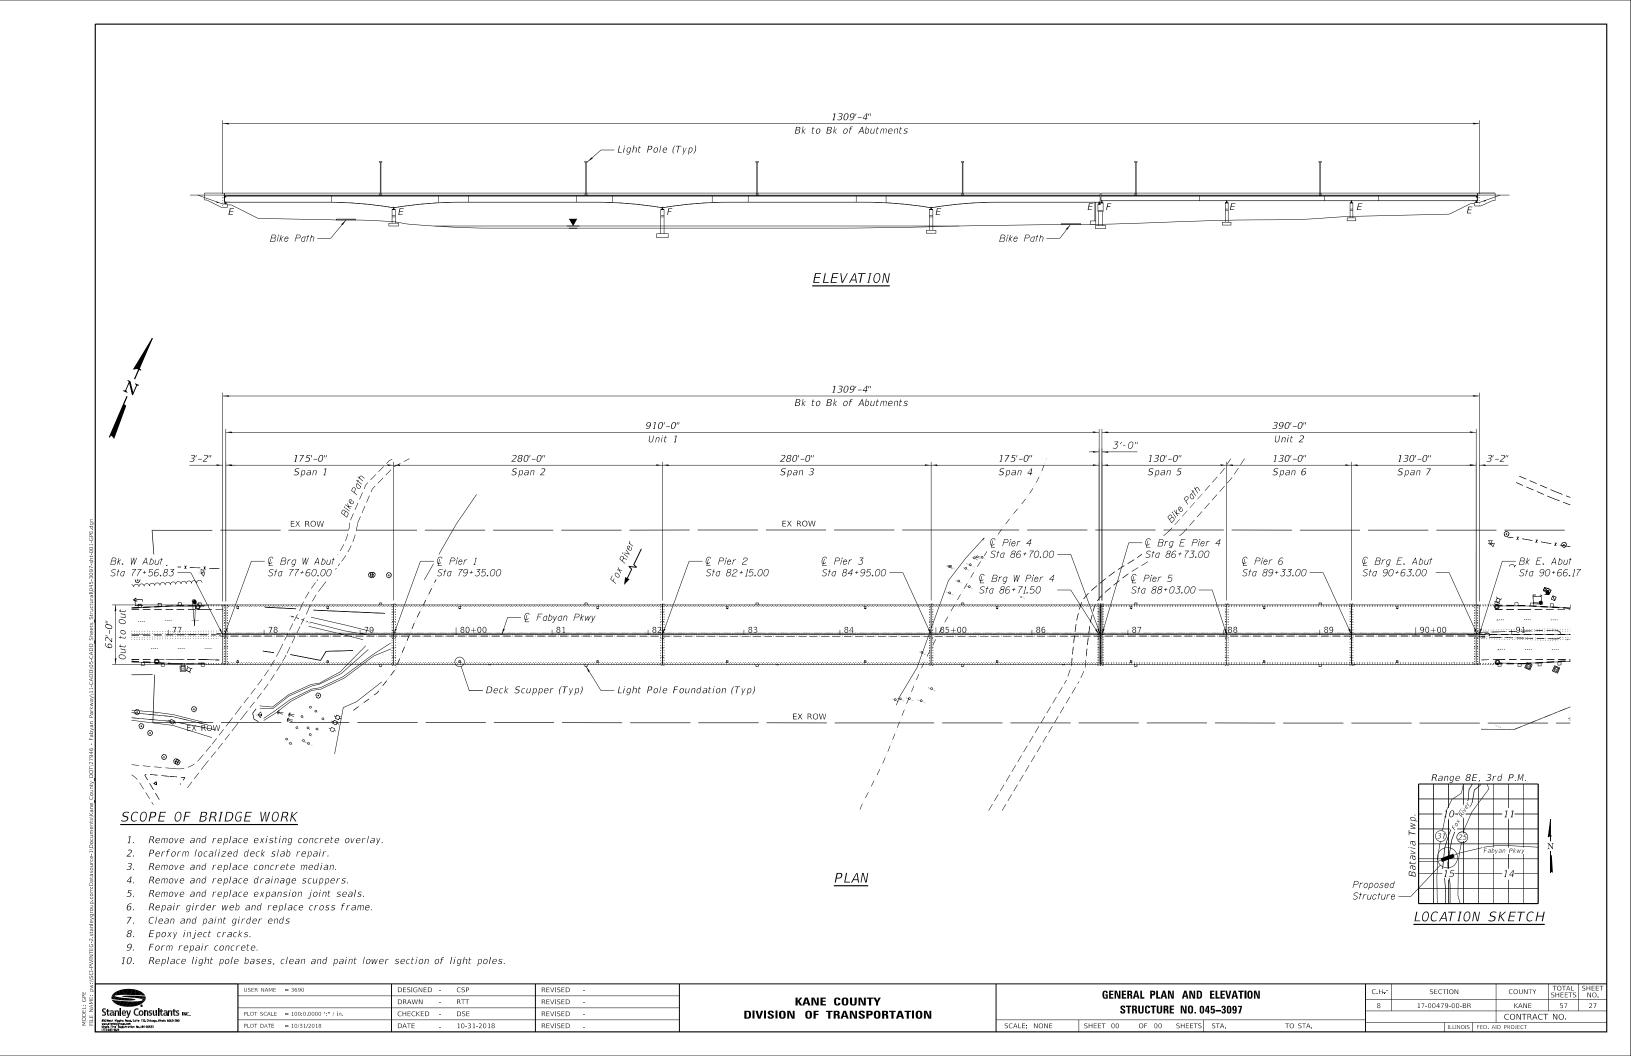
JSER NAME = 3690 DESIGNED -REVISED DRAWN -ED REVISED LOT SCALE = 100.0000 ' / in. REVISED

KANE COUNTY

**FABYAN PARKWAY PAVEMENT MARKING** SCALE: 1"=50' SHEET 2 OF 2 SHEETS STA. 90+50 TO STA. 109+00

SECTION 17-00479-00-BR CONTRACT NO.



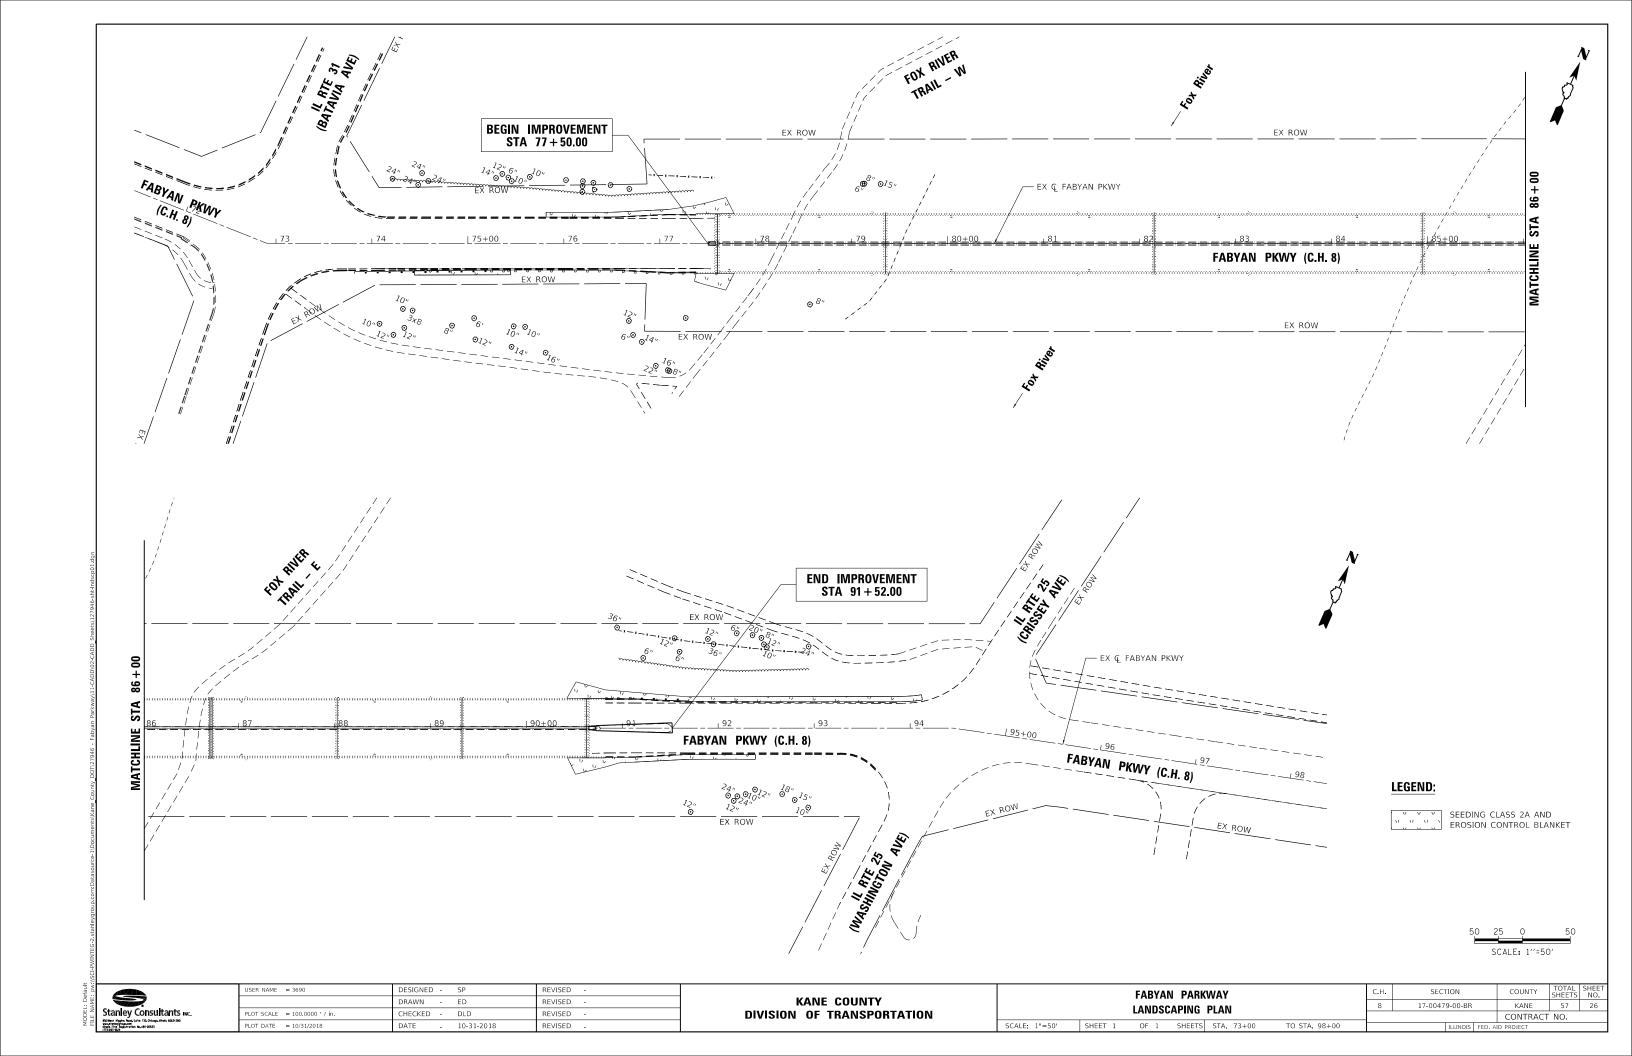

### GENERAL NOTES

- 1. Fasteners shall be ASTM A325 Type 3 mechanically galvanized bolts. Bolts 3/4 in. φ, holes 13/16 in. φ, unless otherwise noted.
- 2. Calculated weight of Structural Steel = 410 lbs
- 3. All structural steel shall be AASHTO M 270 Grade 50W.
- 4. No field welding is permitted except as specified in the contract documents.
- 5. Reinforcement bars designated (E) shall be epoxy coated.
- 6. Plan dimensions and details relative to existing plans are subject to nominal construction variations. The Contractor shall field verify existing dimensions and details affecting new construction and make necessary approved adjustments prior to construction or ordering of materials. Such variations shall not be cause for additional compensation for a change in scope of work, however, the Contractor will be paid for the quantity actually furnished at the unit price bid for the work.
- 7. All structural steel and exposed surfaces of bearings within a distance of 10 ft. each way from the deck joints shall be painted as specified in the Special Provisions.
- 8. Existing reinforcement shall be cleaned and incorporated into the new construction. Cost included with Concrete Removal.
- 9. Any reinforcement bars that are damaged during concrete removal operations shall be repaired or replaced using an approved bar splicer or anchorage system. Cost incidental to "Concrete Removal".
- 10. Surfaces of existing steel identified in pay item for CLEANING AND PAINTING STEEL BRIDGE NO.1 and CLEANING AND PAINTING LIGHT POLES shall be prepared according to SSPC-SP3, Power Tool Cleaning and painted according to System 2 as specified in special provisions. Final finish coat color for light poles shall be field matched. Final finish coat color for beam ends shall be Reddish Brown, Munsell NO. 2.5YR 3/4.

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- 39 Pier 2 Repair Plans 40 Pier 3 Repair Plans
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- 48 Superstructure Details 1 of 2 49 Superstructure Details 2 of 2
- 50 Miscellaneous Steel Details
- 51 Scupper Details
- 52 Light Pole Details

### TOTAL BILL OF MATERIAL


ITEM UNIT TOTAL  CONCRETE REMOVAL CU YD 157  SLOPE WALL REMOVAL SQ YD 91  CONCRETE SUPERSTRUCTURE CU YD 157  BRIDGE DECK GROOVING SQ YD 7,493  PROTECTIVE COAT SQ YD 8,742  REINFORCEMENT BARS, EPOXY COATED POUND 6,650  SLOPE WALL 4 INCH SQ YD 92  EPOXY CRACK INJECTION FOOT 254  MODULAR EXPANSION JOINT STRIP SEAL REPLACEMENT, 6 IN FOOT 176  STRUCTURAL STEEL REPAIR LSUM 1  BRIDGE DECK LATEX CONCRETE OVERLAY, 3 INCHES SQ YD 8,075  CLEANING AND PAINTING STEEL BRIDGE NO. 1 LSUM 1  BRIDGE DECK SCARIFICATION 3" SQ YD 8,075  STRUCTURAL REPAIR OF CONCRETE (DEPTH EQUAL TO OR LESS THAN 5 INCHES)  DECK SLAB REPAIR (FULL DEPTH, TYPE II) SQ YD 81  DECK SLAB REPAIR (FULL DEPTH, TYPE II) SQ YD 954  DRAINAGE SCUPPERS, DS-12M10 EACH 20  DRILL AND GROUT BARS EACH 140  CLEANING AND PAINTING LIGHT POLES LSUM 1  BASE WRAP, 24 INCH	<u>-</u>		
SLOPE WALL REMOVAL  CONCRETE SUPERSTRUCTURE  CU YD 157  BRIDGE DECK GROOVING  PROTECTIVE COAT  SQ YD 7,493  PROTECTIVE COAT  SQ YD 8,742  REINFORCEMENT BARS, EPOXY COATED  POUND 6,650  SLOPE WALL 4 INCH  SQ YD 92  EPOXY CRACK INJECTION  MODULAR EXPANSION JOINT STRIP SEAL REPLACEMENT, 6 IN  FOOT 254  MODULAR EXPANSION JOINT STRIP SEAL REPLACEMENT, 6 IN  BRIDGE DECK LATEX CONCRETE OVERLAY, 3 INCHES  CLEANING AND PAINTING STEEL BRIDGE NO. 1  BRIDGE DECK SCARIFICATION 3"  SQ YD 8,075  STRUCTURAL REPAIR OF CONCRETE (DEPTH EQUAL TO OR LESS  THAN 5 INCHES)  DECK SLAB REPAIR (FULL DEPTH, TYPE II)  DECK SLAB REPAIR (FULL DEPTH, TYPE II)  DECK SLAB REPAIR (PARTIAL)  DRAINAGE SCUPPERS, DS-12M10  DRILL AND GROUT BARS  EACH 140  CLEANING AND PAINTING LIGHT POLES  L SUM 1	ITEM	UNIT	TOTAL
CONCRETE SUPERSTRUCTURE  CU YD 157  BRIDGE DECK GROOVING  SQ YD 7,493  PROTECTIVE COAT  SQ YD 8,742  REINFORCEMENT BARS, EPOXY COATED  POUND 6,650  SLOPE WALL 4 INCH  SQ YD 92  EPOXY CRACK INJECTION  FOOT 254  MODULAR EXPANSION JOINT STRIP SEAL REPLACEMENT, 6 IN  FOOT 176  STRUCTURAL STEEL REPAIR  BRIDGE DECK LATEX CONCRETE OVERLAY, 3 INCHES  CLEANING AND PAINTING STEEL BRIDGE NO. 1  BRIDGE DECK SCARIFICATION 3"  SQ YD 8,075  STRUCTURAL REPAIR OF CONCRETE (DEPTH EQUAL TO OR LESS  THAN 5 INCHES)  DECK SLAB REPAIR (FULL DEPTH, TYPE II)  DECK SLAB REPAIR (PARTIAL)  DRAINAGE SCUPPERS, DS-12M10  DRILL AND GROUT BARS  EACH 140  CLEANING AND PAINTING LIGHT POLES  L SUM 1	CONCRETE REMOVAL	CU YD	157
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PROTECTIVE COAT  REINFORCEMENT BARS, EPOXY COATED  SQ YD 8,742  REINFORCEMENT BARS, EPOXY COATED  SLOPE WALL 4 INCH  EPOXY CRACK INJECTION  FOOT 254  MODULAR EXPANSION JOINT STRIP SEAL REPLACEMENT, 6 IN  STRUCTURAL STEEL REPAIR  BRIDGE DECK LATEX CONCRETE OVERLAY, 3 INCHES  CLEANING AND PAINTING STEEL BRIDGE NO. 1  BRIDGE DECK SCARIFICATION 3"  SQ YD 8,075  STRUCTURAL REPAIR OF CONCRETE (DEPTH EQUAL TO OR LESS SQ FT 156  THAN 5 INCHES)  DECK SLAB REPAIR (FULL DEPTH, TYPE II)  DECK SLAB REPAIR (PARTIAL)  DRAINAGE SCUPPERS, DS-12M10  EACH 20  DRILL AND GROUT BARS  EACH 140  CLEANING AND PAINTING LIGHT POLES  L SUM 1	CONCRETE SUPERSTRUCTURE	CU YD	157
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CLEANING AND PAINTING STEEL BRIDGE NO. 1  BRIDGE DECK SCARIFICATION 3"  SQ YD 8,075  STRUCTURAL REPAIR OF CONCRETE (DEPTH EQUAL TO OR LESS TO STRUCTURAL REPAIR OF CONCRETE (DEPTH EQUAL TO OR LESS TO SQ YD 81  DECK SLAB REPAIR (FULL DEPTH, TYPE II)  DECK SLAB REPAIR (PARTIAL)  DRAINAGE SCUPPERS, DS-12M10  DRILL AND GROUT BARS  EACH 140  CLEANING AND PAINTING LIGHT POLES  L SUM 1	STRUCTURAL STEEL REPAIR	LSUM	-
BRIDGE DECK SCARIFICATION 3" SQ YD 8,075 STRUCTURAL REPAIR OF CONCRETE (DEPTH EQUAL TO OR LESS SQ FT 156 THAN 5 INCHES)  DECK SLAB REPAIR (FULL DEPTH, TYPE II) SQ YD 81 DECK SLAB REPAIR (PARTIAL) SQ YD 954 DRAINAGE SCUPPERS, DS-12M10 EACH 20 DRILL AND GROUT BARS EACH 140 CLEANING AND PAINTING LIGHT POLES L SUM 1	BRIDGE DECK LATEX CONCRETE OVERLAY, 3 INCHES	SQ YD	-,-
STRUCTURAL REPAIR OF CONCRETE (DEPTH EQUAL TO OR LESS SQ FT THAN 5 INCHES)  DECK SLAB REPAIR (FULL DEPTH, TYPE II) SQ YD 81  DECK SLAB REPAIR (PARTIAL) SQ YD 954  DRAINAGE SCUPPERS, DS-12M10 EACH 20  DRILL AND GROUT BARS EACH 140  CLEANING AND PAINTING LIGHT POLES L SUM 1	CLEANING AND PAINTING STEEL BRIDGE NO. 1	LSUM	-
THAN 5 INCHES)SQ YD81DECK SLAB REPAIR (FULL DEPTH, TYPE II)SQ YD81DECK SLAB REPAIR (PARTIAL)SQ YD954DRAINAGE SCUPPERS, DS-12M10EACH20DRILL AND GROUT BARSEACH140CLEANING AND PAINTING LIGHT POLESL SUM1		SQ YD	8,075
DECK SLAB REPAIR (FULL DEPTH, TYPE II)SQ YD81DECK SLAB REPAIR (PARTIAL)SQ YD954DRAINAGE SCUPPERS, DS-12M10EACH20DRILL AND GROUT BARSEACH140CLEANING AND PAINTING LIGHT POLESL SUM1	STRUCTURAL REPAIR OF CONCRETE (DEPTH EQUAL TO OR LESS	SQ FT	156
DECK SLAB REPAIR (PARTIAL)  DRAINAGE SCUPPERS, DS-12M10  DRILL AND GROUT BARS  CLEANING AND PAINTING LIGHT POLES  SQ YD 954  EACH 20  EACH 140  CLEANING AND PAINTING LIGHT POLES  L SUM 1	THAN 5 INCHES)		
DRAINAGE SCUPPERS, DS-12M10EACH20DRILL AND GROUT BARSEACH140CLEANING AND PAINTING LIGHT POLESL SUM1	DECK SLAB REPAIR (FULL DEPTH, TYPE II)	SQ YD	81
DRILL AND GROUT BARS EACH 140 CLEANING AND PAINTING LIGHT POLES L SUM 1	DECK SLAB REPAIR (PARTIAL)	SQ YD	954
CLEANING AND PAINTING LIGHT POLES L SUM 1	DRAINAGE SCUPPERS, DS-12M10	EACH	20
	DRILL AND GROUT BARS	EACH	140
BASE WRAP, 24 INCH EACH 12	CLEANING AND PAINTING LIGHT POLES	L SUM	1
	BASE WRAP, 24 INCH	EACH	12



USER NAME = 3690	DESIGNED - CSP	REVISED -
	DRAWN - RTT	REVISED -
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PLOT DATE = 10/31/2018	DATE - 10-31-2018	REVISED -

SCALE: NONE


GENERAL NOTES, INDEX, AND TOTAL BILL OF MATERIAL						C.H-	SECTION COUNT		COUNTY	TOTAL SHEETS	SHEET NO.	
STRUCTURE NO. 045-3097					8	17-0047	9-00-BR		KANE	57	28	
31NOCIONE NO. 043-3037									CONTRACT	NO.		
IONE	SHEET 00	OF 00	SHEETS	STA.	TO STA.			ILLINOIS	EED ΔI	D PROJECT		

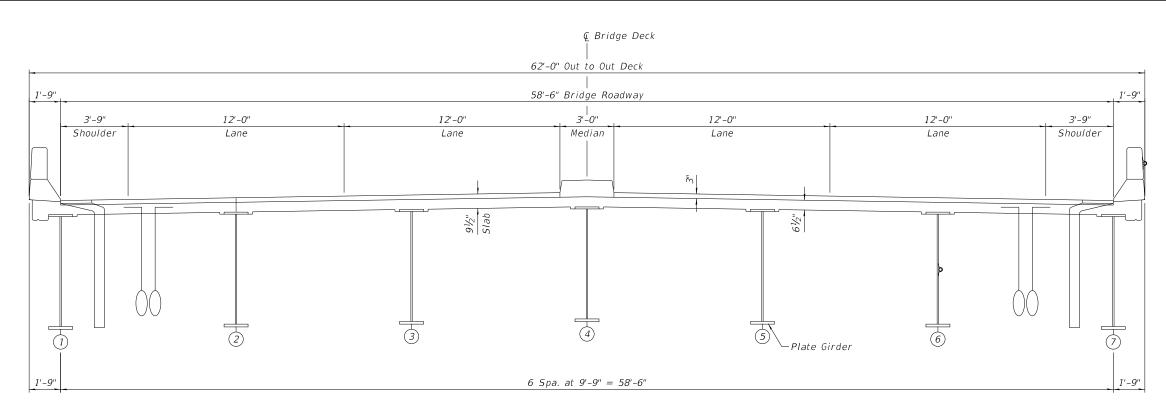

### EXISTING SECTION

(Looking East)

← Bridge Deck

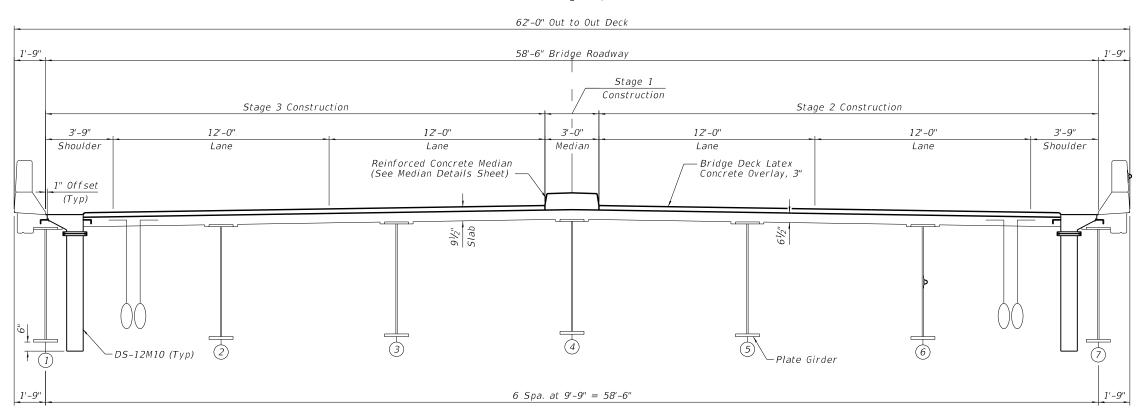

### PROPOSED SECTION

(Looking East)


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3	
١	Chamley Consultante
ì	Stanley Consultants 🗝.
1	850 Best Wiggins Roos, Suite 130, Chicago, Whols 6063-280
1	www.stonleygroup.com Whole Firm Registration No. 184-00533
ш	(II) POLI MA


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PLOT DATE = 10/31/2018	DATE - 10-31-2018	REVISED -

KANE COUNTY DIVISION OF TRANSPORTATION

CROSS SECTIONS							
		STR	UC	TUR	E NO. 0	45–3097	
	SHEET	00	OF	00	SHEETS	STA.	TO STA.

SCALE: NONE

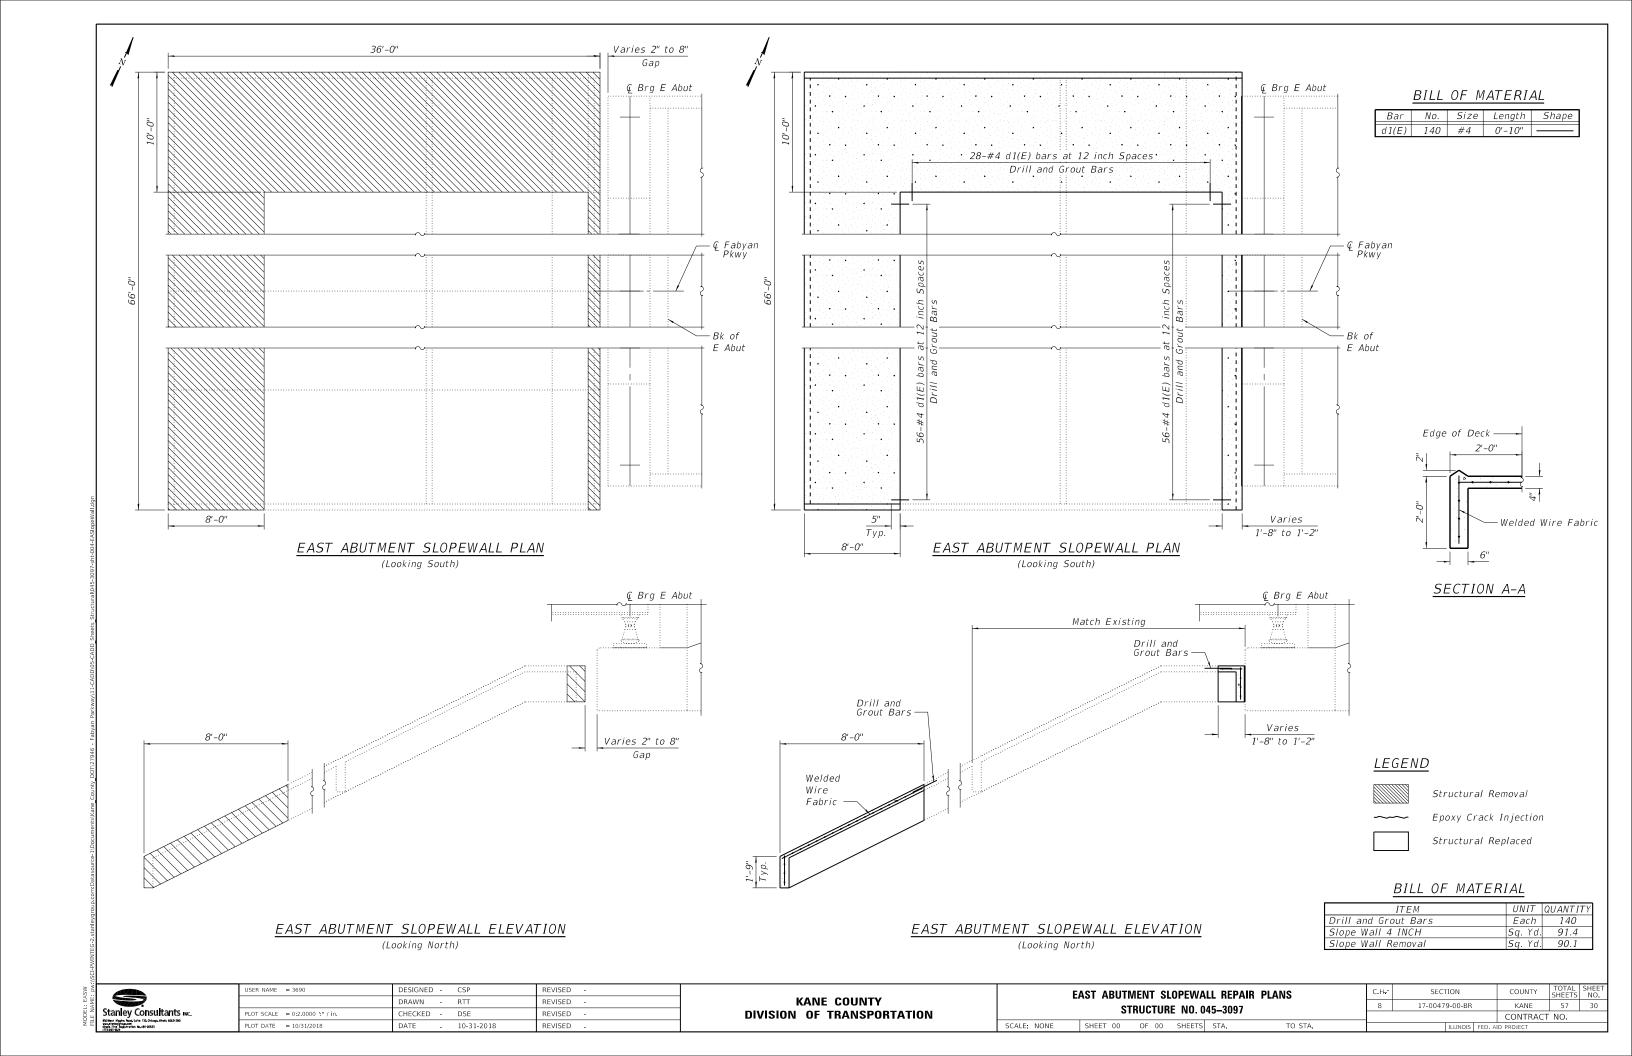

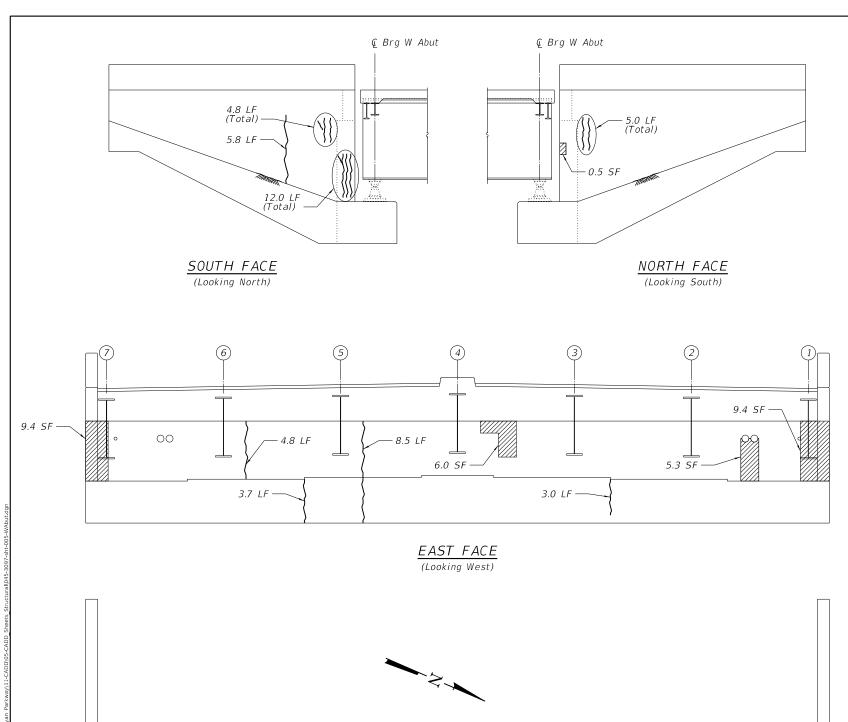

### Structurur Nepu



LEGEND


Structural Repair of Concrete (Depth ≤ 5")

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Epoxy Crack Injection

### BILL OF MATERIAL

| <u> </u>                              | ·       |          |
|---------------------------------------|---------|----------|
| · · · · · · · · · · · · · · · · · · · |         |          |
| ITEM                                  | UNIT    | QUANTITY |
|                                       | Sq. Ft. | 34.6     |
| (Depth Equal to or Less Than 5")      |         |          |
| Epoxy Crack Injection                 | Ft.     | 47.6     |

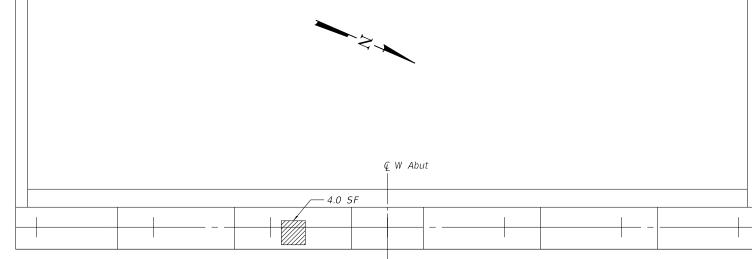

<u>PLAN</u>

Stanley Consultants Inc.


Stanley Figure 1920 Figure 1


| USER NAME = 3690                | DESIGNED - CSP    | REVISED - |
|---------------------------------|-------------------|-----------|
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| PLOT DATE = 10/31/2018          | DATE - 10-31-2018 | REVISED - |

KANE COUNTY
DIVISION OF TRANSPORTATION


SCALE: NONE

| WEST ABUTMENT REPAIR PLANS<br>STRUCTURE NO. 045–3097 |       | C.H-   | SECTION        |        | COUNTY | TOTAL<br>SHEETS | SHE<br>NC |            |  |  |
|------------------------------------------------------|-------|--------|----------------|--------|--------|-----------------|-----------|------------|--|--|
|                                                      |       | 8      | 17-00479-00-BF | ₹      | KANE   | 57              | 31        |            |  |  |
| 31NUCTURE NO. 043-3097                               |       |        |                |        |        | CONTRACT        | NO.       |            |  |  |
| SHEET OO                                             | OF OO | SHEETS | STA            | TO STA |        | TILLINOIS       | EED A     | ID BROJECT |  |  |

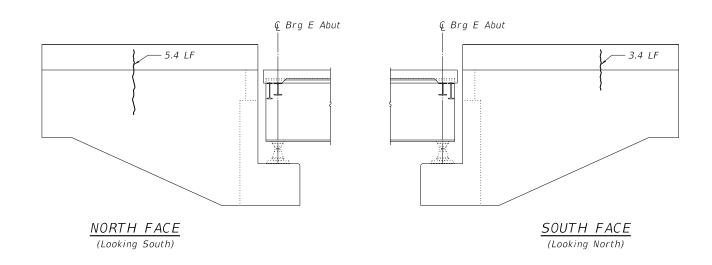

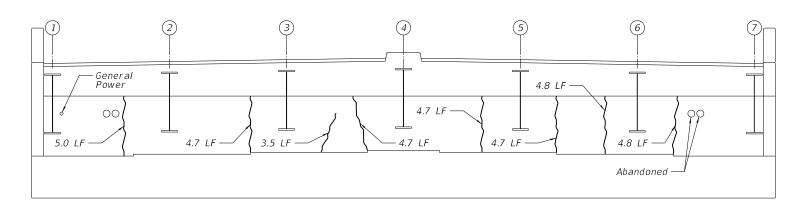

 $\frac{WEST\ FACE}{(Looking\ East)}$ 

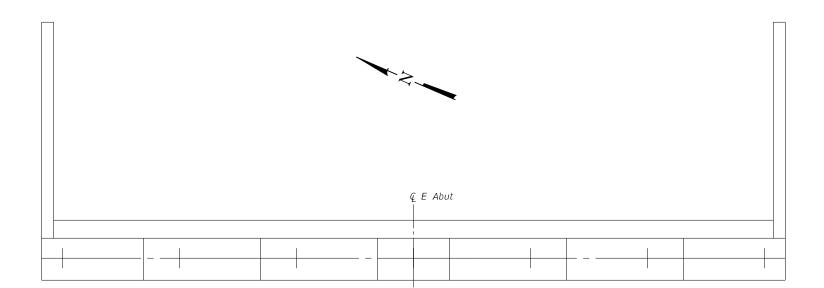

### <u>PLAN</u>

### LEGEND

Epoxy Crack Injection


### BILL OF MATERIAL

|             | ITEM      | UNIT | QUANTITY |
|-------------|-----------|------|----------|
| Epoxy Crack | Injection | Ft.  | 49.1     |

Stanley Consultants INC.
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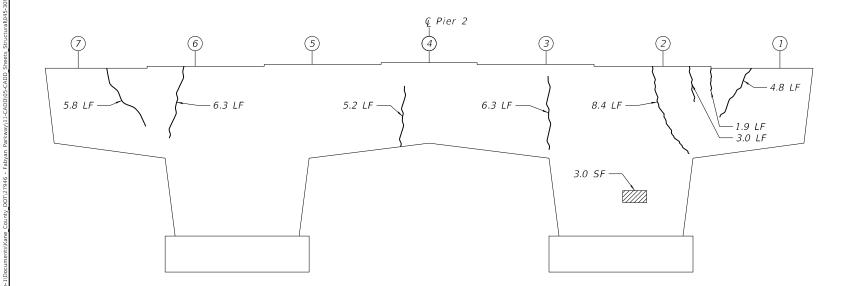
| USER NAME = 3690                | DESIGNED | - | CSP        | REVISED - |
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| PLOT DATE = 10/31/2018          | DATE     | - | 10-31-2018 | REVISED - |

| - |             | EAST ABUTMENT REPAIR PLANS         | C.H. | SECTION        |         | COUNTY     | TOTAL<br>SHEETS | Ι |
|---|-------------|------------------------------------|------|----------------|---------|------------|-----------------|---|
|   |             | STRUCTURE NO. 045-3097             | 8    | 17-00479-00-BR |         | KANE       | 57              | Γ |
|   |             | 31110010HL NO. 043-3037            |      |                |         | CONTRACT   | NO.             |   |
|   | SCALE: NONE | SHEET 00 OF 00 SHEETS STA. TO STA. |      | ILLINOIS       | FED. AI | ID PROJECT |                 |   |

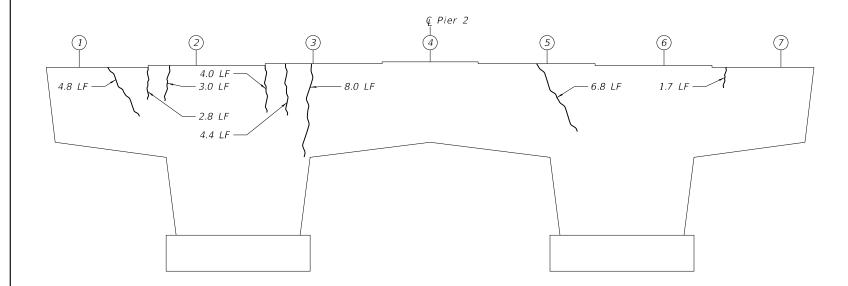

### <u>WEST FACE</u>

(Looking East)



### <u>LEGEND</u>



Structural Repair of Concrete (Depth ≤ 5")

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Epoxy Crack Injection

### BILL OF MATERIAL

ITEM	UNIT	QUANT IT
	Sq. Ft.	2.0
(Depth Equal to or Less Than 5")		
Epoxy Crack Injection	Ft.	77.2

TO STA.

### EAST FACE


(Looking West)




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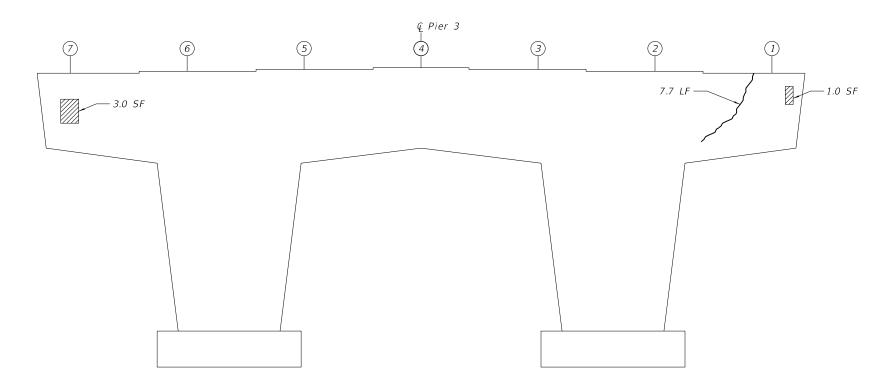
C.H <del>.</del>	SECTION		COUNTY	TOTAL SHEETS	SHEE NO.
8	17-00479-00-B	R	KANE	57	33
		CONTRACT	NO.		
	ILLINOI	FED. A	ID PROJECT		



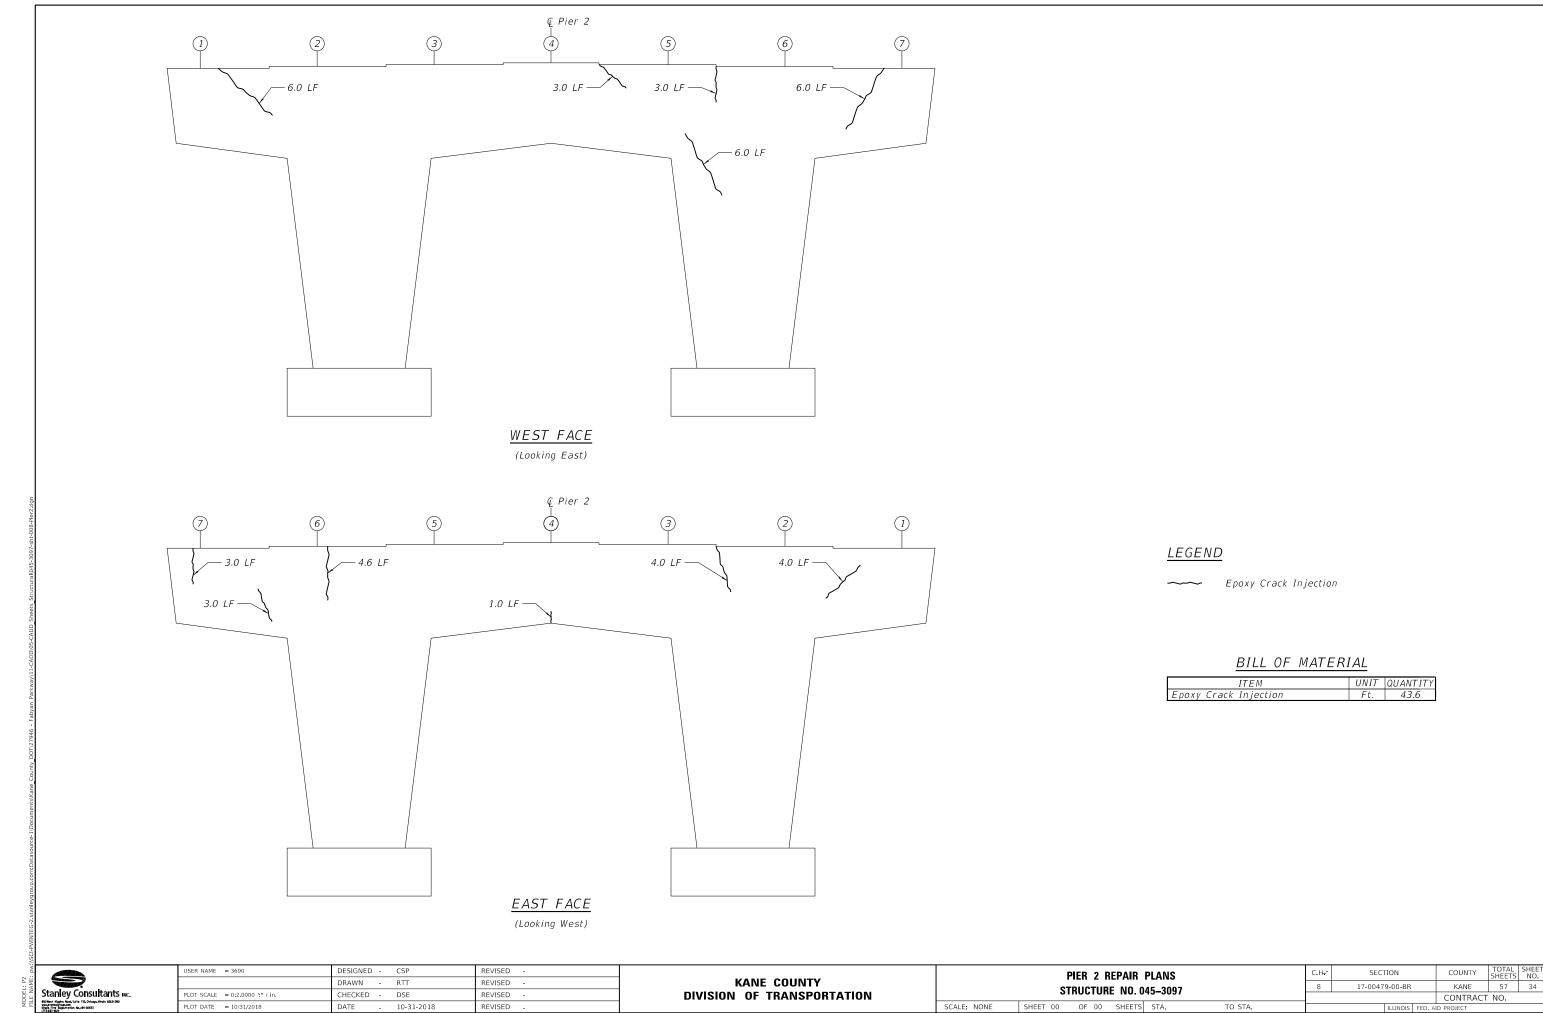

### <u>WEST FACE</u>

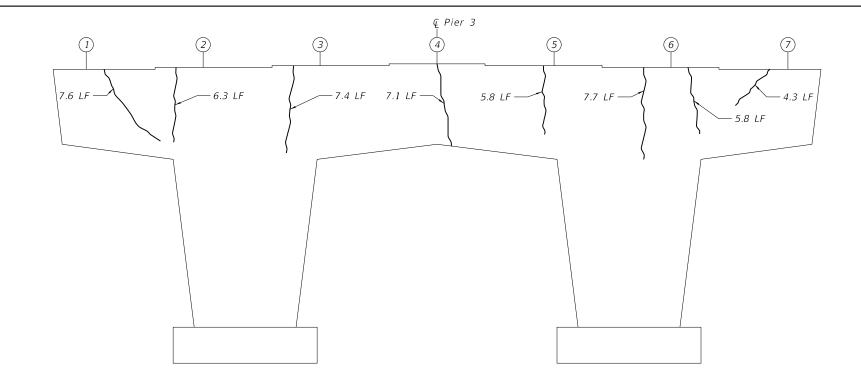(Looking East)



### LEGEND



Structural Repair of Concrete (Depth ≤ 5")

~~~

Epoxy Crack Injection

### BILL OF MATERIAL

| ITEM                             | UNIT    | QUANT IT |
|----------------------------------|---------|----------|
| Structural Repair of Concrete    | Sq. Ft. | 3.0      |
| (Depth Equal to or Less Than 5") |         |          |
| Epoxy Crack Injection            | Ft.     | 38.5     |

TO STA.

EAST FACE


(Looking West)



| USER NAME = 3690                | DESIGNED - CSP    | REVISED - |
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| PLOT DATE = 10/31/2018          | DATE - 10-31-2018 | REVISED - |

|             |       | S  |    | -  | REPAIR<br>RE NO.0 |      |
|-------------|-------|----|----|----|-------------------|------|
| SCALE: NONE | SHEET | 00 | OF | 00 | SHEETS            | STA. |

| C.H. | SECTION        |          | COUNTY     | TOTAL<br>SHEETS | SHEET<br>NO. |
|------|----------------|----------|------------|-----------------|--------------|
| 8    | 17-00479-00-BR | KANE     | 57         | 35              |              |
|      |                | CONTRACT | NO.        |                 |              |
|      | ILLINOIS       | FED. A   | ID PROJECT |                 |              |

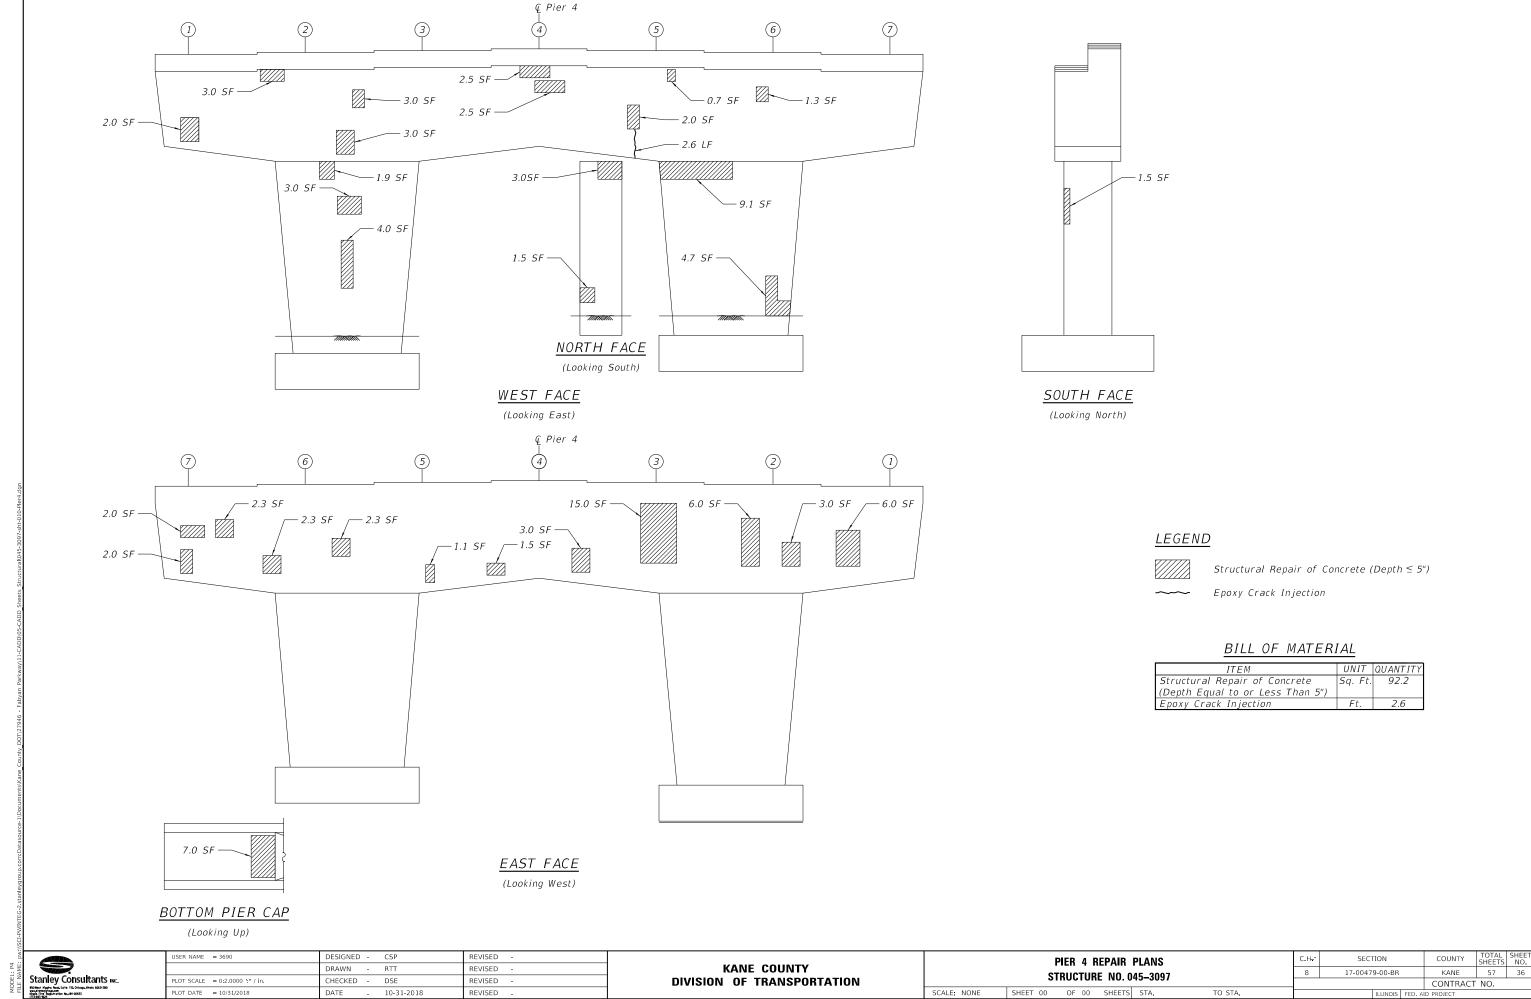

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TO STA.


CONTRACT NO.

PLOT DATE = 10/31/2018

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<u>NOTE:</u>

No deficiences on pier.

Stanley Consultants Inc.
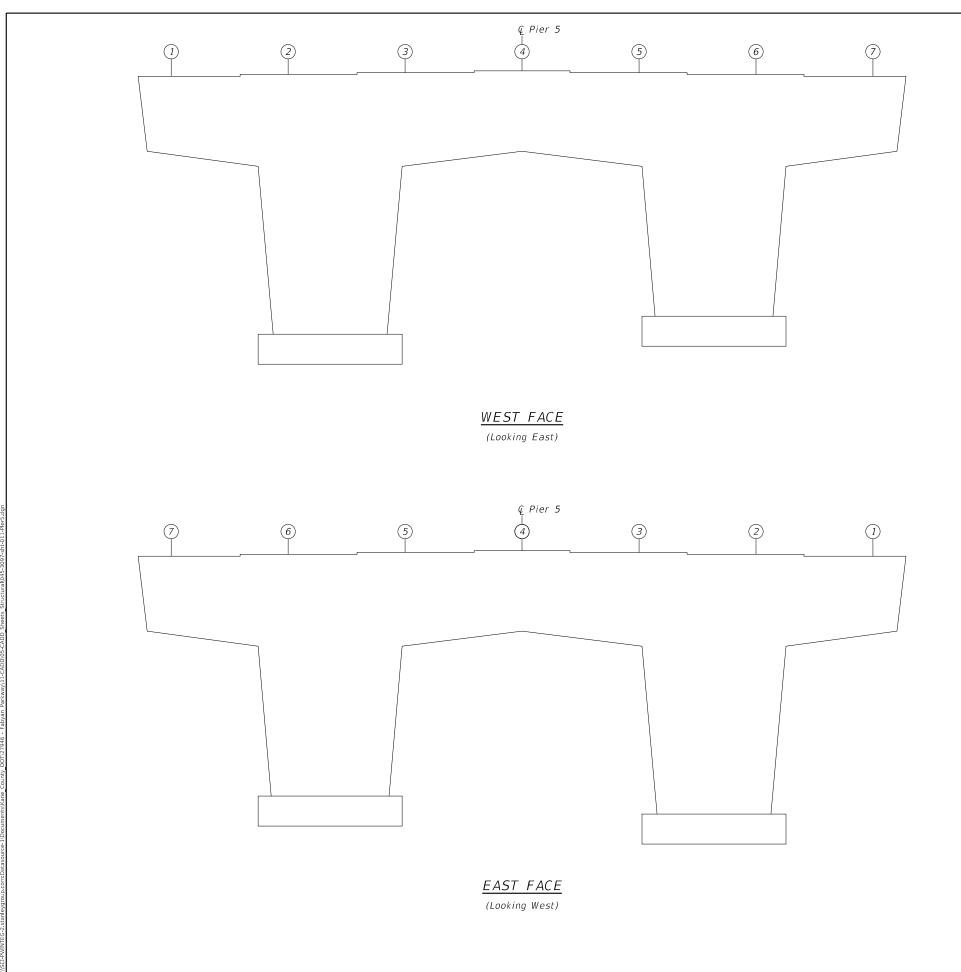
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|                                 | DRAWN    | - | RTT        | REVISED - | 1 |
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| PLOT DATE = 10/31/2018          | DATE     | - | 10-31-2018 | REVISED - |   |

KANE COUNTY DIVISION OF TRANSPORTATION

SCALE: NONE


|  | PIER 5 REPAIR PLANS STRUCTURE NO. 045-3097 |         |         |             | C.H.    | SECTI    |  |
|--|--------------------------------------------|---------|---------|-------------|---------|----------|--|
|  |                                            |         |         |             | 8       | 17-00479 |  |
|  | 3                                          | inocion | L NO. U | <del></del> |         |          |  |
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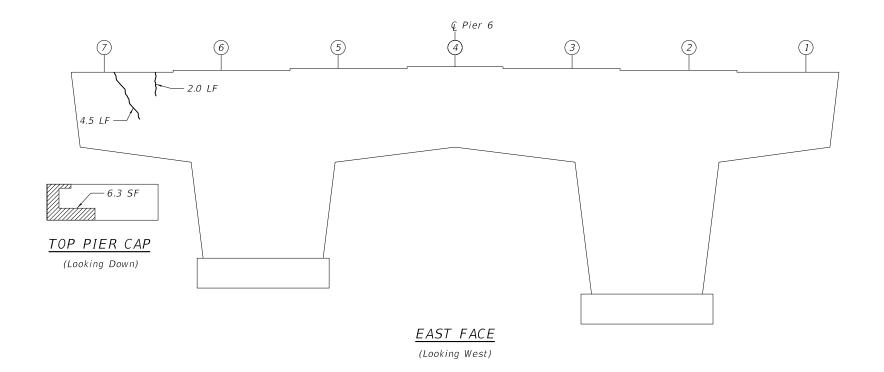
 C.H.
 SECTION
 COUNTY SHEETS NO.
 TOTAL SHEETS NO.

 8
 17-00479-00-BR
 KANE
 57
 37

 CONTRACT NO.

 ILLINOIS FED. AID PROJECT



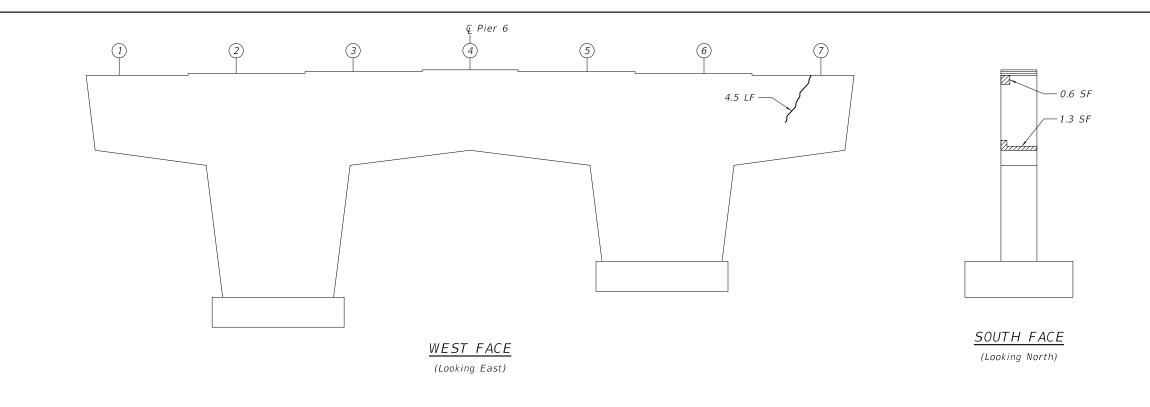

## <u>LEGEND</u>



Structural Repair of Concrete (Depth ≤ 5")



Epoxy Crack Injection

### BILL OF MATERIAL

| ITEM                             | UNIT    | QUANT IT |
|----------------------------------|---------|----------|
|                                  | Sq. Ft. | 8.2      |
| (Depth Equal to or Less Than 5") |         |          |
| Enoxy Crack Injection            | F+      | 9.0      |

| USER NAME = 3690                | DESIGNED - CSP    | REVISED - |
|---------------------------------|-------------------|-----------|
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| PLOT DATE = 10/31/2018          | DATE - 10-31-2018 | REVISED - |

KANE COUNTY DIVISION OF TRANSPORTATION

|   |       |    | PIER | 6 I | REPAIR   | PLANS   |       |
|---|-------|----|------|-----|----------|---------|-------|
|   |       | S  | TRUC | TUF | RE NO. 0 | 45–3097 |       |
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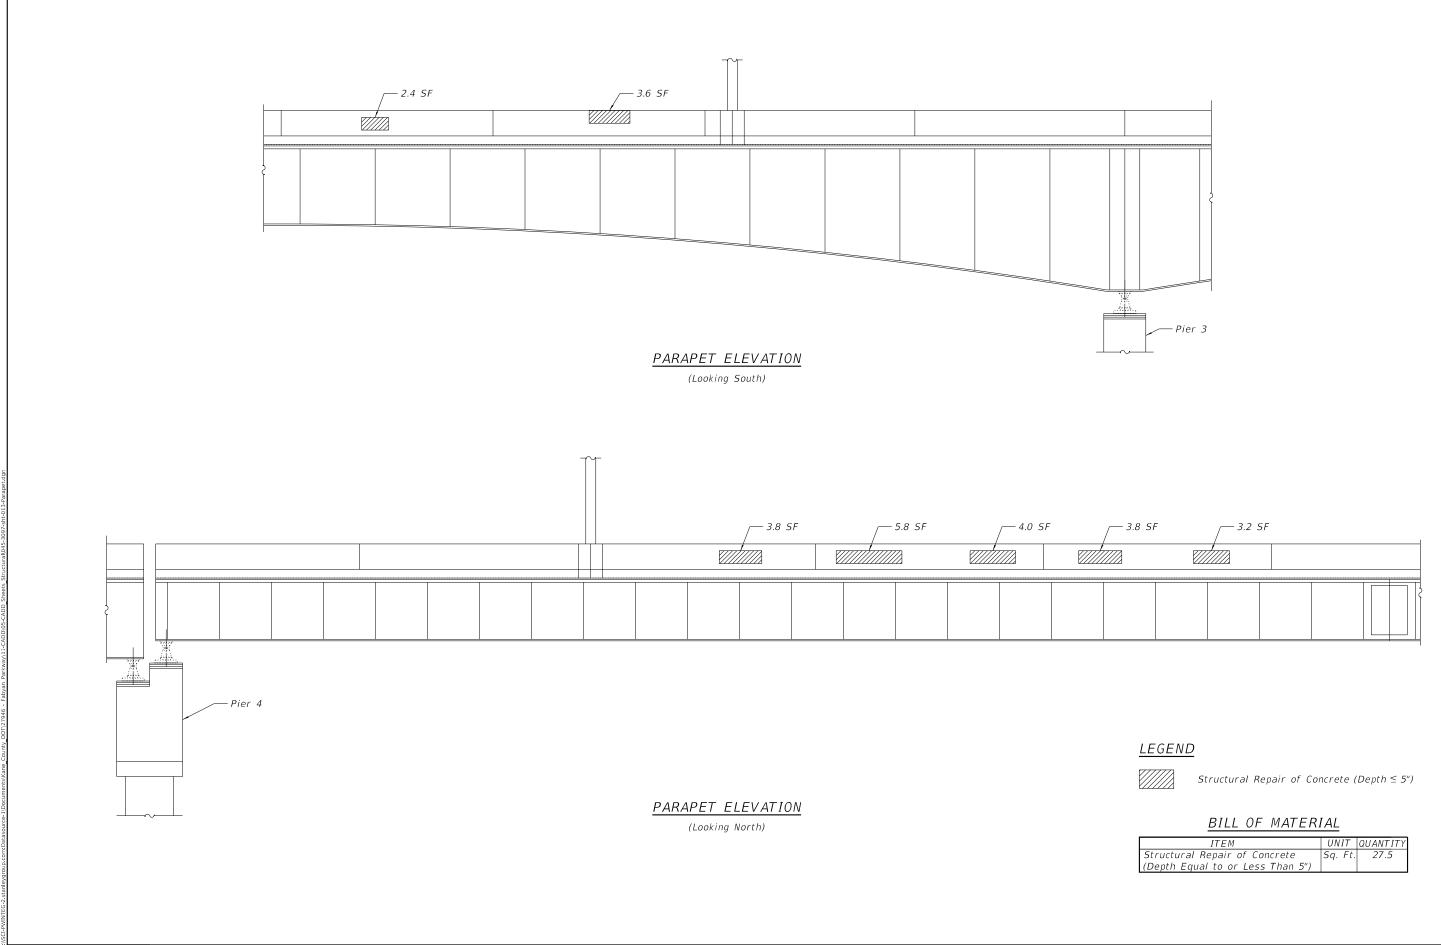
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 C.H. SECTION
 COUNTY SHEETS NO.
 SHEETS NO.

 8
 17-00479-00-BR
 KANE
 57
 38

 CONTRACT NO.

 ILLINOIS FED. AID PROJECT



Stanley Consultants INC.

Stanley Repr. Name State 100, Octopy, Brod. 600-200

TOTAL State of the Consultant Name 440551

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 = 3690
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 PLOT DATE
 = 10/31/2018
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 REVISED

KANE COUNTY
DIVISION OF TRANSPORTATION

PARAPET REPAIR ELEVATIONS
STRUCTURE NO. 045–3097


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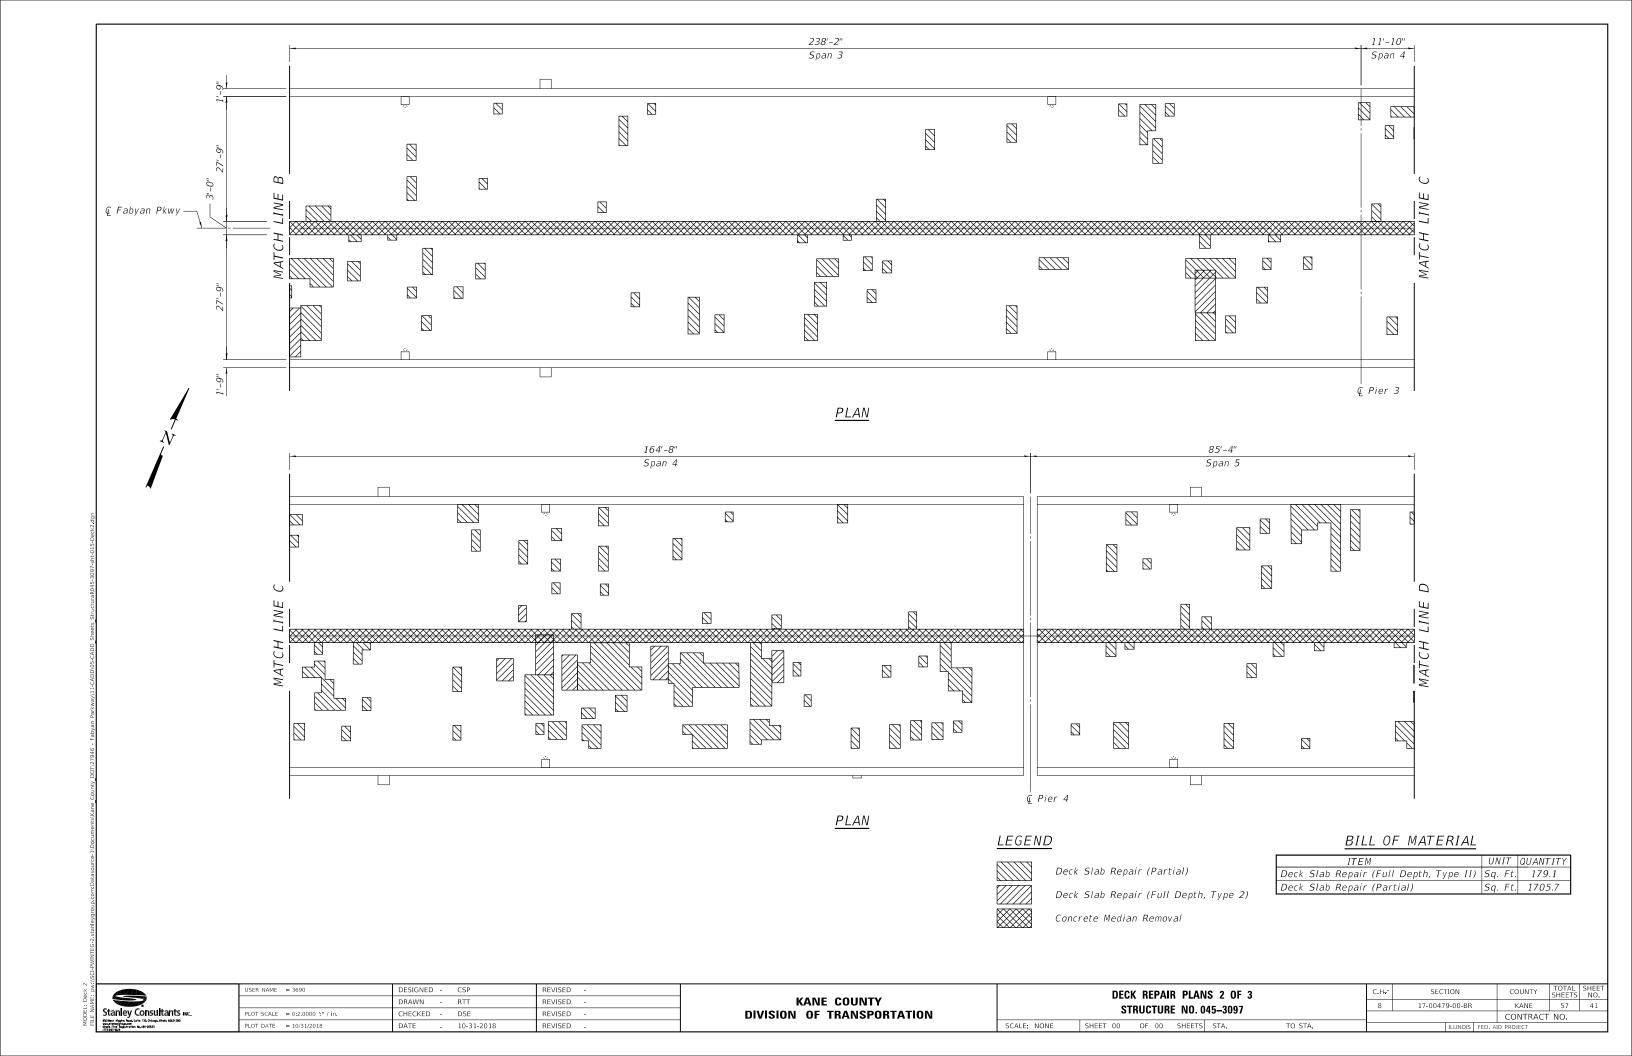
TO STA.

C.H.: SECTION COUNTY TOTAL SHEETS NO.


8 17-00479-00-BR KANE 57 39


CONTRACT NO.



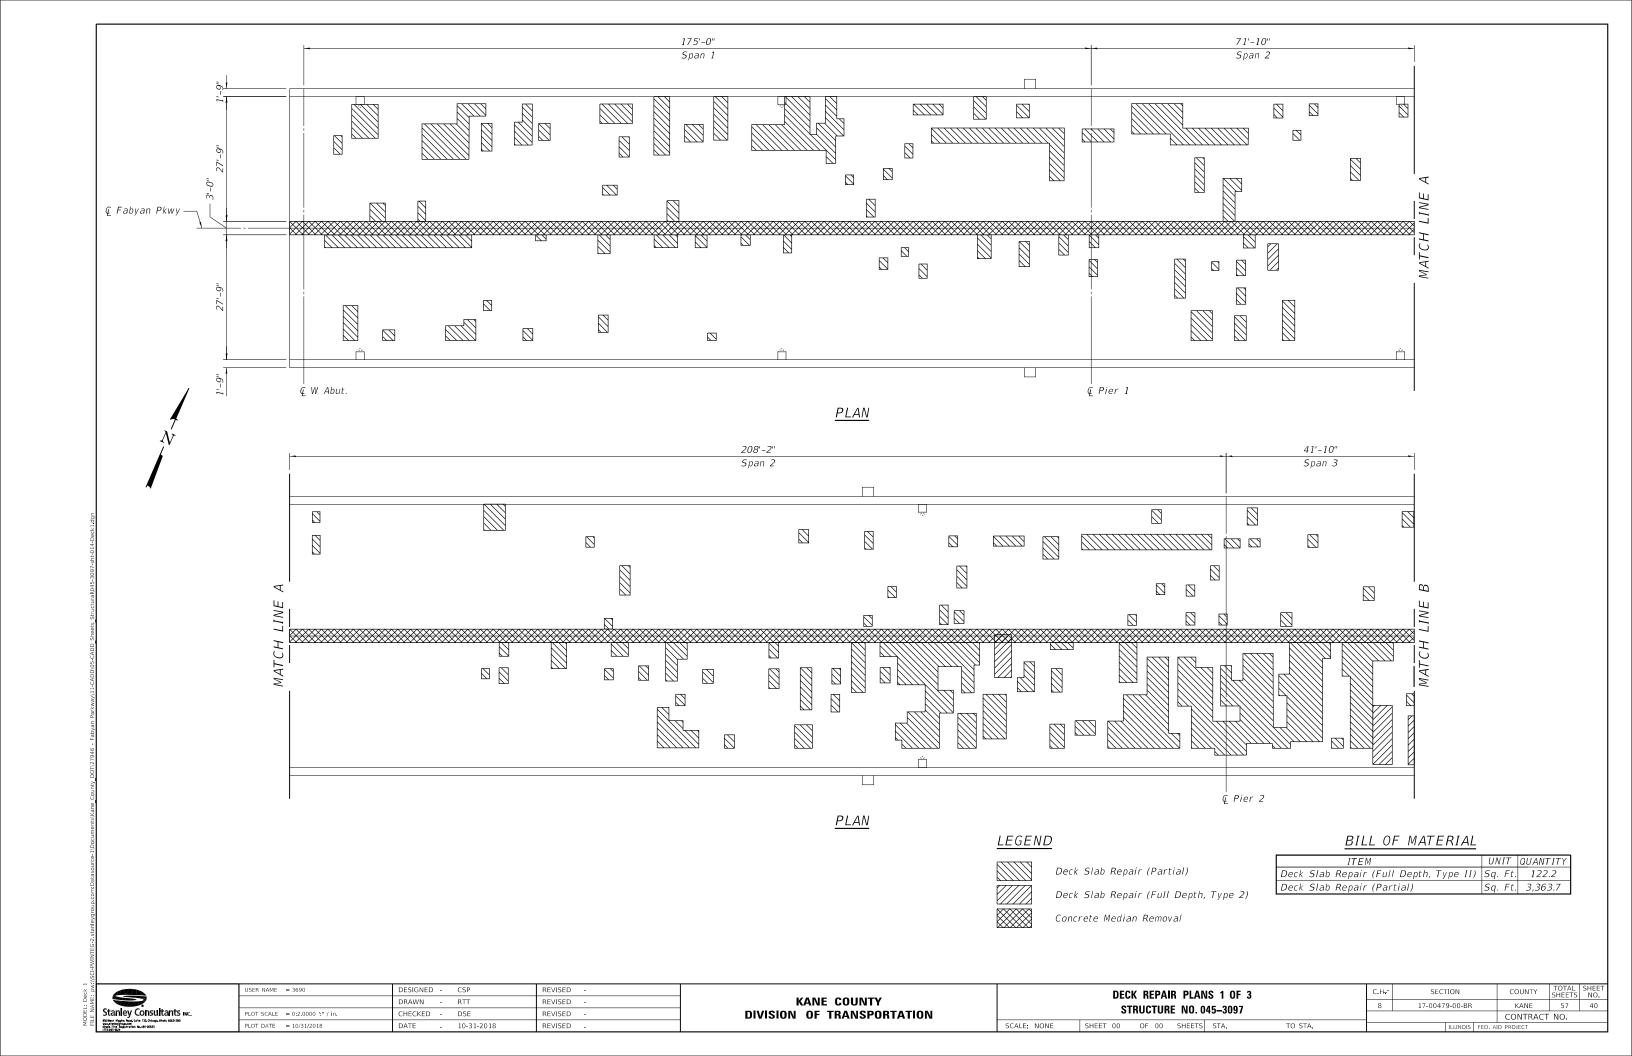



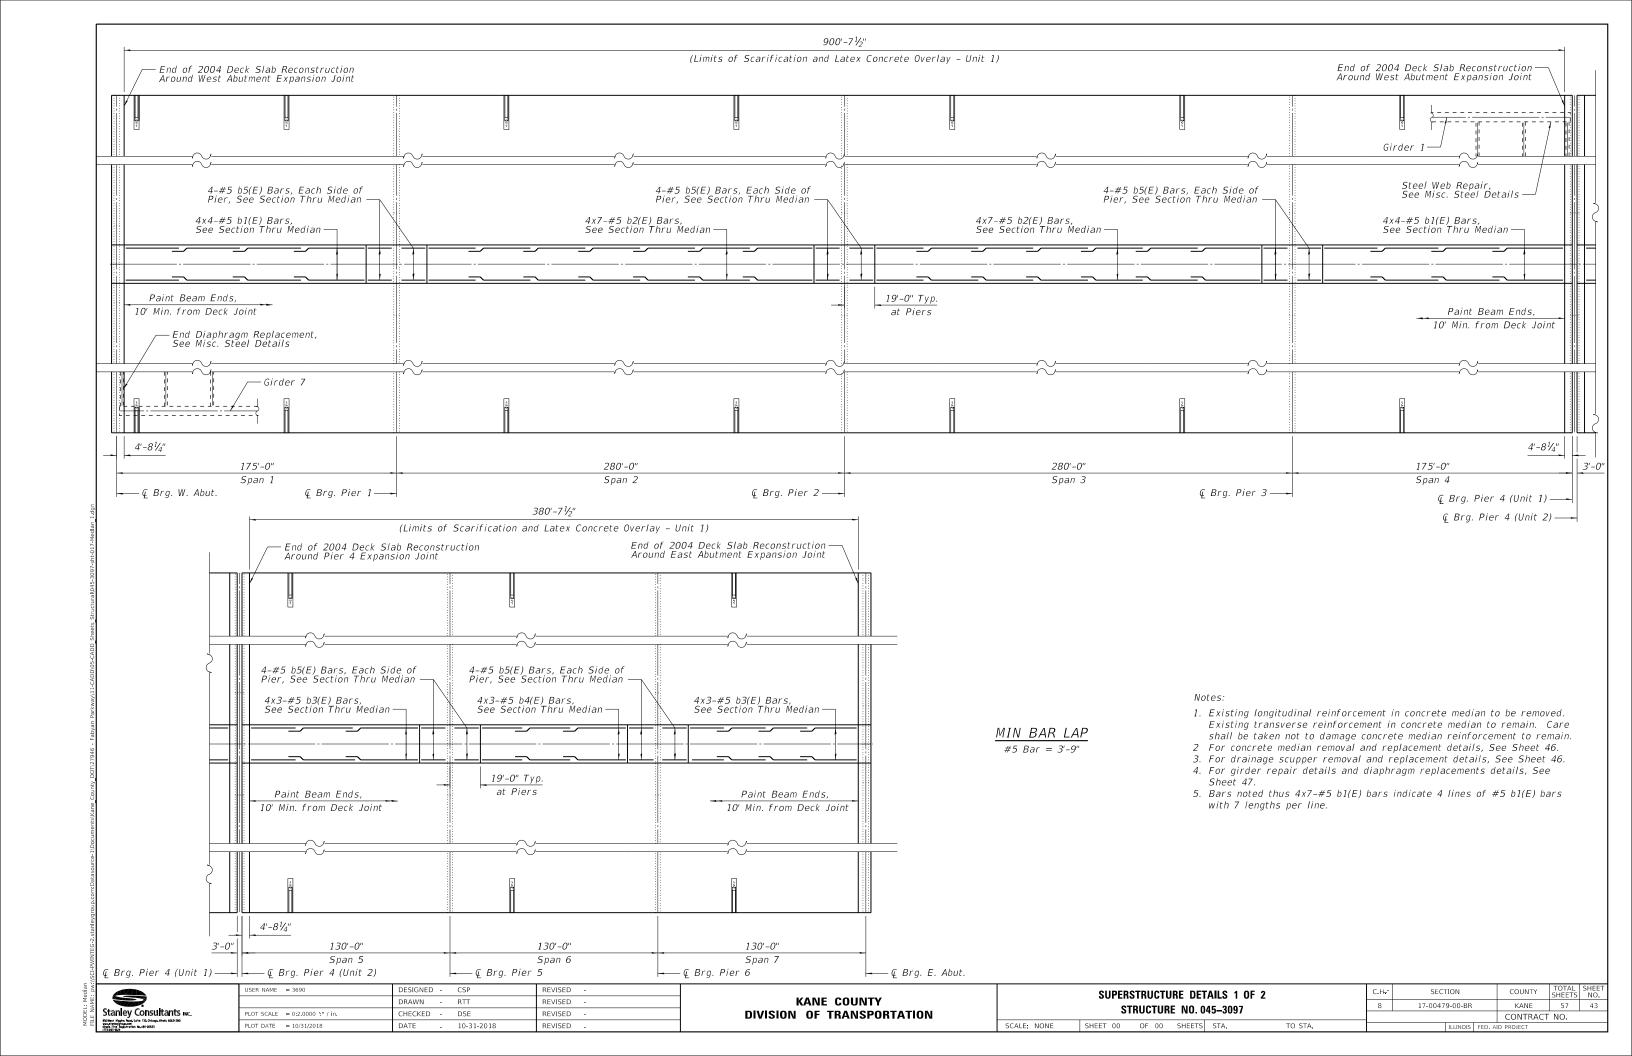

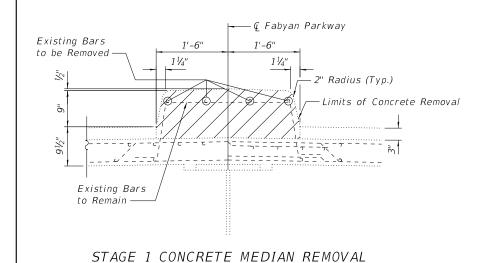

b1(E) Thru
b5(E) Bars

1'-6"
1'-6"
1'-6"
2" Radius (Typ.)

Limits of Concrete Removal

STAGE 1 CONCRETE MEDIAN REPLACEMENT

4" x ¼" Stainless
Steel Strap


Existing
Web Conn.
Plate


Existing
Web


Existing
Bottom
Flange


%" O Stainless
Steel Bolts, Nut

# and Lock Washer <u>SECTION A-A</u> DRAIN PIPE SUPPORT DETAIL

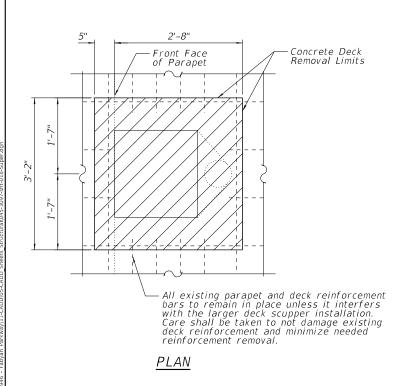

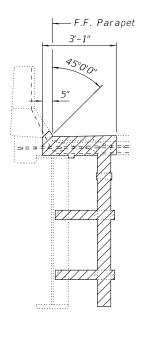

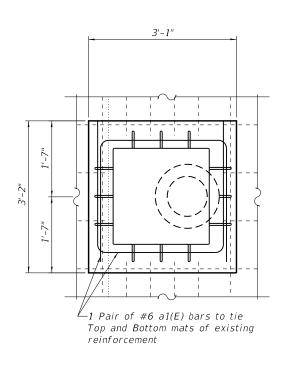

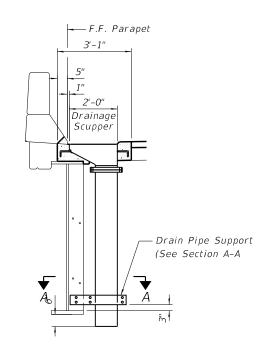

<u>ELEVATION</u> <u>PLAN</u> <u>ELEVATION</u>

# EXISTING DRAINAGE STRUCTURE REMOVAL

(20 Locations)


DRAINAGE STRUCTURE REPLACEMENT

SCALE: NONE

(20 Locations)

|   | <u>SUPI</u> | ERS        | TRUC | CTU | R <i>E</i>      |
|---|-------------|------------|------|-----|-----------------|
|   | BILL        | 0 <i>F</i> | MAT  | ERI | $\overline{AL}$ |
| _ |             | 0.1        |      |     |                 |

|                   | DILL                | 01 1   | IMI LIVI. | <u> </u> |  |  |
|-------------------|---------------------|--------|-----------|----------|--|--|
| Bar               | No.                 | Size   | Length    | Shape    |  |  |
| b1(E)             | 32                  | #5     | 40'-7"    |          |  |  |
| b2(E)             | 56                  | #5     | 37'-9"    |          |  |  |
| b3(E)             | 24                  | #5     | 37'-10"   |          |  |  |
| b4(E)             | 12                  | #5     | 33'-1"    |          |  |  |
| b5(E)             | 40                  | #5     | 18'-8"    |          |  |  |
| a1(E)             | 80                  | #6     | 7'-10"    | Ш        |  |  |
|                   |                     |        |           |          |  |  |
| Concre            | te Rem              | oval   | Cu Yd     | 116      |  |  |
| Concre            | te                  |        | Cu Yd     | 120      |  |  |
| Supers            | structur            | e      |           |          |  |  |
| Bridge            | Deck                |        | Sq Yd     | 7,493    |  |  |
| Groovii           | ng                  |        |           |          |  |  |
| Protec            | tive Coa            | ət     | Sq Yd     | 8,075    |  |  |
| Cleanii           | ng And              |        | L Sum     | 1        |  |  |
| Paintin           | ng Strud            | tural  |           |          |  |  |
| Steel, Location 1 |                     |        |           |          |  |  |
| Cleaning And      |                     |        | L sum     | 1        |  |  |
| Paintin           | ng Strud            |        |           |          |  |  |
| Steel,            | Locatio.            | n 2    |           |          |  |  |
| Cleanir           | ng And              |        | L sum     | 1        |  |  |
|                   | ng Strud            |        |           |          |  |  |
| Steel,            | Locatio             | n 3    |           |          |  |  |
| Cleanir           |                     |        | L sum     | 1        |  |  |
| Paintin           | ig Strud            | tural  |           |          |  |  |
| Steel,            | Steel, Location 4   |        |           |          |  |  |
| Reinf o.          | Reinforcement Bars, |        |           | 6,650    |  |  |
|                   | Coated              |        |           |          |  |  |
| Bridge Deck Latex |                     |        | Sq Yd     | 8,075    |  |  |
| Concre            | te Over             | lay,   |           |          |  |  |
| 3 Inch            | es                  |        |           |          |  |  |
| 1 -               | Bridge Deck         |        |           | 8,511    |  |  |
| Scarif            | ication             | 3"     |           |          |  |  |
| Draina            | ge Scuj             | opers, | Each      | 20       |  |  |
| Ds-121            | И10                 |        |           |          |  |  |
|                   |                     |        |           |          |  |  |

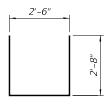


BAR a1(E)

| Stanley Consultants IIIc.                                                                                                     |  |
|-------------------------------------------------------------------------------------------------------------------------------|--|
| 850 Best Higgins Rood, Sufte 130, Chicago, Minols 6063-2801<br>www.stonleygroup.com<br>Minols Firm Registration No., 84-00633 |  |

| USER NAME = 3690                | DESIGNED - | CSP        | REVISED - |
|---------------------------------|------------|------------|-----------|
|                                 | DRAWN -    | RTT        | REVISED - |
| PLOT SCALE = 0:2.0000 ':" / in. | CHECKED -  | DSE        | REVISED - |
| PLOT DATE = 10/31/2018          | DATE -     | 10-31-2018 | REVISED - |
|                                 |            |            |           |

KANE COUNTY
DIVISION OF TRANSPORTATION

| SUPERS                 | STRUCTU | RE DET   | AILS 2 0 | F 2     | C.H. | SECTION     |
|------------------------|---------|----------|----------|---------|------|-------------|
| STRUCTURE NO. 045-3097 |         |          |          |         | 8    | 17-00479-00 |
|                        |         | L 110. U | 10 0007  |         |      |             |
| SHEET 00               | OF 00   | SHEETS   | STA.     | TO STA. |      | ILLIN       |

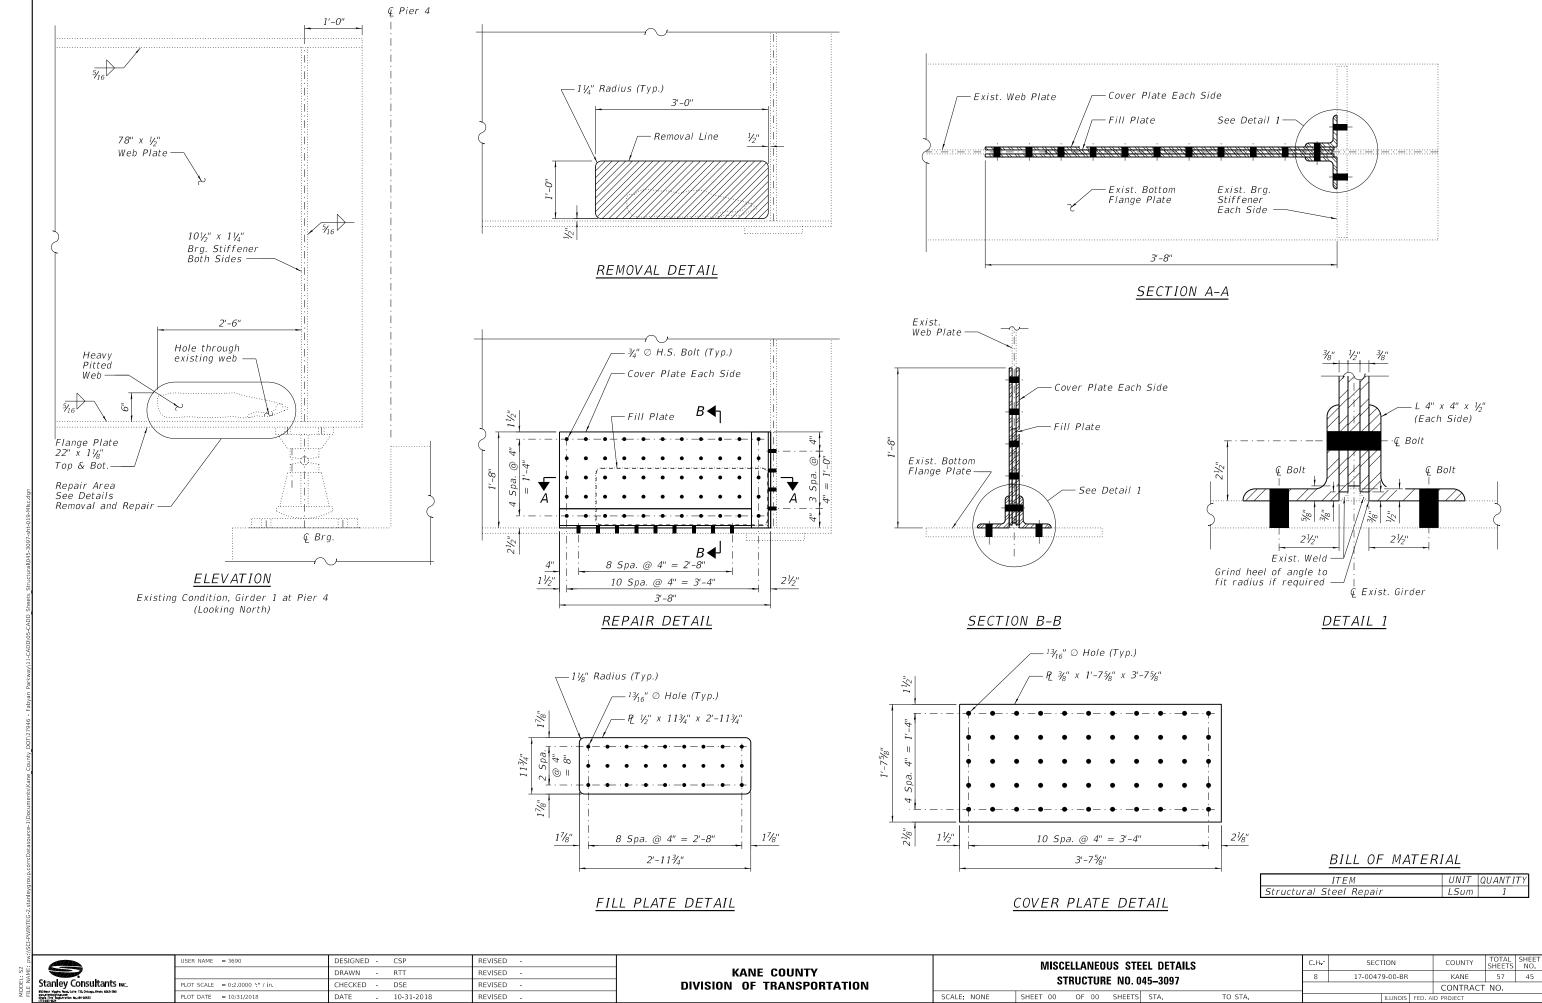


PLOT DATE = 10/31/2018

DATE

10-31-2018

REVISED

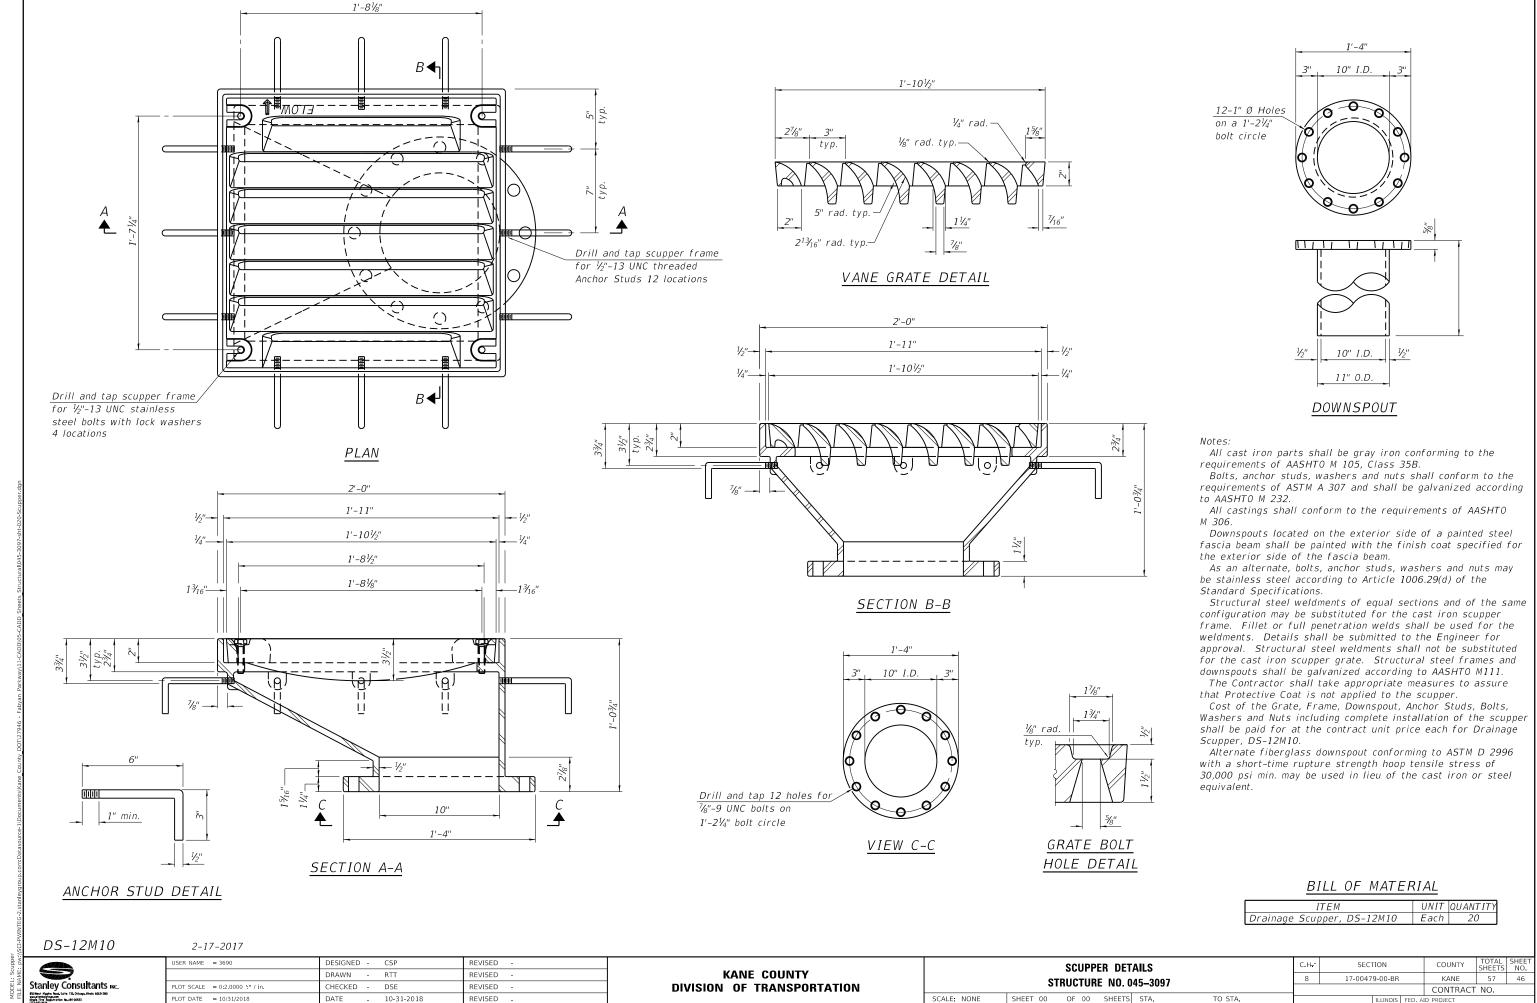

**DIVISION OF TRANSPORTATION** 

SCALE: NONE SHEET 00 OF 00 SHEETS STA.

TO STA.

CONTRACT NO.

LOT SCALE = 0:2.0000 ':" / in.


LOT DATE = 10/31/2018

DSE

10-31-2018

REVISED

REVISED

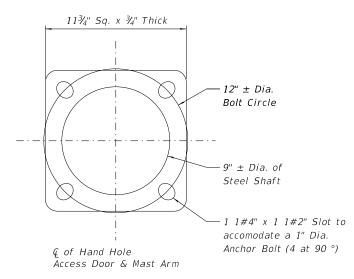


#### BILL OF MATERIAL

|             | Item         |       |       | Uni  | t   | Quantity |
|-------------|--------------|-------|-------|------|-----|----------|
| Cleaning an | d Painting L | .ight | Poles | Lump | Sum | 1        |
| Wrap Base,  | 24 inch      |       |       | Eac  | :h  | 12       |

# DETAIL 1

|                             | FIXTURE SCHEDULE                                    |                                                                                                                                                                                                                                                                 |  |  |  |  |
|-----------------------------|-----------------------------------------------------|-----------------------------------------------------------------------------------------------------------------------------------------------------------------------------------------------------------------------------------------------------------------|--|--|--|--|
| MANUFACTURER CATALOG SERIES |                                                     |                                                                                                                                                                                                                                                                 |  |  |  |  |
| SPRING CITY                 | STYLE: HEIGHT: BASE: MATERIAL: FINISH: ACCESS DOOR: | WASHINGTON<br>27 3/4"<br>24" DIAMETER WRAP BASE<br>(A) CAST ALUMINUM ALLOY ANSI 356 PER A.S.T.M. B26-95<br>PRIME PAINT THEN FINISH SHERWIN WILLIAMS ACROLON-PLEASE ADVISE COLOR<br>LOCATED IN BASE SECURED WITH TAMPER PROOF HEX SOCKET SECURITY MACHINE SCREWS |  |  |  |  |

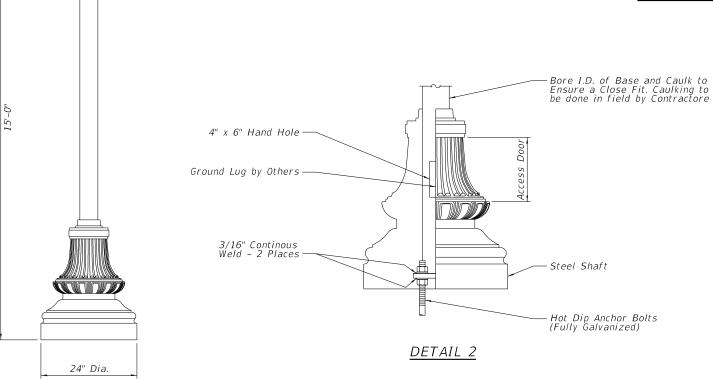

Light Pole


Stale Consultants Inc.


| USER NAME = 3690                | DESIGNED | - | CSP        | REVISED - |
|---------------------------------|----------|---|------------|-----------|
|                                 | DRAWN    | - | RTT        | REVISED - |
| PLOT SCALE = 0:2.0000 ':" / in. | CHECKED  | - | DSE        | REVISED - |
| PLOT DATE = 10/31/2018          | DATE     | - | 10-31-2018 | REVISED - |

KANE COUNTY
DIVISION OF TRANSPORTATION

SCALE: NONE

|  | LIGHT POLE DETAILS               | С.Н <del>.</del> | - | SECTION        | COUNTY      | TOTAL<br>SHEETS | SHEET<br>NO. |
|--|----------------------------------|------------------|---|----------------|-------------|-----------------|--------------|
|  | STRUCTURE NO. 045-3097           |                  |   | 17-00479-00-BR | KANE        | 57              | 47           |
|  |                                  |                  |   |                | CONTRAC     | T NO.           |              |
|  | SHEET 00 OF 00 SHEETS STA TO STA |                  |   | ILLINOIS EED   | AID PROJECT |                 |              |

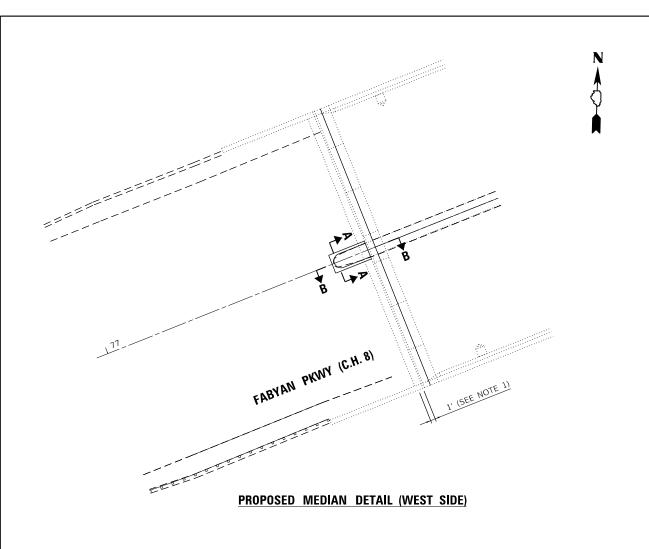


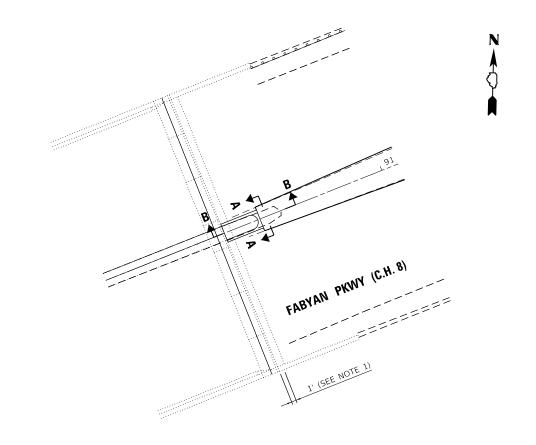



#### PROPOSED MEDIAN DETAIL (EAST SIDE)


#### NOTES:

TRANSITION PROPOSED MEDIAN
 GEOMETRY TO BRIDGE MEDIAN
 GEOMETRY IN THIS AREA.

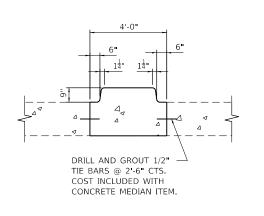

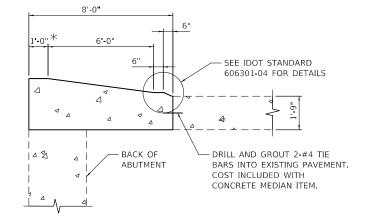

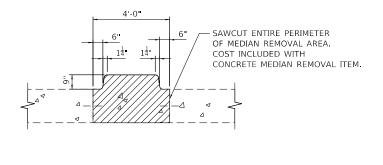

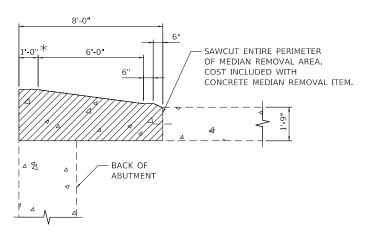


SECTION A-A

SECTION B-B

SECTION A-A

SECTION B-B

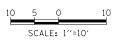

| CZ.   |                                                               |  |
|-------|---------------------------------------------------------------|--|
| ñi l  |                                                               |  |
| NAME: |                                                               |  |
| ž     | Stanley Consultants Inc.                                      |  |
| ш     | Starticy Coristitation.                                       |  |
| =1    | 850 Best Higgins Rood, Suite 130, Chicago, Minels 6063-280    |  |
| ш     | www.stanleygroup.com<br>Whole Firm Realstration No. 184-00533 |  |
|       | (773 693-962)                                                 |  |

| USER NAME = 3690             | DESIGNED - | SP         | REVISED - |
|------------------------------|------------|------------|-----------|
|                              | DRAWN -    | ED         | REVISED - |
| PLOT SCALE = 20.0000 ' / in. | CHECKED -  | DLD        | REVISED - |
| PLOT DATE = 10/31/2018       | DATE -     | 10-31-2018 | REVISED - |

KANE COUNTY
DIVISION OF TRANSPORTATION

|              |         | FABYAI  | N PARK  | WAY  |         | C.H. | SECT | ION      |         | COUNTY    | TO1<br>SHE |
|--------------|---------|---------|---------|------|---------|------|------|----------|---------|-----------|------------|
|              | 8       | 17-0047 | 9-00-BR |      | KANE    | 5    |      |          |         |           |            |
|              |         | MEDIA   | N DET   | TILU |         |      |      |          |         | CONTRACT  | NO         |
| CALE: 1 = 10 | SHEET 1 | OF 4    | SHEETS  | STA. | TO STA. |      |      | ILLINOIS | FED. Al | D PROJECT |            |

## 12 Gauge Telescoping Galvanized Square Post, **Telescoping Sign Post** 2"W x 2"D x min. 10' The post shall be a square tube formed of 12 gauge steel according to the standard specification for cold rolled carbon steel sheets commercial quality ASTM A 1008 (A 1008M). The post shall be formed to size and, if necessary, shall be welded in such a manner that weld or flash shall not interfere with telescoping. Holes $7/16 \pm 1/64$ in. $(11 \pm 0.4 \text{ mm})$ will be spaced on 1 in. (25 mm) centers on at least two opposite sides. The holes shall align to accept Stainless steel bolts and washers used a 3/8 in. (10 mm) bolt through the post at any location. The post shall have a for fastening extruded aluminum sign smooth galvanized finish applied either before or after forming. For all other panels to supports, shall be according regulations refer to Section 1093 of the latest version of Illinois Standard to ASTM A 276, Type 304. Stainless steel Specifications for Bridge and Road Construction. nuts shall be according to ASTM A 240 1" Spacings (A 240M), Type 304. Sign Bases 30" bases for breakaway telescoping sign supports shall be model V-Loc, 200-VS3, for use in soft soil and shall be manufactured by TAPCO (Traffic & Parking Control Co., Inc.) Sign Base Wedge Galvanized Steel Wedge SWI for V-Loc® post bases [2.7mm] [241mm ± 13mm] Base installed 2" Below Surface TOP VIEW Tapco 200-VS3B V-Loc Traffic Post Breakaway Soil Anchor, for use with 2" Length x 2" Width Telescoping Square Post 30.0" ±.50" [752mm ±13mm FRONT VIEW 7.0" ± .50" [178mm ±13mm] Wedge locks [#19mm] HOT ROLLED ROUND BAR Leg angle 2.5"x2.5"x2.5"x30" Fin Dimensions 10x12x12ga 2.5" [63.5mm] STOCK SECTION A-A SIDE VIEW DATE REVISIONS Specifications Kane County Division of Transportation Telescoping Sign Post Specifications Soil Bases Telescoping Sign Post Soil Bases

Stanley Consultants INC.

Stanley Gold Bod Grid 173, Oriosya Hinda 6683-200

Bridge Bod Grid 173, Oriosya Hinda 6683-200


Bridge Bod Bod Grid 173, Oriosya Hinda 6683-200

Bridge Bod Bod Bod Grid 173, Oriosya Hinda 6683-200

| USER NAME = 3690             | DESIGNED - SP     | REVISED - |
|------------------------------|-------------------|-----------|
|                              | DRAWN - ED        | REVISED - |
| PLOT SCALE = 20.0000 ' / in. | CHECKED - DLD     | REVISED - |
| PLOT DATE = 10/31/2018       | DATE - 10-31-2018 | REVISED - |

KANE COUNTY DIVISION OF TRANSPORTATION

| FABYAN PARKWAY |       |      |       |       |        |   |  |  |  |  |
|----------------|-------|------|-------|-------|--------|---|--|--|--|--|
| TE             | LESCO | PING | SIGN  | POST  | DETAIL |   |  |  |  |  |
| СПЕЕТ          | 2     | OE 4 | СПЕЕТ | C CTA |        | T |  |  |  |  |

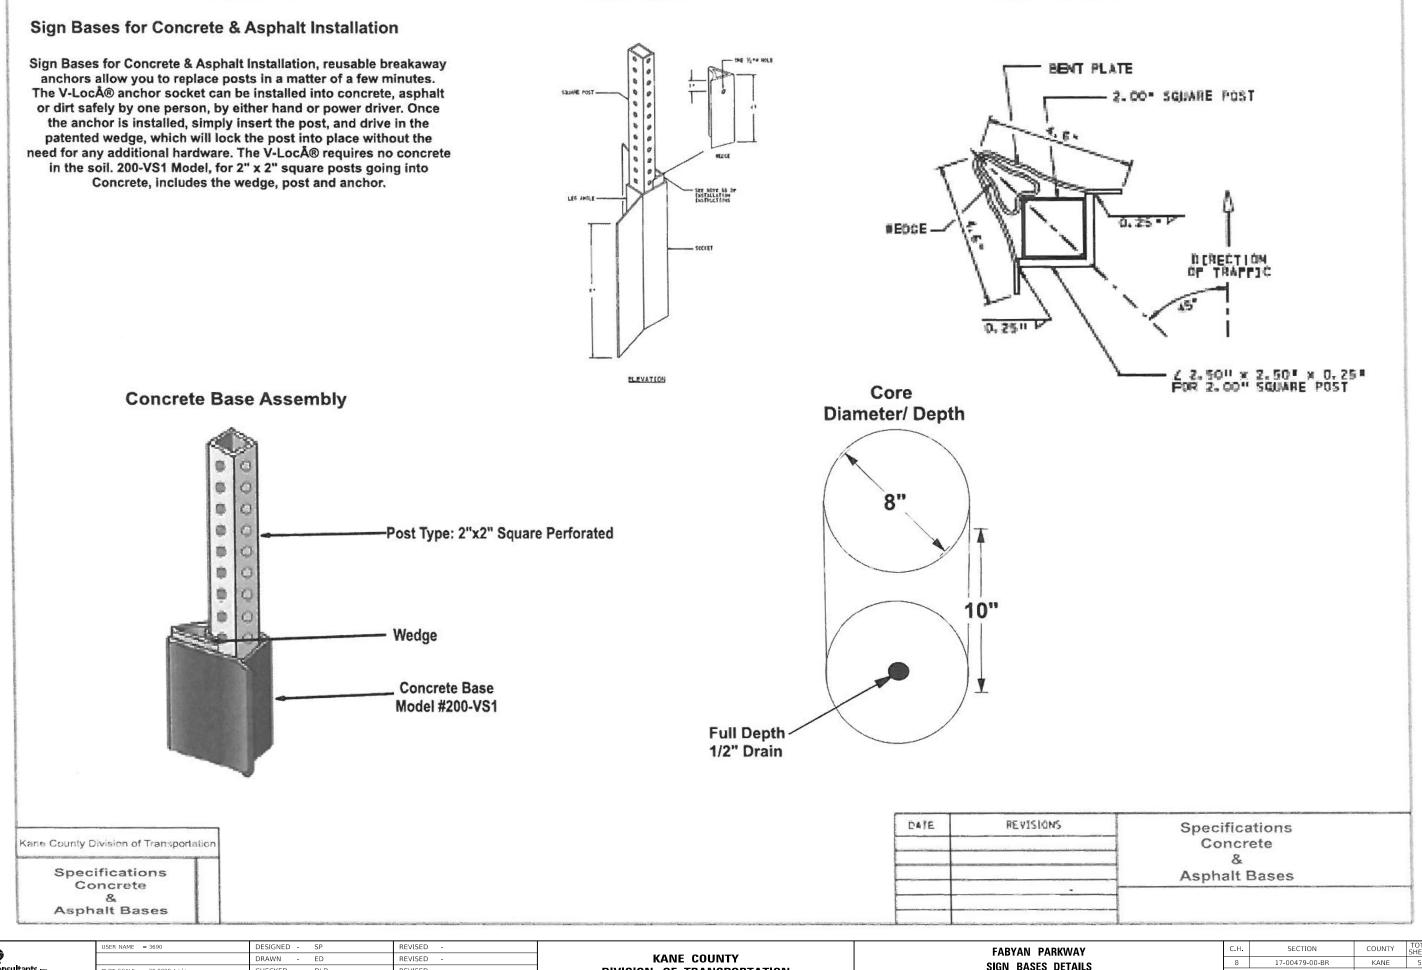


Stanley Consultants INC.
80 Nat Style Box 5/49 Th. Chappe fines 603-300
804 For Replication Build 40653

| USEK NAME = 3090             | DESIGNED - SP     | KENIZED - |
|------------------------------|-------------------|-----------|
|                              | DRAWN - ED        | REVISED - |
| PLOT SCALE = 20.0000 ' / in. | CHECKED - DLD     | REVISED - |
| PLOT DATE = 10/31/2018       | DATE - 10-31-2018 | REVISED - |

**DIVISION OF TRANSPORTATION** 

SCALE: 1'=10'

|  | FABYAN PARKWAY<br>SIGN BASES DETAILS |      |        |      |         | C.H. | SECTION |          |         | COUNTY     | TOTAL<br>SHEETS | SHEET<br>NO. |
|--|--------------------------------------|------|--------|------|---------|------|---------|----------|---------|------------|-----------------|--------------|
|  |                                      |      |        |      |         | 8    | 17-0047 | 9-00-BR  |         | KANE       | 57              | 50           |
|  |                                      |      |        |      |         |      |         |          |         | CONTRACT   | NO.             |              |
|  | SHEET 3                              | OF 4 | SHEETS | STA. | TO STA. |      |         | ILLINOIS | FED. AI | ID PROJECT |                 |              |

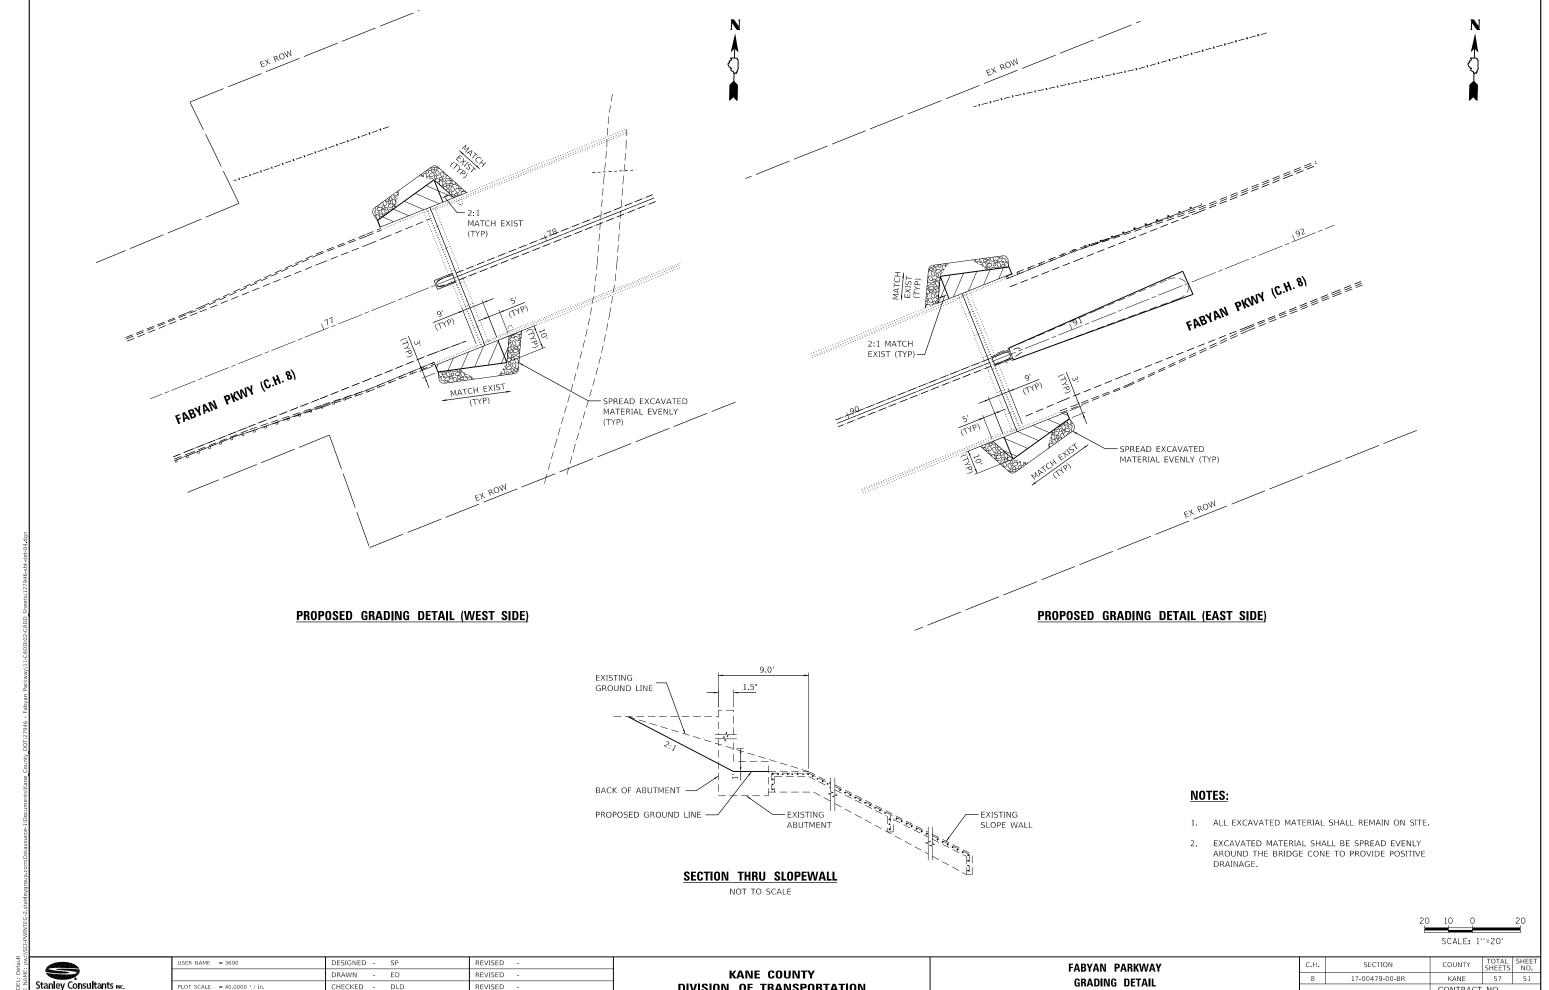

Stanley Consultants INC.

Biolear Signe Root 5/10 170, Octoop shade 5400-240
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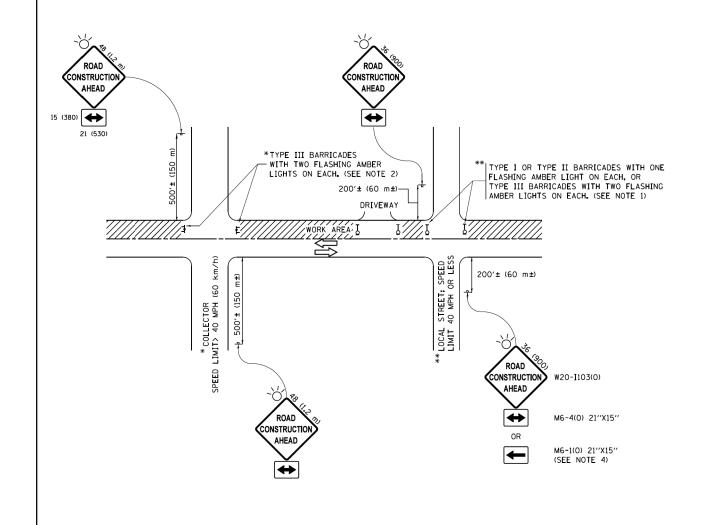
LOT SCALE = 40.0000 / in. CHECKED - DLD REVISED PLOT DATE = 10/31/2018 REVISED 10-31-2018

**DIVISION OF TRANSPORTATION** 

SCALE: 1"=20' SHEET 4 OF 4 SHEETS STA.

TO STA.

CONTRACT NO.



#### NOTES:

- 1. SIDE ROAD WITH A SPEED LIMIT OF 40 MPH (60 km/h) OR LESS AS SHOWN ON THE DRAWING AND AS DIRECTED BY THE ENGINEER:
  - a) ONE "ROAD CONSTRUCTION AHEAD" SIGN 36  $\times$  36 (900 $\times$ 900) WITH A FLASHER MOUNTED ON IT APPROXIMATELY 200' (60 m) IN ADVANCE OF THE MAIN ROUTE.
- b) THE CLOSED PORTION OF THE MAIN ROUTE SHALL BE PROTECTED BY BLOCKING WITH TYPE 1, TYPE II OR TYPE III BARRICADES, 1/3 OF THE CROSS SECTION OF THE CLOSED PORTION.
- 2. SIDE ROAD WITH A SPEED LIMIT GREATER THAN 40 MPH (60 km/h) AS SHOWN ON THE DRAWING AND AS DIRECTED BY THE ENGINEER:
  - ONE "ROAD CONSTRUCTION AHEAD" SIGN 48 x 48 (1,2 m x 1,2 m) WITH A FLASHER MOUNTED ON IT APPROXIMATELY 500" (150 m) IN ADVANCE OF THE MAIN ROUTE.
  - b) THE CLOSED PORTION OF THE MAIN ROUTE SHALL BE PROTECTED BY BLOCKING WITH TYPE III BARRICADES, 1/2 OF THE CROSS SECTION OF THE CLOSED PORTION.
- CONES MAY BE SUBSTITUTED FOR BARRICADES OR DRUMS AT HALF THE SPACING DURING DAY OPERATIONS. CONES SHALL BE A MINIMUM OF 28 (710) IN HEIGHT.
- 4. WHEN THE SIDE RCAD LIES BETWEEN THE BEGINNING OF THE MAINLINE SIGNING AND THE WORK ZONE, A SINGLE HEADED ARROW (MG-1) SHALL BE USED IN LIEU OF THE DOUBLE HEADED ARROW (MG-4).

SCALE: NONE

SHEET 1

- 5. WHEN WORK IS BEING PERFORMED ON A SIDE ROAD OR DRIVEWAY, FOLLOW THE APPLICABLE STANDARD(S), THE DIRECTIONAL ARROW (M6-1 OR M6-4) SHALL BE COVERED OR REMOVED WHEN NO LONGER CONSISTENT WITH THE TRAFFIC CONTROL SET-UP.
- 6. ADVANCE WARNING SIGNS ARE TO BE OMITTED ON DRIVEWAYS UNLESS OTHERWISE SPECIFIED IN THE PLANS OR BY THE FINCINFER
- 7. THE TRAFFIC CONTROL AND PROTECTION FOR SIDE ROADS, INTERSECTIONS, AND DRIVEWAYS SHALL BE INCLUDED IN THE COST OF SPECIFIED TRAFFIC CONTROL STANDARDS OR ITEMS.

All dimensions are in inches (millimeters) unless otherwise shown.

FILE NAME = USER NAME = footemj DESIGNED - L.H.A. REVISED - A. HOUSEH 10-15-96 TRAFFIC CONTROL AND PROTECTION FOR ments\IDOT Offices\District I\Projects\D t**DRAWN**\CADDeta\CADsheets\tc10.dg **STATE OF ILLINOIS** w:\\ILØ84EBIDINTEG.:111:no REVISED -T. RAMMACHER 01-06-00 SIDE ROADS, INTERSECTIONS, AND DRIVEWAYS PLOT SCALE = 50.000 '/ in. CHECKED -REVISED - A. SCHUETZE 07-01-1 **DEPARTMENT OF TRANSPORTATION** CONTRACT NO.


ILLINOIS FED. AID PROJECT PLOT DATE = 9/15/2016 REVISED - A. SCHUETZE 09-15-SCALE: NONE SHEET 1 OF 1 SHEETS STA.

Stanley Consultants Inc.

| USER NAME = 3690         | DESIGNED - | SP         | REVISED - |
|--------------------------|------------|------------|-----------|
|                          | DRAWN -    | ED         | REVISED - |
| PLOT SCALE = 2.0000 / in | CHECKED -  | DLD        | REVISED - |
| PLOT DATE = 10/31/2018   | DATE -     | 10-31-2018 | REVISED - |


| K        | ANE  | COUNTY         |
|----------|------|----------------|
| DIVISION | OF T | TRANSPORTATION |

|                  | FABYAN PARKWAY    |        |      |         |                | SECTION  |        | COUNTY     | TOTAL<br>SHEETS | SHEET<br>NO. |
|------------------|-------------------|--------|------|---------|----------------|----------|--------|------------|-----------------|--------------|
| STANDARD DETAILS |                   |        |      | 8       | 17-00479-00-BR |          | KANE   | 57         | 52              |              |
|                  | STAINDARD DETAILS |        |      |         |                |          |        | CONTRACT   | NO.             |              |
| 1                | OF 6              | SHEETS | STA. | TO STA. |                | ILLINOIS | FED. A | ID PROJECT |                 |              |

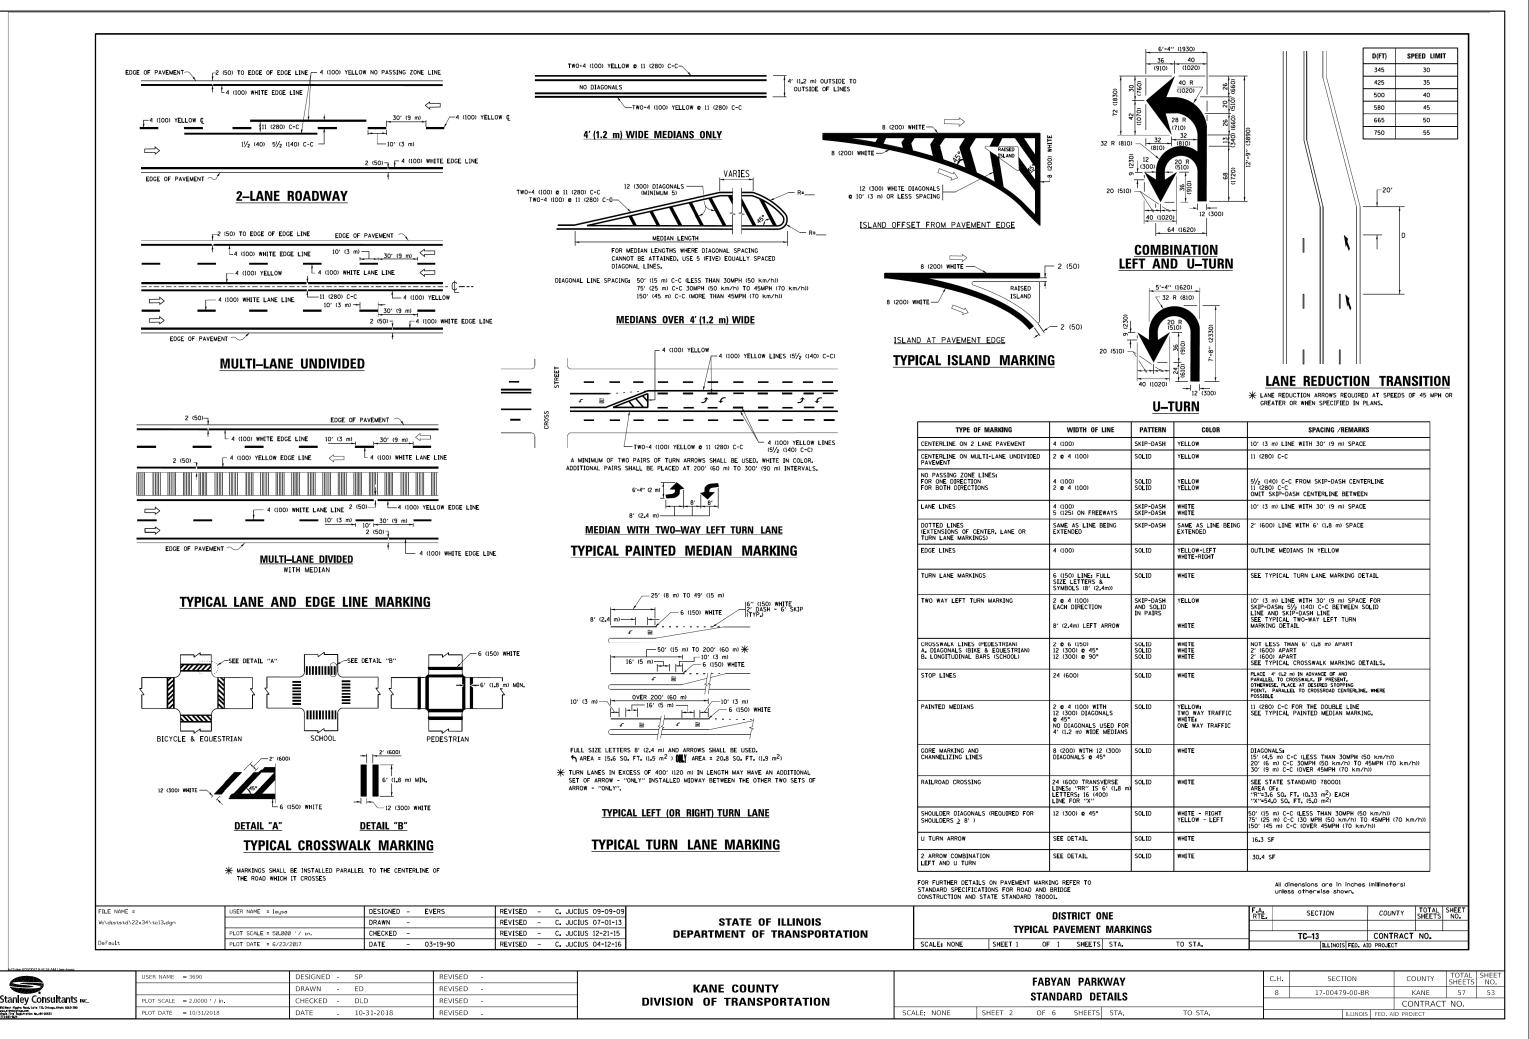


MODEL: Default FILE NAME: pw:\\S


# TURN BAY ENTRANCE AT START OF LANE CLOSURE TAPER

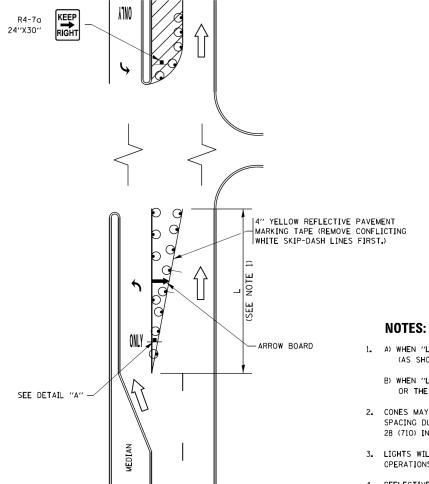

- 1. A) WHEN "L" IS  $\leq$  THE STORAGE LENGTH OF THE TURN LANE (AS SHOWN IN FIG. 1), USE FIGURE 1.
  - B) WHEN "L" IS > THE STORAGE LENGTH OF THE TURN LANE OR THE TURN LANE IS WITHIN THE LANE CLOSURE, USE FIGURE 2.
- 2. CONES MAY BE SUBSTITUTED FOR BARRICADES OR DRUMS AT HALF THE SPACING DURING DAY OPERATIONS. CONES SHALL BE A MINIMUM OF 28 (710) IN HEIGHT.
- 3. LIGHTS WILL NOT BE REQUIRED ON BARRICADES OR DRUMS FOR DAY CPERATIONS. ALL LIGHTS SHALL BE MONODIRECTIONAL.
- 4. REFLECTIVE TEMPORARY PAVEMENT MARKINGS SHALL BE PLACED THROUGHOUT THE BARRICADED AREAS OF EACH TURN BAY AS SHOWN WHERE THE CLOSURE TIME IS GREATER THAN FOURTEEN (14) DAYS.
- 5. THIS APPLICATION ALSO APPLIES WHEN WORK IS BEING PERFORMED IN THE RIGHT LANE(S) AND THE RIGHT TURN BAY IS TO REMAIN OPEN. UNDER THIS CONDITION, "RIGHT TURN LANE" R3-I100R 24 x 24 (600 x 600) AND M6-2R 21 x 15 (530 x 380) SHALL BE USED.
- 6. THESE CONTROLS SHALL SUPPLEMENT MAINLINE TRAFFIC CONTROL
- 7. THE SIGNS SHALL BE MOUNTED ABOVE THE BARRICADES/DRUMS ON SEPARATE SIGN SUPPORTS THAT MEET NCHRP 350 OR MASH PREQUIREMENTS.
- 8. TRAFFIC CONTROL AND PROTECTION AT TURN BAYS (TO REMAIN OPEN TO TRAFFIC) SHALL BE INCLUDED IN THE COST OF SPECIFIED TRAFFIC CONTROL STANDARDS OR ITEMS.

# **TURN BAY ENTRANCE** WITHIN A LANE CLOSURE

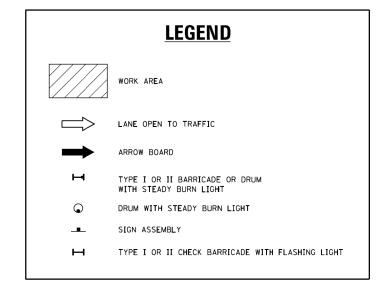

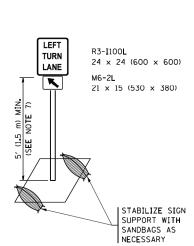

CONFLICTING PAVEMENT MARKING REMOVAL (TYP.) - SEE DETAIL "A" 6" WHITE REFLECTIVE PAVEMENT MARKING TAPE 4" YELLOW REFLECTIVE PAVEMENT MARKING TAPE REMOVE CONFLICTING WHITE SKIP-DASH LINES FIRST.)

FIGURE 2

**DETAIL A** 

SCALE: NONE

All dimensions are in inches (millimeters) unless otherwise shown.

USER NAME = footemj REVISED -T. RAMMACHER 09-08-94 REVISED - R. BORO 09-14-09 FILE NAME = TRAFFIC CONTROL AND PROTECTION AT TURN BAYS ments\IDOT Offices\District 1\Projects\D **STATE OF ILLINOIS** \*:\\ILØ84EBIDINTEG.:11:r SHEWISED - A. SCHUETZE 07-01-13 (TO REMAIN OPEN TO TRAFFIC) PLOT SCALE = 50.0000 '/ in. REVISED - A. HOUSEH 10-12-96 REVISED - A. SCHUETZE 09-15-16 **DEPARTMENT OF TRANSPORTATION** TC-14 | CUNTIS CONTRACT NO. PLOT DATE = 9/15/2016 REVISED -T. RAMMACHER 01-06-00 REVISED SHEET 1 OF 1 SHEETS STA.

Stanley Consultants IIIIC BO Best Mogree Root Suffer 170, Onloops, Whole 6063-200 Wild Time Roof Professor

JSER NAME = 3690 DESIGNED - SP REVISED DRAWN - ED REVISED HECKED -DLD REVISED PLOT DATE = 10/31/2018 10-31-2018 REVISED


FIGURE 1

**KANE COUNTY** 

FABYAN PARKWAY STANDARD DETAILS SHEET 3 OF 6 SHEETS STA. TO STA.

SECTION COUNTY KANE 57 54 17-00479-00-BR CONTRACT NO.


**DIVISION OF TRANSPORTATION** 

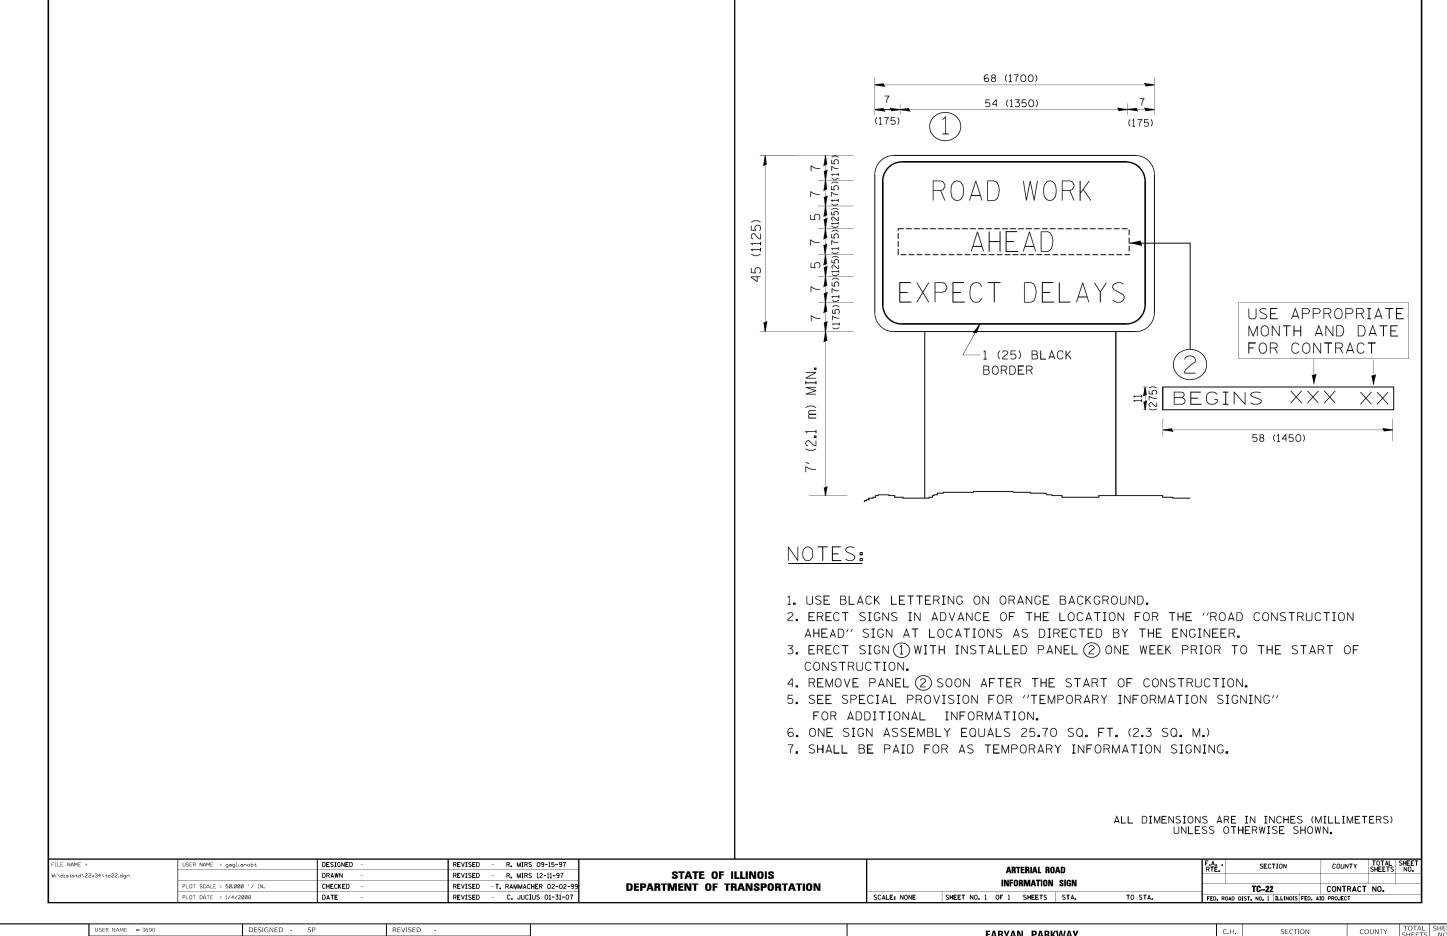

Stanley Consultants Inc.
80ton (4gen loos 5470 15), Chicaya, Bride (400-300
80ton (4gen loos 5470 15), Chicaya, Bride (400-300
80ton (470-400)
80ton (470-400)

DRAWN - ED REVISED PLOT SCALE = 2,0000 ' / in. CHECKED - DLD REVISED PLOT DATE = 10/31/2018 DATE - 10-31-2018 REVISED -

KANE COUNTY
DIVISION OF TRANSPORTATION

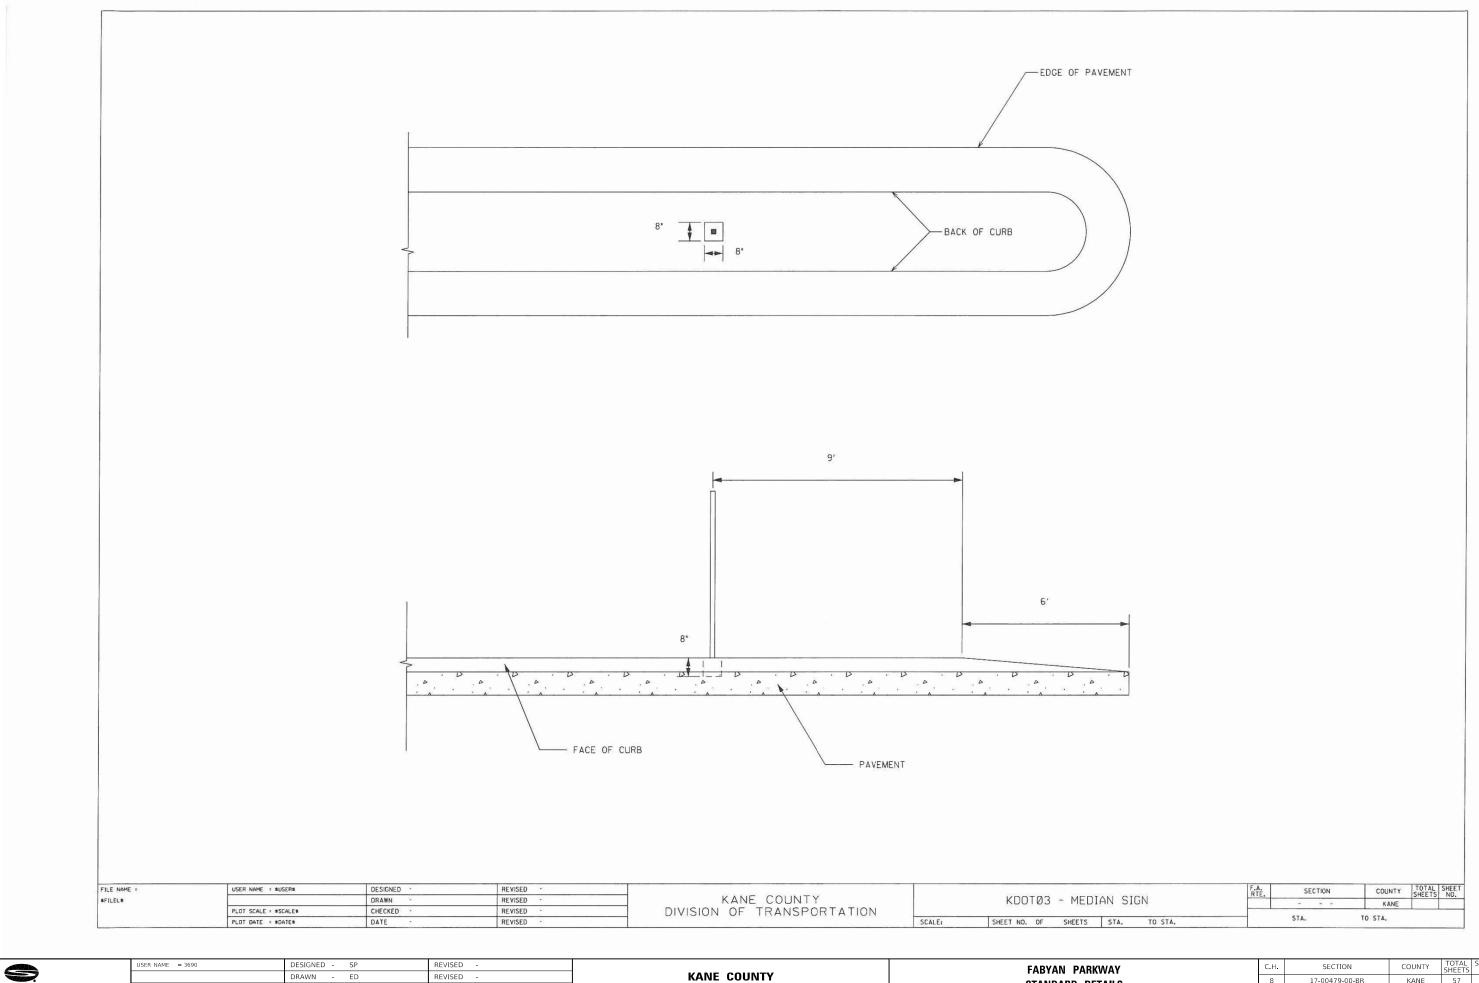

Stanley Consultants INC.

800Net Stigle Ross 5/16 193, Orlowy Briefs 6903-290
was Stray Concern
(17) 841-744 (17) 1930 (17) 1930
(17) 841-744 (17) 1930 (17) 1930
(17) 841-744 (17) 1930


DRAWN - ED REVISED -PLOT SCALE = 2.0000 / in. CHECKED - DLD REVISED -PLOT DATE = 10/31/2018 DATE - 10-31-2018 REVISED

**DIVISION OF TRANSPORTATION** 

STANDARD DETAILS SCALE: NONE SHEET 5 OF 6 SHEETS STA. TO STA.

COUNTY TOTAL SHEET NO.

KANE 57 56 17-00479-00-BR CONTRACT NO.

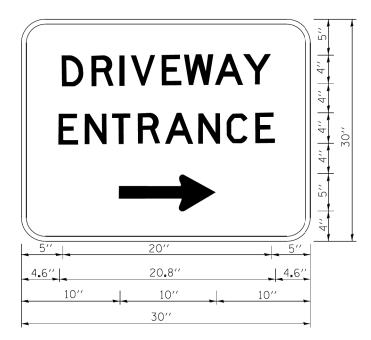

3.0" RADIUS, 0.5" BORDER, WHITE ON GREEN; REFLECTORIZED "DRIVEWAY" D; "ENTRANCE" D; STANDARD ARROW CUSTOM 12.0" x 5.0"

#### NOTES:

- 1. HALF OF THE SIGNS WILL REQUIRE A LEFT HAND FACING ARROW.
- 2. TWO SIGNS SHALL BE USED AT EACH COMMERCIAL ENTRANCE PLACED BACK-TO-BACK: ONE WITH A RIGHT HAND ARROW (SHOWN) SHALL BE PLACED ON THE NEAR RIGHT SIDE THE DRIVEWAY AND ONE WITH A LEFT HAND ARROW SHALL BE PLACED ON THE FAR LEFT SIDE OF THE DRIVEWAY.
- 3. SIGNS TO BE PAID FOR AS ITEM "TEMPORARY INFORMATION SIGNING".

| FILE NAME =                              | USER NAME = gaglianobt     | DESIGNED - | REVISED - C. JUCIUS 02-15-07 |
|------------------------------------------|----------------------------|------------|------------------------------|
| c:\pw_work\pwidot\gaglianobt\d0108315\tc | 26.dgn                     | DRAWN -    | REVISED -                    |
|                                          | PLOT SCALE = 50.000 '/ in. | CHECKED -  | REVISED -                    |
|                                          | PLOT DATE = 12/13/2012     | DATE -     | REVISED -                    |

| STATE OF ILLINOIS            |
|------------------------------|
| DEPARTMENT OF TRANSPORTATION |

| DRIVEWAY ENTRANCE SIGNING |             |                         | F.A.<br>RTE | SECTION | COUNTY TOTAL SHEET SHEETS NO.                   |       |              |  |  |
|---------------------------|-------------|-------------------------|-------------|---------|-------------------------------------------------|-------|--------------|--|--|
| -                         |             |                         |             |         |                                                 |       |              |  |  |
| ١                         |             |                         |             |         | _                                               | TC-26 | CONTRACT NO. |  |  |
| - 1                       | SCALE: NONE | SHEET NO. 1 OF 1 SHEETS | STA.        | TO STA. | FED. ROAD DIST. NO. 1 ILLINOIS FED. AID PROJECT |       |              |  |  |

Stanley Consultants IIIC.

| USER NAME = 3690            | DESIGNED - | SP         | REVISED - |
|-----------------------------|------------|------------|-----------|
|                             | DRAWN -    | ED         | REVISED - |
| PLOT SCALE = 2.0000 ' / in. | CHECKED -  | DLD        | REVISED - |
| PLOT DATE = 10/31/2018      | DATE -     | 10-31-2018 | REVISED - |

| KANE COUNTY |             |                       |  |  |  |  |
|-------------|-------------|-----------------------|--|--|--|--|
| DIVISION    | <b>OF</b> 1 | <b>TRANSPORTATION</b> |  |  |  |  |

|  | FABYAN PARKWAY<br>Standard Details             |  | C.H. SE                   |                | ECTION |  | COUNTY   | TOTAL<br>SHEETS | SHEET<br>NO. |
|--|------------------------------------------------|--|---------------------------|----------------|--------|--|----------|-----------------|--------------|
|  |                                                |  | 8                         | 17-00479-00-BR |        |  | KANE     | 57              | 57           |
|  | STANDARD DETAILS                               |  |                           |                |        |  | CONTRACT | ΓNO.            |              |
|  | SCALE: NONE   SHEET 6 OF 6 SHEETS STA. TO STA. |  | ILLINOIS FED. AID PROJECT |                |        |  |          |                 |              |