
STATE OF ILLINOIS DEPARTMENT OF TRANSPORTATION DIVISION OF HIGHWAYS

PLANS FOR PROPOSED FEDERAL AID HIGHWAY

F.A.U. 1542 (JERICHO ROAD) **OVER BLACKBERRY CREEK** BRIDGE REPLACEMENT **SECTION 04-00329-00-BR PROJECT BRM-8003(839)** SUGAR GROVE TOWNSHIP KANE COUNTY JOB NO. C-91-339-07

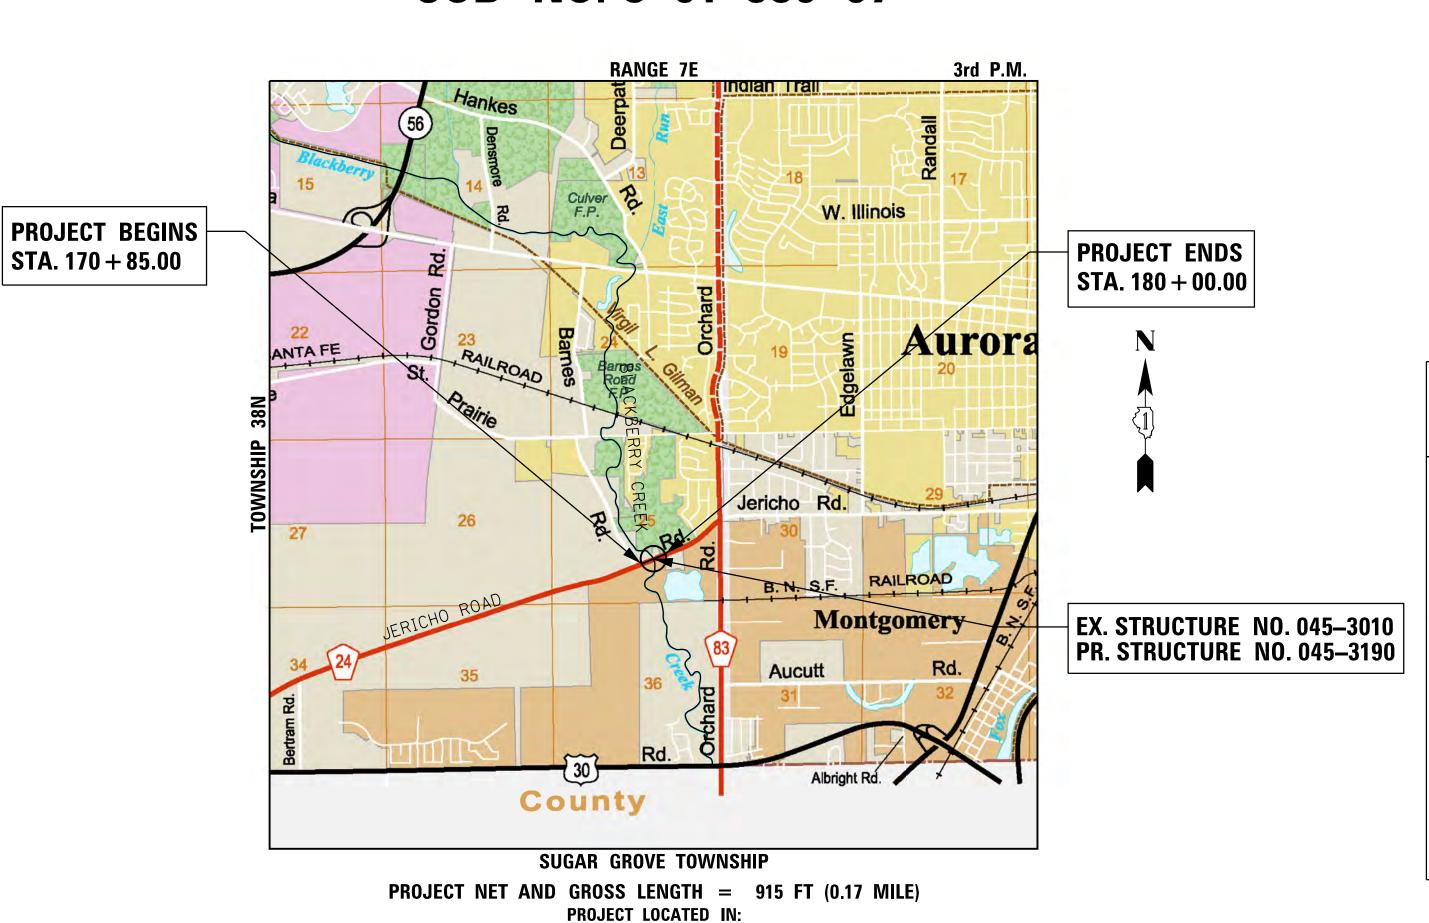

MARSHALL CHAMPAIGN VERMILION WASHINGTON **LOCATION OF SECTION INDICATED THUS: -**

1542

04-00329-00-BR

ILLINOIS CONTRACT NO.

STATE OF ILLINOIS **DEPARTMENT OF TRANSPORTATION DIVISION OF HIGHWAYS APPROVED COUNTY ENGINEER, KANE COUNTY** DISTRICT 1 ENGINEER OF LOCAL ROADS & STREETS RELEASING FOR BID BASED ON LIMITED **REVIEW** DEPUTY DIRECTOR OF HIGHWAYS, REGION 1 ENGINEER

FOR INDEX OF SHEETS, SEE SHEET NO. 2

PROJECT LOCATED IN KANE COUNTY

TRAFFIC DATA

SCHAUMBURG, IL

70

RIDDLE,

CHARLES

OFFICE

AND

2008 ADT = 5,6002030 ADT = 10,000**DESIGN SPEED: 55 MPH DESIGN DESIGNATION:** MINOR ARTERIAL (URBAN)

FULL SIZE PLANS HAVE BEEN PREPARED USING STANDARD ENGINEERING SCALES. REDUCED SIZED PLANS WILL NOT CONFORM TO STANDARD SCALES. IN MAKING MEASUREMENTS ON REDUCED PLANS, THE ABOVE SCALES MAY BE USED.

J.U.L.I.E. JOINT UTILITY LOCATION INFORMATION FOR EXCAVATION 1-800-892-0123 OR 811

> PAUL J. FITPATRICK ILLINOIS REG. PROFESSIONAL ENGINEER NO. 062-047637 **EXPIRATION DATE 11–30–2013**

SECTION 25 IN TOWNSHIP 38N, RANGE 7E, OF THE THIRD PRINCIPAL MERIDIAN,

KANE COUNTY, ILLINOIS

WILLS BURKE KELSEY ASSOCIATES LTD.

116 West Main Street, Suite 201
St. Charles, Illinois 60174

PRINTED BY THE AUTHORITY OF THE STATE OF ILLINOIS

CONTRACT NO.

GENERAL NOTES

- 1. ALL CONSTRUCTION SHALL BE IN CONFORMANCE WITH THE APPLICABLE REQUIREMENT SET FORTH IN "THE CONSTRUCTION SPECIFICATIONS FOR ROAD AND BRIDGE CONSTRUCTION" ADOPTED JANUARY 1, 2012 THEREINAFTER REFERRED TO AS STANDARD SPECIFICATIONS, THE LATEST EDITION OF THE "ILLINOIS MANUAL ON UNIFORM MANUAL TRAFFIC CONTROL DEVICES FOR STREETS AND HIGHWAYS" IN EFFECT ON THE DATE OF INVITATION FOR BIDS; THE "SUPPLEMENTAL SPECIFICATIONS AND RECURRING SPECIAL PROVISIONS" LATEST EDITION; INTERIM SPECIAL PROVISIONS AS INCLUDED IN THE CONTRACT DOCUMENTS; AND THE DETAILS AND STANDARDS CONTAINED IN THESE
- 2. BEFORE STARTING ANY EXCAVATIONS, THE CONTRACTOR SHALL CALL "JULIE" AT 1-800-892-0123 FOR FIELD LOCATIONS OF BURIED ELECTRIC, TELEPHONE AND GAS FACILITIES. (48 HOUR NOTIFICATION IS REQUIRED)
- 3. THE LOCATIONS OF THE EXISTING UTILITIES, AS SHOWN ON THE DRAWINGS, REPRESENT DATA RECEIVED FROM VARIOUS SOURCES, IT IS NOT GUARANTEED TO BE CORRECT OR ALL INCLUSIVE. THE CONTRACTOR SHALL CONDUCT HIS OWN INVESTIGATIONS INTO THE LOCATION, SIZE, DEPTH, AND NATURE OF ANY AND ALL EXISTING UTILITIES WHICH MAY INTERFERE WITH THE WORK UNDER THIS CONTRACT. ANY EXISTING UTILITIES WHICH ARE TO REMAIN IN SERVICE SHALL BE FULLY PROTECTED BY THE CONTRACTOR AND ANY DAMAGE CAUSED BY THE CONSTRUCTION SHALL BE IMMEDIATELY REPAIRED AT NO ADDITIONAL COST IN ACCORDANCE WITH ARTICLE 105.07.
- 4. THE CONTRACTOR SHALL COORDINATE CONSTRUCTION ACTIVITIES WITH UTILITY COMPANIES.
- 5. ALL WORK SHALL BE COMPLETED WITHIN THE LIMITS OF THE PROJECT SHOWN. NO EQUIPMENT, MATERIALS OR A YARD OR FIELD OFFICE SHALL BE SET UP OR STORED ON TOWNSHIP OR PRIVATE PROPERTY WITHOUT WRITTEN PERMISSION OF THE ENGINEER.
- 6. MAINTENANCE OF TRAFFIC-GENERAL: TRAFFIC CONDITIONS, ACCIDENTS AND OTHER UNFORESEEN EMERGENCY CONDITIONS MAY REQUIRE THE ENGINEER TO RESTRICT, MODIFY OR REMOVE LANE CLOSURES OR CHANNELIZATION SHOWN IN THE PLANS. THE CONTRACTOR SHALL RESPOND WITHIN 30 MINUTES OF THE TIME OF NOTIFICATION BY THE ENGINEER FOR THE MAINTENANCE OF TRAFFIC CONTROL DEVICES.
- 7. TRAFFIC CONTROL DEVICES: ALL TRAFFIC CONTROL DEVICES USED FOR THE MAINTENANCE OF TRAFFIC AS DETAILED ON THE PLANS SHALL BE REFLECTORIZED PRIOR TO INSTALLATION AND CLEANED AS NECESSARY THROUGHOUT THE DURATION OF THE CONTRACT.
- 8. BARRICADES: THE CONTRACTOR SHALL PROVIDE AND INSTALL TWO (2) WEIGHTED SANDBAGS ON EACH TYPE I OR TYPE II BARRICADE USED- ONE (1) WEIGHTED SAND BAG ACROSS EACH BOTTOM RAIL.

DRAINAGE NOTES

- DURING CONSTRUCTION OPERATIONS ALL LOOSE MATERIAL DEPOSITED IN THE FLOW LINE OF DRAINAGE STRUCTURES AND TEMPORARY DITCHES THAT OBSTRUCTS THE NATURAL FLOW OF WATER SHALL BE REMOVED AT THE CLOSE OF EACH WORKING DAY AT THE CONCLUSION OF THE CONSTRUCTION OPERATIONS. ALL DRAINAGE STRUCTURES SHALL BE CLEANED AS NECESSARY TO INSURE THAT THEY ARE FREE FROM ALL DIRT AND DEBRIS PRIOR TO THE FINAL INSPECTION OF THE PROJECT. THIS WORK WILL NOT BE MEASURED SEPERATELY FOR PAYMENT, BUT SHALL BE CONSIDERED INCLUDED IN THE COST OF EARTH EXCAVATION.
- 2. ANY FARM DRAIN, FIELD TILE SYSTEM OR OTHER UNDERGROUND TILE FACILITY ENCOUNTERED IN THE WORK SHALL BE LOCATED AND STAKED AND REPORTED TO THE RESIDENT ENGINEER. ANY DRAINAGE LINES WHICH ARE CUT OR DAMAGED BY GRADING, TRENCHING, EXCAVATION OR OTHER CONSTRUCTION ACTIVITIES SHALL BE REPAIRED SO AS TO MAINTAIN ITS ORIGINAL ALIGNMENT. IF THIS CANNOT BE ACCOMPLISHED, THE TILE SHALL BE REPAIRED AND CONNECTED TO THE PROPOSED STORM SEWER SYSTEM IN SUCH A MANNER AS TO RENDER THE LINES USABLE FOR THE PURPOSES INTENDED. THE WORK SHALL BE DONE IN ACCORDANCE WITH THE SPECIAL PROVISION "DRAIN TILE REPAIR".
- THE COST OF RESHAPING PROPOSED AND EXISTING DITCHES (IF REQUIRED) SHALL NOT BE PAID FOR SEPARATELY BUT SHALL BE INCLUDED IN THE COST OF EARTH EXCAVATION PER ARTICLE 202.06.

KANE-DUPAGE SOIL & WATER CONSERVATION DISTRICT NOTES

- 1. THE CONTRACTOR AND ENGINEER SHALL MEET WITH THE KANE-DUPAGE SOIL & WATER CONSERVATION DISTRICT TO COORDINATE ALL IN-STREAM WORK ACTIVITIES.
- 2. THE CONTRACTOR'S IN-STREAM WORK PLAN SHALL BE SUBMITTED TO THE SOIL & WATER CONSERVATION DISTRICT AND KANE COUNTY FOR REVIEW AND APPROVAL PRIOR TO STARTING ANY WORK. THERE WILL NO ADDITIONAL COMPENSATION FOR THIS PROVIDING THE PLAN AND COORDINATION.
- 3. SEE ERSOION CONTROL PLAN SHEETS FOR ADDITIONAL DETAILS, CONDTIONS AND NOTES.

PRESERVATION OF TREES AND SHRUBS

1. THE CONTRACTOR SHALL REMOVE ONLY THOSE TREES AND SHRUBS SO DESIGNATED BY THE ENGINEER, OR THOSE, WHICH DIRECTLY INTERFERE WITH THE SAFETY OR QUALITY OF CONSTRUCTION PRACTICES. THE CONTRACTOR SHALL EXERCISE EXTREME CARE WHEN WORKING NEAR EXISTING TREES AND SHRUBS TO AVOID DAMAGING THOSE NOT SCHEDULED FOR REMOVAL, AND SHALL REPLACE ANY DAMAGED PLANTS AT HIS OWN EXPENSE.

EARTHWORK AND ROADWAY

- EARTHWORK SHALL BE PAID FOR ONLY ONCE, REGARDLESS OF STAGING. STOCK PILING OF MATERIALS FOR LATER USE AND REDISTRIBUTION SHALL BE DONE AT THE CONTRACTOR'S EXPENSE. STOCK PILING NECESSARY FOR RESPREADING IN SHOULDERS, CONSTRUCTING EMBANKMENTS, CUT OR BORROW AREAS SHALL BE CONSIDERED INCLUDED IN THE UNIT PRICE OF EARTH EXCAVATION.
- 2. ALL AGGREGATE AND BITUMINOUS BASE COURSES SHALL BE PRIMED. THIS WORK SHALL CONFORM TO THE APPROPRIATE ARTICLES OF SECTION 406 OF THE STANDARD SPECIFICATIONS. THE PRIME COAT FOR AGGREGATE SURFACES SHALL BE MC-30 APPLIED AT A RATE OF 0.30 GALLONS PER SQUARE YARD AND SS-1 APPLIED AT THE RATE OF 0.10 GALLONS PER SQUARE YARD FOR HMA BASES. WHEN THE PRIMED AREA IS TO BE OPEN TO TRAFFIC, A FINE AGGREGATE SHALL BE PLACED IMMEDIATELY AFTER THE PRIME COAT HAS BEEN APPLIED. THE FINE AGGREGATE SHALL CONFORM TO ARTICLES 406.06 OF THE STANDARD SPECIFICATIONS. THESE ITEMS WILL BE PAID FOR SEPARATELY AS BITUMINOUS MATERIALS (PRIME COAT) AND AGGREGATE (PRIME COAT).
- 3. GEOTECHNICAL FABRIC FOR GROUND STABILIZATION: ITEM NO. 2100100 GEOTECHNICAL FABRIC FOR GROUND STABILIZATION WILL ONLY BE UTILIZED IN AREAS THAT HAVE BEEN IDENTIFIED AS SUBGRADE UNDERCUTS AREAS OR WHERE DETERMINED IN THE FIELD BY A GEOTECHNICAL ENGINEER. THE FABRIC WILL BE USED IN COMBINATION WITH PGE SUBGRADE. THE QUANTITY INCLUDED IN THE PLANS IS BASED ON THE SUBSURFACE INVESTIGATION PREPARED BY TESTING SERVICE CORPORATION RECOMMENDATIONS FOR UNDERCUT AREAS.
- 4. ALL EXCAVATION AND EMBANKMENT LOCATIONS REQUIRING SEEDING OR SODDING SHALL BE CONSTRUCTED TO 6 INCHES BELOW FINISHED GRADE LINE TO ALLOW TOPSOIL PLACEMENT.
- 5. PAVEMENT ELEVATIONS: THE ELEVATIONS SHOWN ON THE PLANS ARE FINISHED GRADES FOR THE PROPOSED PAVEMENT OR SURFACE COURSE, UNLESS OTHERWISE INDICATED.
- 6. THE HORIZONTAL DATUM IS NAD 83 AND THE VERTICAL DATUM IS NAVD 88.

REMOVAL NOTES

- MAILBOXES: THE WORK REQUIRED FOR THE REMOVAL AND REPLACEMENT OF PERMANENT MAILBOXES IS SPECIFIED IN THE SPECIAL PROVISIONS AND DETAILED IN THE PLANS. IN ACCORDANCE WITH ARTICLE 107.20 OF THE STANDARD SPECIFICATIONS, THE WORK WILL NOT BE MEASURED SEPARATELY FOR PAYMENT BUT SHALL BE CONSIDERED INCLUDED IN THE COST OF MOBILIZATION.
- MAILBOXES SHALL BE TEMPORARILY MOVED BECAUSE OF CONSTRUCTION OPERATIONS. MAILBOXES MAY HAVE TO BE MOVED MORE THAN ONCE. THE CONTRACTOR SHALL TEMPORARILY PLACE AND SUPPORT THE MAILBOX SO THAT IT IS SUITABLE FOR MAIL DELIVERY. MAINTAINING THE MAILBOX DURING CONSTRUCTION AND PLACING IT IN ITS PERMANENT LOCATION WILL BE CONSIDERED INCLUDED IN THE COST OF MOBILIZATION. IF THE MAILBOX OR SUPPORT IS DAMAGED BY THE CONSTRUCTION OPERATIONS IT WILL BE REPLACED BY THE CONTRACTOR AT NO COST TO THE PROJECT.
 - SAW CUTS: FULL DEPTH SAW CUT IS REQUIRED FOR THE REMOVAL OF PAVEMENT, BUTT JOINTS, PATCHES, DRIVEWAYS, OR ANY OTHER STRUCTURES THAT ARE ALL ON PIECE WITH NO CONSTRUCTION JOINTS THE SAW CUT SHALL BE MADE AT THE LIMITS OF CONSTRUCTION OR OTHER AREAS AS REQUIRED TO PERFORM THE PROPOSED IMPROVEMENTS SHOWN ON THE PLANS. THE SAW CUT SHALL BE ACCOMPLISHED WITHA A "PAVEMENT SAW". VERMEER TYPE TRENCHERS WILL NOT BE ALLOWED FOR FINAL SAW CUT AT THE LIMITS OF CONSTRUCTION. THESE SAW CUTS WILL NOT BE PAID FOR SEPARATELY, BUT SHALL BE BE INCLUDED IN THE COST OF THE APPLICABLE ITEM BEING REMOVED

OWNER OF RECORD

THE ILLINOIS DEPARTMENT OF TRANSPORTATION IS NOT THE OWNER OF RECORD FOR THIS BRIDGE. THOSE SEEKING HISTORIC, AS-BUILT OR OTHER EXISTING DOCUMENTS AND PLANS MUST CONTACT THE OWNER OF RECORD TO MAKE ARRANGEMENTS FOR ACCESS TO THIS INFORMATION.

INDEX OF SHEETS

SHEET NO.	DESCRIPTION	
1	COVER SHEET	

GENERAL NOTES, INDEX OF SHEETS & STANDARDS

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MAINTENANCE OF TRAFFIC DETOUR PLAN 23-24 REMOVAL PLANS

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PLAN & PROFILE - JERICHO LAKE PARK ENTRANCE

EROSION CONTROL & SEEDING PLANS 28-29 EROSION CONTROL & SEEDING NOTES

31-32 EROSION CONTROL & SEEDING DETAILS

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LANDSCAPING PLAN

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73-86 CROSS SECTIONS - JERICHO ROAD

HIGHWAY STANDARDS

STANDARD NO. DESCRIPTION

000001-06 STANDARD SYMBOLS, ABBREVIATIONS AND PATTERNS

001001-02 AREAS OF REINFORCEMENT BARS

280001-06 TEMPORARY EROSION CONTROL SYSTEMS

420401-08 BRIDGE APPROACH PAVEMENT CONNECTOR 482001-02 HMA SHOULDER ADJACENT TO FLEXIBLE PAVEMENT

515001-03 NAME PLATE FOR BRIDGES

542101-02 REINFORCED CONCRETE END SECTIONS FOR PIPE CULVERTS 15" (375 MM)

THRU 36" (900 MM) DIA. AT RIGHT ANGLES WITH ROADWAY

542301-03 PRECAST REINFORCED CONCRETE FLARED END SECTION

601001-04 SUB-SURFACE DRAINS 601101-01 CONCRETE HEADWALL FOR PIPE DRAIN

630001-10 STEEL PLATE BEAM GUARDRAIL

630101-09 GUARDRAIL MOUNTED ON EXISTING CULVERTS

630106 LONG-SPAN GUARDRAIL OVER CULVERT

630201-06 PCC/HMA STABILIZATION AT STEEL PLATE BEAM GUARDRAIL

630301-05 SHOULDER WIDENING FOR TYPE 1 (SPECIAL) GUARDRAIL TERMINALS

631032-07 TRAFFIC BARRIER TERMIAL, TYPE 6A

635006-03 REFLECTOR AND TERMINAL MARKER PLACEMENT

635011-02 REFLECTOR MARKER AND MOUNTING DETAILS 701901-02 TRAFFIC CONTROL DEVICES

720001-01 SIGN PANEL MOUNTING DETAILS

720006-03 SIGN PANEL ERECTION DETAILS

728001-01 TELESCOPING STEEL SIGN SUPPORT

729001-01 APPLICATIONS OF TYPES A & B METAL POSTS (FOR SIGNS & MARKERS)

BLR 26-3 STEEL PLATE BEAM GUARDRAIL 29" HEIGHT

DISTRICT STANDARDS

STANDARD NO. DESCRIPTION

BD-32 BUTT JOINTS AND HMA TAPER

BD-51 BENCHING DETAIL FOR EMBANKMENT WIDENING

TC-10 TRAFFIC CONTROL AND PROTECTION FOR SIDE ROADS,

INTERSECTIONS, AND DRIVEWAYS

TC-22 ARTERIAL ROAD INFORMATION SIGN (DISTRICT 1)

DISTRICT ONE TYPICAL PAVEMENT MARKINGS TC-13

WILLS BURKE KELSEY ASSOCIATES LTD. WBK 116 West Main Street, Suite 201 St. Charles, Illinois 60174

USER NAME = nparris DESIGNED REVISED REVISED DRAWN REVISED PLOT SCALE = 1:20 CHECKED PLOT DATE = 7/9/2013 DATE REVISED

STATE OF ILLINOIS DEPARTMENT OF TRANSPORTATION

SCALE:

SECTION **GENERAL NOTES,** 04-00329-00-BR 1542 INDEX OF SHEETS & STANDARDS SHEET NO. 1 OF 1 SHEETS STA. TO STA.

CONTRACT NO. ILLINOIS FED. AID PROJECT

COUNTY

KANE

86 2

SUMMARY OF QUANTITIES

							80% FEDERAL 20% STATE		
SPECIALTY	SPECIAL	CODE			TOTAL	ROADWAY	BRIDGE	TRAINEES	NON-
	PROVISION	NO.	ITEM	UNIT	QUANTITY	0004 URBAN	0011 URBAN	0042 URBAN	PARTICIPATING 100% LOCAL
		20100110	TREE REMOVAL (6 TO 15 UNITS DIAMETER)	UNIT	597	597			
		20100210	TREE REMOVAL (OVER 15 UNITS DIAMETER)	UNIT	686	686			
		20101100	TREE TRUNK PROTECTION	EACH	17	17			
	S	20200100	EARTH EXCAVATION	CU YD	3,025	3,025			
		20201200	REMOVAL AND DISPOSAL OF UNSUITABLE MATERIAL	CU YD	835	835			
		20300100	CHANNEL EXCAVATION	CU YD	610	610			
		20800150	TRENCH BACKFILL	CU YD	12	12			
		21001000	GEOTECHNICAL FABRIC FOR GROUND STABILIZATION	SQ YD	1,670	1,670			
		21101505	TOPSOIL EXCAVATION AND PLACEMENT	CU YD	1,305	1,305			
		21101625	TOPSOIL FURNISH AND PLACE, 6"	SQ YD	3,000	3,000			
		21101665	TOPSOIL FURNISH AND PLACE, 18"	SQ YD	41	41			
*		25000100	SEEDING, CLASS 1	ACRE	0.5	0.5			
*		25000210	SEEDING, CLASS 2A	ACRE	0.75	0.75			
*			SEEDING, CLASS 4	ACRE	0.75	0.75			
*		25000312	SEEDING, CLASS 4A	ACRE	0.25	0.25			
*		25000320	SEEDING, CLASS 5	ACRE	0.5	0.5			
*		25000324	SEEDING, CLASS 5B	ACRE	0.25	0.25			
*		25000400	NITROGEN FERTILIZER NUTRIENT	POUND	177	177			
*		25000500	PHOSPHORUS FERTILIZER NUTRIENT	POUND	176	176			
*		25000600	POTASSIUM FERTILIZER NUTRIENT	POUND	176	176			
*		25100630	EROSION CONTROL BLANKET	SQ YD	9,591	9,591			
*		25200200	SUPPLEMENTAL WATERING	UNIT	100	100			
*		28000250	TEMPORARY EROSION CONTROL SEEDING	POUND	393	393			
*		28000305	TEMPORARY DITCH CHECKS	FOOT	360	360			
		28000315	AGGREGATE DITCH CHECKS	TON	3	3			
*			PERIMETER EROSION BARRIER	FOOT	2,543	2,543			
		28000500	INLET AND PIPE PROTECTION	EACH	2	2			
		28100105	STONE RIPRAP, CLASS A3	SQ YD	5	5			
*		28100107	STONE RIPRAP, CLASS A4	SQ YD	869		869		
		28200200	FILTER FABRIC	SQ YD	874	5	869		
	S	30300001	AGGREGATE SUBGRADE IMPROVEMENT	CU YD	835	835			
	S	30300112	AGGREGATE SUBGRADE IMPROVEMENT 12"	SQ YD	4,645	4,645			

WILLS BURKE KELSEY ASSOCIATES LTD.

116 West Main Street, Suite 201
St. Charles, Illinois 60174

	USER NAME = nparris	DESIGNED -	REVISED -
Э.		DRAWN -	REVISED -
	PLOT SCALE = 1:1	CHECKED -	REVISED -
	PLOT DATE = 7/9/2013	DATE -	REVISED -

STATE OF ILLINOIS						
DEPARTMENT OF TRANSPORTATION						

SUMMARY OF QUANTITIES						F.A.U. RTE.			TOTAL SHEETS	SHEET NO.	
						1542	04-00329-00-BR	KANE	86	3	
								CONTRACT	ΓΝΟ.		
	SHEET NO.1 (OF 4	SHEETS	STA.	TO STA.		ILLINOIS FED. AID PROJECT				

CONSTRUCTION CODE

	WILLS BURKE KELSEY ASSOCIATES LT
WBK	116 West Main Street, Suite 201 St. Charles, Illinois 60174
	A

SPECIALTY

ITEM

SPECIAL

PROVISION

CODE

 NO_{\bullet}

31101200 SUBBASE GRANULAR MATERIAL, TYPE B 4"

31102000 SUBBASE GRANULAR MATERIAL, TYPE C

35102200 AGGREGATE BASE COURSE, TYPE B 10"

40600200 BITUMINOUS MATERIALS (PRIME COAT)

40603080 HOT-MIX ASPHALT BINDER COURSE, IL-19.0, N50

40603310 HOT-MIX ASPHALT SURFACE COURSE, MIX "C", N50

40600300 AGGREGATE (PRIME COAT)

	USER NAME = nparris	DESIGNED -	REVISED -	
ΓD.		DRAWN -	REVISED -	
	PLOT SCALE = 1:1	CHECKED -	REVISED -	
	PLOT DATE = 7/9/2013	DATE -	REVISED -	

STATE OF ILLINOIS DEPARTMENT OF TRANSPORTATION

SCALE:

SUN	ЛMARY	OF QU	ANTITIES	
SHEET NO. 2	OF 4	SHEETS	STA.	TO STA.

CONSTRUCTION CODE

TRAINEES

0042

URBAN

NON-

PARTICIPATING

100% LOCAL

80% FEDERAL 20% STATE BRIDGE

0011

URBAN

ROADWAY

0004

URBAN

133

56

767

11

14

1,735

15

TOTAL

QUANTITY

133

56

767

11

14

1,735

15

UNIT

SQ YD

CU YD

SQ YD

TON

TON

TON

TON

SECTION COUNTY TOTAL SHEETS NO.

04-00329-00-BR KANE 86 4

CONTRACT NO.

ILLINOIS FED. AID PROJECT

40603335 HOTEMIX ASPHALT SURFACE COURSE, MIX "D", N50	TON 555	555	
42001430 BRIDGE APPROACH PAVEMENT CONNECTOR (FLEXIBLE)	SQ YD 122	122	
44000100 PAVEMENT REMOVAL	SQ YD 2,876	2,876	
44000200 DRIVEWAY PAVEMENT REMOVAL	SQ YD 788	788	
48101500 AGGREGATE SHOULDERS, TYPE B 6"	SQ YD 10	10	
48203013 HOT-MIX ASPHALT SHOULDERS, 4"	SQ YD 15	15	
48203021 HOTEMIX ASPHALT SHOULDERS, 6"	SQ YD 852	852	
50100100 REMOVAL OF EXISTING STRUCTURES	EACH 1	1	
50105220 PIPE CULVERT REMOVAL	FOOT 99	99	
50200100 STRUCTURE EXCAVATION	CU YD 186	186	
50200300 COFFERDAM EXCAVATION	CU YD 163	163	
50201121 COFFERDAM (TYPE 2) (LOCATION - 1)	EACH 1	1	
50300225 CONCRETE STRUCTURES	CU YD 187.3	187.3	
50300255 CONCRETE SUPERSTRUCTURE	CU YD 175.8	175.8	
50300260 BRIDGE DECK GROOVING	SQ YD 993.7	993.7	
50300265 SEAL COAT CONCRETE	CU YD 95	95	
50300280 CONCRETE ENCASEMENT	CU YD 8.4	8.4	
50300300 PROTECTIVE COAT	SQ YD 1,792.9	1,792.9	
50400505 PRECAST PRESTRESSED CONCRETE DECK BEAMS (27" DEPTH)	SQ FT 6,277	6,277	
50800205 REINFORCEMENT BARS, EPOXY COATED	POUND 72,480	72,480	
51201600 FURNISHING STEEL PILES HP12X53	FOOT 996	996	
51202305 DRIVING PILES	F00T 996	996	
51203600 TEST PILE STEEL HP12X53	EACH 2	2	
51204650 PILE SHOES	EACH 36	36	
51500100 NAME PLATES	EACH 1	1	

ITEM

J		WILLS BURKE KELSEY ASSOCIATES L	.TC
	WBK	116 West Main Street, Suite 201 St. Charles, Illinois 60174	
J J			

STATE OF ILLINOIS ARTMENT OF TRANSPORTATION

	3				
	SHEET NO. 3	OF 4	SHEETS	STA	TO STA

CONSTRUCTION CODE

80% FEDERAL 20% STATE BRIDGE

ILLINOIS FED. AID PROJECT

		A2006726	TREE,	QUERCUS	MACROCARPA	(BUR	OAK),	3′′	CALIPER,	BALLED	А
			_								
	USER NAME = nparris		DESIGNE	D -	REVISE	D -					
LTD.			DRAWN	-	REVISE	D -					
	PLOT SCALE = 1:1		CHECKED	_	REVISE	D -				DEP#	۱R
	PLOT DATE = 7/9/2013		DATE	-	REVISE	D -					

			SUN	ИMARY	OF QU	ANTITIES	
	SCALE:	SHEET	NO. 3	OF 4	SHEETS	STA.	TC

SECTION	COUNTY	TOTAL SHEETS	SHEE
04-00329-00-BR	KANE	86	5
	CONTRACT	NO.	

					ROADWAY	BRIDGE	TRAINEES	NON-
SPECIALTY		CODE	UNIT	TOTAL	0004	0011	0042	PARTICIPATING
ITEM	PROVISION	NO.		QUANTITY	URBAN	URBAN	URBAN	100% LOCAL
		54213663 PRECAST REINFORCED CONCRETE FLARED END SECTIONS 18"	EACH	1	1			
		FECACORO STORM SEWERS CLASS A TYPE 1 1977	FOOT	67	67			
		550A0090 STORM SEWERS, CLASS A, TYPE 1 18"	FUUT	61	61			
*	S	56100600 WATER MAIN 6"	FOOT	10				10
		FC100000 WATED MAIN 10//	F007	10.4				10.4
*	S	56100900 WATER MAIN 12"	FOOT	184				184
*	S	56101000 WATER MAIN 16"	FOOT	729				729
		ECACCECC FIRE INVERTALITY TO BE DELICATED	5 4 0 1 1	7				_
*	S	56400500 FIRE HYDRANTS TO BE REMOVED	EACH	3				3
*	S	56400820 FIRE HYDRANT WITH AUXILIARY VALVE AND VALVE BOX	EACH	3				3
						70.4		
		59100100 GEOCOMPOSITE WALL DRAIN	SQ YD	78.4		78.4		
		60107600 PIPE UNDERDRAINS 4"	FOOT	100	100			
			5 4 0 1 1		4			
*		60200805 CATCH BASINS, TYPE A, 4'-DIAMETER, TYPE 8 GRATE	EACH	1	1			
*		60248900 VALVE VAULTS, TYPE A, 5'-DIAMETER, TYPE 1 FRAME, CLOSED LID	EACH	3				3
		COCOOCOE COMODETE OUDD TYPE D	5007	405	405			
		60600605 CONCRETE CURB, TYPE B	FOOT	105	105			
*		63000001 STEEL PLATE BEAM GUARDRAIL, TYPE A, 6 FOOT POSTS	FOOT	175	175			
*		63100085 TRAFFIC BARRIER TERMINAL, TYPE 6	EACH	4	4			
*		63100167 TRAFFIC BARRIER TERMINAL, TYPE 1 (SPECIAL) TANGENT	EACH	3	3			
		63200310 GUARDRAIL REMOVAL	FOOT	208	208			
		67100100 MOBILIZATION	L SUM	1	1			
		70106800 CHANGEABLE MESSAGE SIGN	CAL MO	10	10			
		72400100 REMOVE SIGN PANEL ASSEMBLY - TYPE A	EACH	19	19			
*	S	78009000 MODIFIED URETHANE PAVEMENT MARKING 1/64 F1/64 LETTERS AND SYMBOLS	SQ FT	73	73			
*	S	78009004 MODIFIED URETHANE PAVEMENT MARKING - LINE 4"	FOOT	4,620	4,620			
*	S	78009008 MODIFIED URETHANE PAVEMENT MARKING 1/64 F1/64 LINE 8"	FOOT	309	309			
*	S	78009012 MODIFIED URETHANE PAVEMENT MARKING - LINE 12"	FOOT	61	61			
*	S	78009024 MODIFIED URETHANE PAVEMENT MARKING - LINE 24"	FOOT	36.8	36.8			
*	S	78200410 GUARDRAIL MARKERS, TYPE A	EACH	6	6			
	-			-	-			
*		78200530 BARRIER WALL MARKERS, TYPE C	EACH	4	4			
*		78201000 TERMINAL MARKER - DIRECT APPLIED	EACH	4	4			
*		A2001724 TREE, ACER SACCHARUM (SUGAR MAPLE), 3" CALIPER, BALLED AND BURLAPPED	EACH	2	2			
*		A2005030 TREE, GYMNOCLADUS DIOICUS (KENTUCKY COFFEETREE), 4" CALIPER, BALLED AND BURLAPPED	EACH	2	2			
*		A2005670 TREE, OSTRYA VIRGINIANA (AMERICAN HOPHORNBEAM), 8' HEIGHT, CLUMP FORM, BALLED AND BURLAPPED	EACH	2	2			
*		A2006420 TREE, QUERCUS ALBA (WHITE OAK), 2-1/2" CALIPER, BALLED AND BURLAPPED	EACH	2	2			
*		A2006726 TREE, QUERCUS MACROCARPA (BUR OAK), 3" CALIPER, BALLED AND BURLAPPED	EACH	2	2			

J		WILLS BURKE KELSEY ASSOCIATES L	TC
	WBK	116 West Main Street, Suite 201 St. Charles, Illinois 60174	
J J			

USER NAME = nparris	DESIGNED -	REVISED -
	DRAWN -	REVISED -
PLOT SCALE = 1:1	CHECKED -	REVISED -
PLOT DATE = 7/9/2013	DATE -	REVISED -


	20IN	IVIA	KY	UF L	JUA	VIAIIIIE2			
SHEET NO	0.4	OF 4	4	SHEET	٠ς	STA	ΤO	STA	


CONSTRUCTION CODE

CONTRACT NO. ILLINOIS FED. AID PROJECT

-	OTATE OF HILINOID		SUMMARY OF QUANTITIES		F.A.U. RTE.	SECTION	COI
-	STATE OF ILLINOIS				1542	04-00329-00-BR	Κ.
=	DEPARTMENT OF TRANSPORTATION						CON
-		SCALE:	SHEET NO. 4 OF 4 SHEETS STA.	TO STA.		ILLINOIS FED.	. AİD PROJ

							80% FEDERAL		
					TOTAL	ROADWAY	20% STATE BRIDGE	TRAINEES	NON-
SPECIALTY ITEM	SPECIAL PROVISION		ITEM		TOTAL QUANTITY	0004 Urban	0011 URBAN	0042 URBAN	PARTICIPATING 100% LOCAL
*		B2000668	TREE, AMELANCHIER X GRANDIFLORA (APPLE SERVICEBERRY), 7' HEIGHT, SHRUB FORM, BALLED AND BURLAPPED	EACH	2	2			
*		B2004170	TREE, MALUS PRAIRIFIRE (PRAIRIFIRE CRABAPPLE), 8' HEIGHT, CLUMP FORM, BALLED AND BURLAPPED	EACH	1	1			
	S	X0300249	REMOVE EXISTING GATE	EACH	2	2			
	S	X0323697	RUSTIC RAIL FENCE REMOVAL	FOOT	342	342			
	S	X0325003	REMOVE EXISTING VALVE AND VAULT	EACH	2				2
	S	X0326806	WASHOUT BASIN	L SUM	1	1			
	S	X0327301	RELOCATE EXISTING MAILBOX	EACH	2	2			
*	S	X0640200	TRAFFIC BARRIER TERMINAL (SPECIAL)	EACH	1	1			
	S	X2090215	SELECT GRANULAR BACKFILL, SPECIAL	CU YD	80				80
	S	X2130010	EXPLORATION TRENCH, SPECIAL	FOOT	100	100			
	S	X5030305	CONCRETE WEARING SURFACE, 5"	SQ YD	698		698		
*	S	X5610662	WATER MAIN TO BE ABANDONED, 12"	FOOT	751				751
*	S	X5610666	WATER MAIN TO BE ABANDONED, 16''	FOOT	712				712
	S	X5620030	WATER SERVICE CONNECTION 1"	EACH	1				1
*	S	X5630712	CONNECTION TO EXISTING WATER MAIN 12"	EACH	2				2
*	S		CONNECTION TO EXISTING WATER MAIN 16"	EACH	5				5
	S		GRANULAR BACKFILL FOR STRUCTURES	CU YD	95		95		
*	S		TRAFFIC CONTROL AND PROTECTION, (SPECIAL)	L SUM	1	1			
*	S		GATE VALVES, 12"	EACH	1	-			1
	S		CONCRETE PAD REMOVAL	SQ FT	62	62			-
*	S		TURBIDITY BARRIER	FOOT	269	269			
<u>"</u>	S		SIGN REMOVAL, SPECIAL	L SUM	1	1			
*	5		GATE VALVES, 16"	EACH	1	1			1
	5				1	1			1
*	S		CONSTRUCTION LAYOUT	L SUM	170	170			
	S		FENCE REMOVAL (SPECIAL)	FOOT	139	139			
*	S		TEMPORARY INFORMATION SIGNING	SQ FT	21.25	21.25			
*	S		POLYETHYLENE ENCASEMENT	FOOT	1,332				1,332
	S		PRESSURE CONNECTION 16" X 16"	EACH	1				1
	S		PIPE UNDERDRAINS FOR STRUCTURES 4"	FOOT	178		178		
*	S	Z0055900	RUSTIC WOOD POST AND RAIL FENCE	FOOT	537	537			
	S	Z0055905	TEMPORARY CONSTRUCTION FENCE	FOOT	689	689			
	S	Z0076600	TRAINEES	HOUR	500			500	
*	S		SEEDING, CLASS 4 MODIFIED (SHADED STREAMBANK)	ACRE	0.25	0.25			

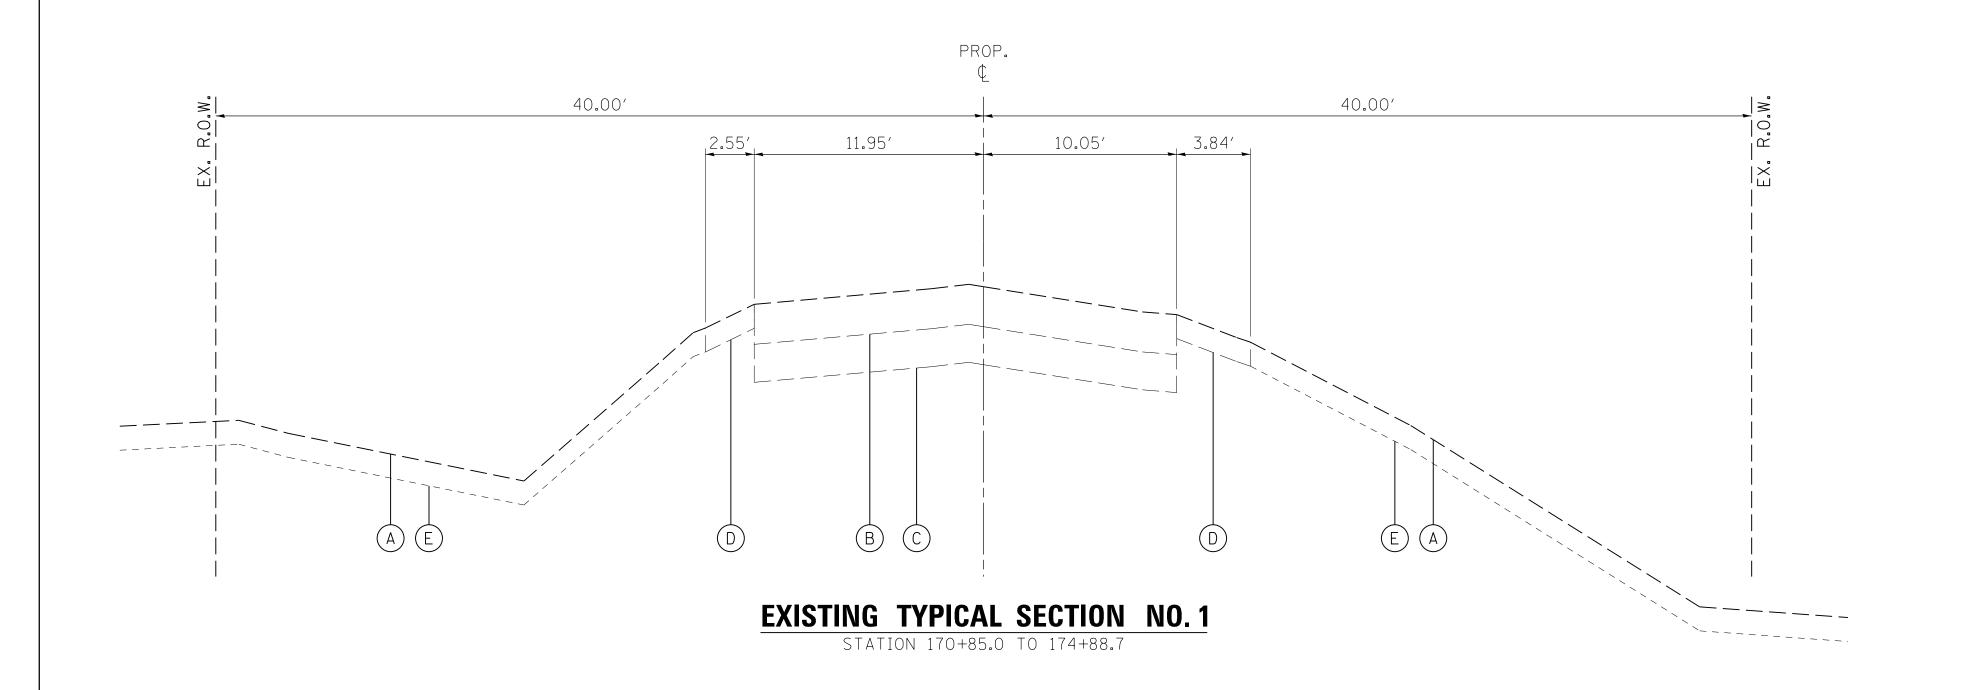

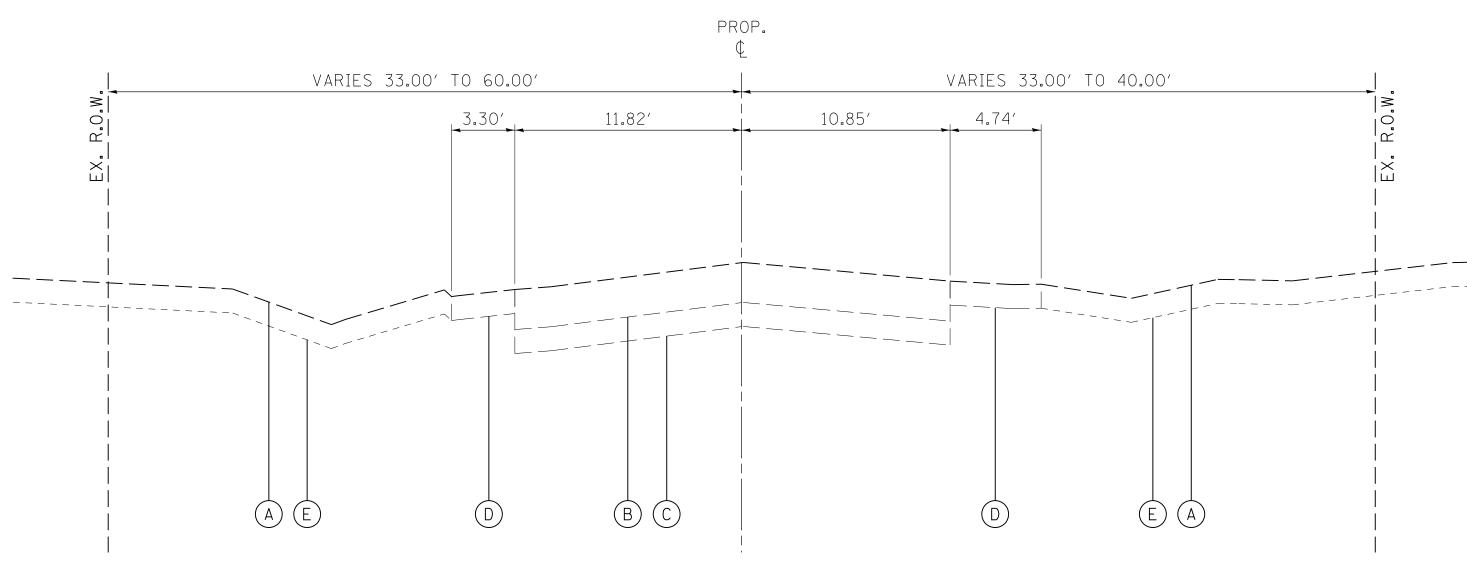

EXISTING TYPICAL SECTION NO. 2

STATION 175+81.4 TO 180+00.0

LEGEND, EXISTING

- (A) EXISTING GROUND
- B EXISTING HOT-MIX ASPHALT PAVEMENT, 8.9" 10.4" TO BE REMOVED (44000100)
- C EXISTING AGGREGATE BASE TO BE REMOVED (INCLUDED IN EARTH EX.)

 CORE #2 9.5" GRAVEL WITH SAND

 CORE #3 6.0" GRAVEL WITH SAND
- (D) EXISTING AGGREGATE SHOULDER TO BE REMOVED (INCLUDED IN EARTH EX.)
- (E) EXISTING TOPSOIL TO BE REMOVED (20201200)

EXISTING PAVEMENT NOTES

- 1. INFORMATION ON PAVEMENT AND BASE COURSE THICKNESS WAS TAKEN FROM INFORMATION DOCUMENTED IN THE "GEOTECHNICAL SOIL INVESTIGATION" PREPARED BY TESTING SERVICE CORPORATION DATED DECEMBER 4, 2008. SEE ADDITIONAL NOTE BELOW.
- 2. IT SHALL BE THE RESPONSIBILITY OF THE CONTRACTOR TO VERIFY THE THICKNESS OF THE EXISTING PAVEMENTS TO BE REMOVED AND THE EXTENT TO WHICH IT WAS REINFORCED. NO ADDITIONAL COMPENSATION WILL BE ALLOWED BECAUSE OF VARIATIONS FROM THE ASSUMED THICKNESS SHOWN ON THE PLANS OR FOR VARIATIONS IN THE AMOUNT OF REINFORCEMENT.

STRUCTURAL PAVEMENT DESIGN

HOT-MIX ASPHALT MIXTURE REQUIREMENTS

ITEM	AIR VOIDS @ Ndes
JERICHO ROAD - RECONSTRUCTION	
HOT-MIX ASPHALT SURFACE COURSE, MIX "D", N50 (IL 9.5 mm); 2"	4% @ 50 GYR.
HOT-MIX ASPHALT BASE COURSE (HMA BINDER IL-19 mm), 8" (2 LIFTS)	4% @ 50 GYR.
JERICHO PARK ENTRANCE ROAD- RECONSTRUCTION	
HOT-MIX ASPHALT SURFACE COURSE, MIX "D", N50 (IL 9.5 mm); 1.5"	4% @ 50 GYR.
HOT-MIX ASPHALT BASE COURSE (HMA BINDER IL-19 mm), 2.5"	4% @ 50 GYR.
JERICHO ROAD - APPROACH PAVEMENT CONNECTOR (FLEXIBLE)	
HOT-MIX ASPHALT BINDER COURSE, IL-19, N50	4% @ 50 GYR.
HMA SHOULDERS	
HOT-MIX ASPHALT SHOULDER (HMA BINDER IL-19 mm), 6" (4" MAX. LIFTS)	4% @ 50 GYR.
HOT-MIX ASPHALT SHOULDER (HMA BINDER IL-19 mm), 4" (4" MAX. LIFTS)	4% @ 50 GYR.
DRIVEWAYS- P.E.	
HOT-MIX ASPHALT SURFACE COURSE, MIX "C", N50 (IL 9.5 mm); 2"	4% @ 50 GYR.
HOT-MIX ASPHALT BASE COURSE (HMA BINDER IL-19 mm), 6" (2 LIFTS)	4% @ 50 GYR.

THE UNIT WEIGHT USED TO CALCULATE ALL HMA SURFACE MIXTURE QUANTITIES IS 112 LB/SQ YD/IN.

THE AC TYPE FOR NON-POLYMERIZED HMA THE "AC TYPE" SHALL BE "PG64-22" UNLESS MODIFIED BY DISTRICT ONE SPECIAL PROVISIONS.


WILLS BURKE KELSEY ASSOCIATES LTD.

116 West Main Street, Suite 201
St. Charles, Illinois 60174

	USER NAME = nparris	DESIGNED -	REVISED -	
TD.		DRAWN -	REVISED -	
	PLOT SCALE = 1:5	CHECKED -	REVISED -	
	PLOT DATE = 7/9/2013	DATE -	REVISED -	

STATE OF ILLINOIS
DEPARTMENT OF TRANSPORTATION

	TYPICAL SECTIONS	F.A.L RTE.	.U.	SECTION	COUNTY	TOT SHE
		1542	12	04-00329-00-BR	KANE	80
			'		CONTRACT	NO.
5	SCALE:N/A SHEET NO.1 OF 3 SHEETS STA. TO S	A		ILLINOIS FED. A	ID PROJECT	

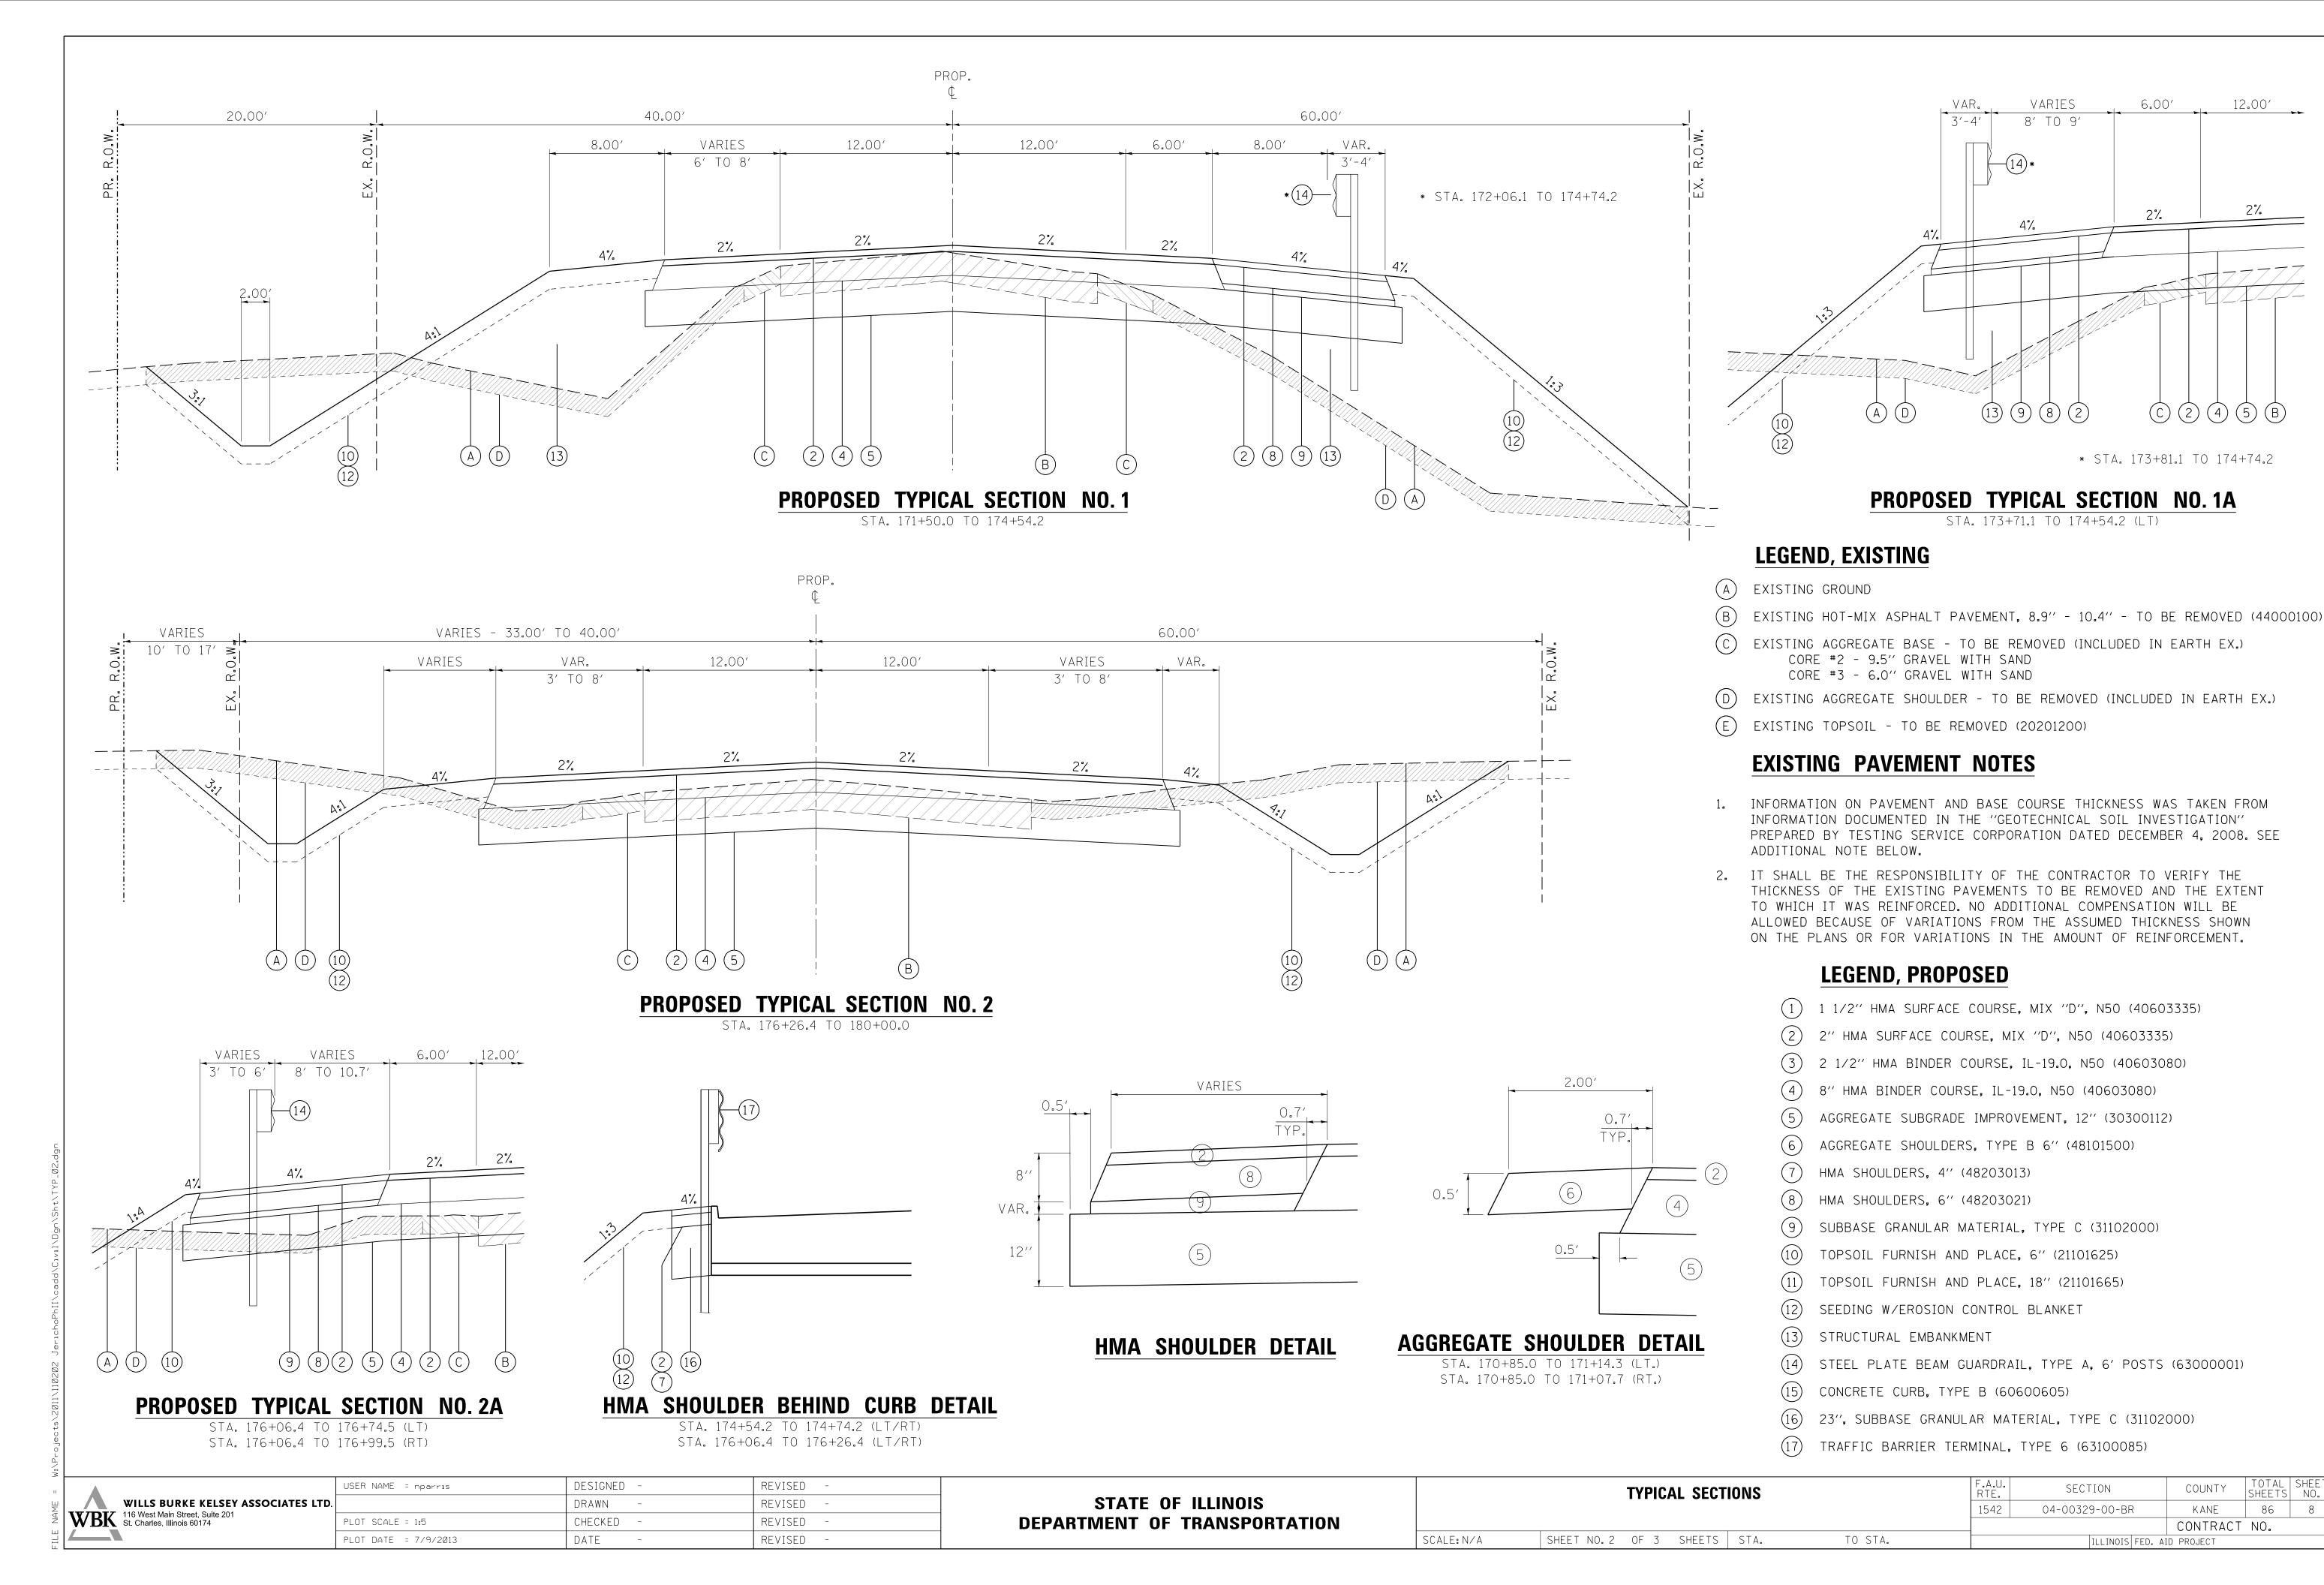

2%

(C)(2)(4)(5)(B)

* STA. 173+81.1 TO 174+74.2

STA. 173+71.1 TO 174+54.2 (LT)

SECTION

04-00329-00-BR


KANE


ILLINOIS FED. AID PROJECT

CONTRACT NO.

86 8

2%

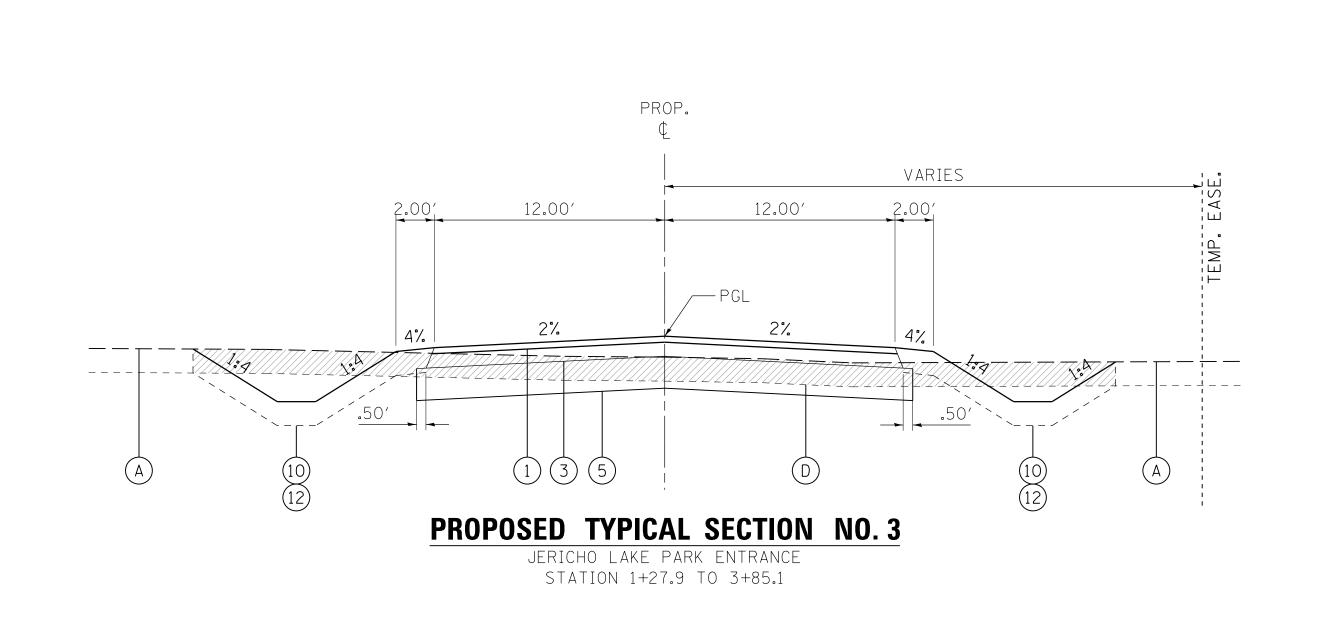

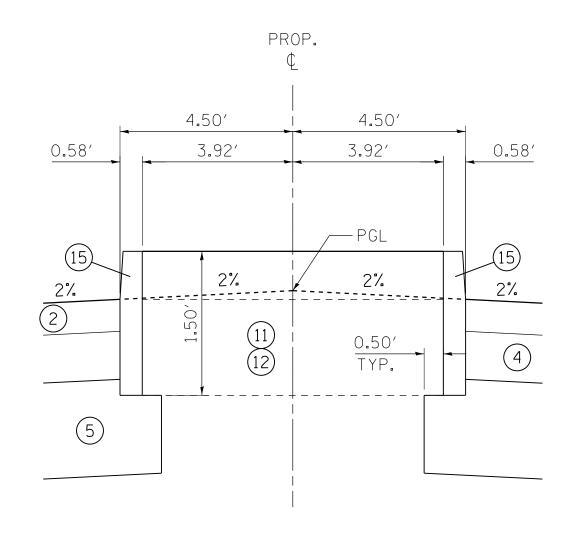


PROPOSED TYPICAL SECTION NO.4A

JERICHO LAKE PARK ENTRANCE - BARRIER CURB MEDIAN

STA. 4+11.6 TO 4+60.0

SCALE: N/A

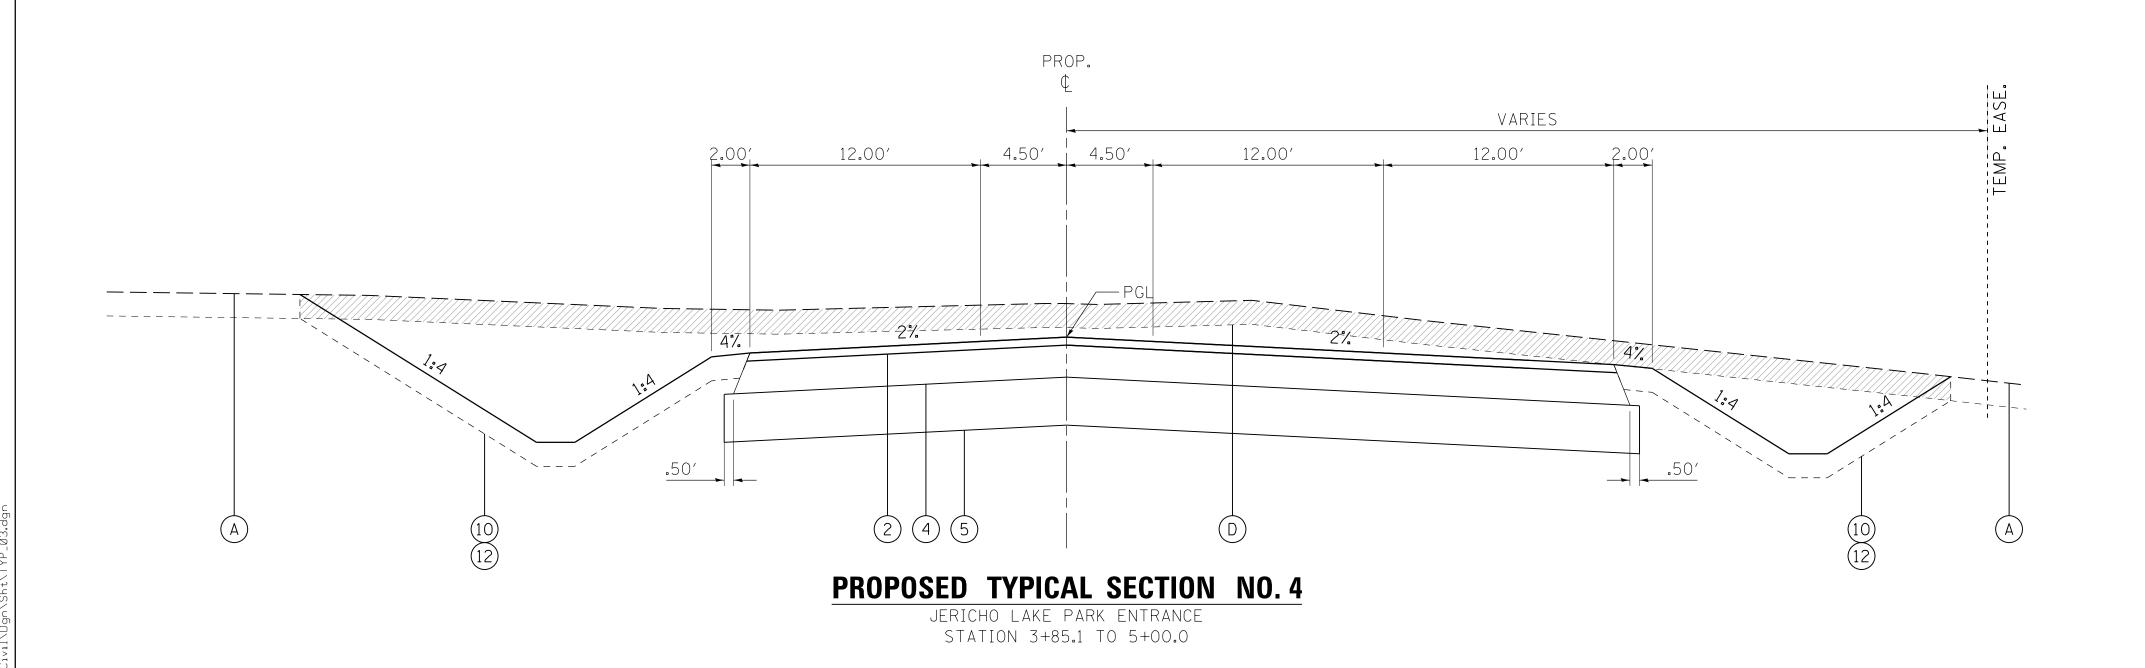

LEGEND, EXISTING

- (A) EXISTING GROUND
- (B) EXISTING HOT-MIX ASPHALT PAVEMENT, 8.9" 10.4" TO BE REMOVED (44000100)
- (C) EXISTING AGGREGATE BASE TO BE REMOVED (INCLUDED IN EARTH EX.)

 CORE #2 9.5" GRAVEL WITH SAND

 CORE #3 6.0" GRAVEL WITH SAND
- D) EXISTING AGGREGATE SHOULDER TO BE REMOVED (INCLUDED IN EARTH EX.)
- (E) EXISTING TOPSOIL TO BE REMOVED (20201200)

EXISTING PAVEMENT NOTES

- 1. INFORMATION ON PAVEMENT AND BASE COURSE THICKNESS WAS TAKEN FROM INFORMATION DOCUMENTED IN THE "GEOTECHNICAL SOIL INVESTIGATION" PREPARED BY TESTING SERVICE CORPORATION DATED DECEMBER 4, 2008. SEE ADDITIONAL NOTE BELOW.
- 2. IT SHALL BE THE RESPONSIBILITY OF THE CONTRACTOR TO VERIFY THE THICKNESS OF THE EXISTING PAVEMENTS TO BE REMOVED AND THE EXTENT TO WHICH IT WAS REINFORCED. NO ADDITIONAL COMPENSATION WILL BE ALLOWED BECAUSE OF VARIATIONS FROM THE ASSUMED THICKNESS SHOWN ON THE PLANS OR FOR VARIATIONS IN THE AMOUNT OF REINFORCEMENT.

LEGEND, PROPOSED

- (1) 1 1/2" HMA SURFACE COURSE, MIX "D", N50 (40603335)
- 2'' HMA SURFACE COURSE, MIX ''D'', N50 (40603335)
- (3) 2 1/2" HMA BINDER COURSE, IL-19.0, N50 (40603080)
- (4) 8" HMA BINDER COURSE, IL-19.0, N50 (40603080)
- (5) AGGREGATE SUBGRADE IMPROVEMENT, 12" (30300112)
- (6) AGGREGATE SHOULDERS, TYPE B 6" (48101500)
-) HMA SHOULDERS, 4" (48203013)
- (8) HMA SHOULDERS, 6" (48203021)
- 9) SUBBASE GRANULAR MATERIAL, TYPE C (31102000)
- (10) TOPSOIL FURNISH AND PLACE, 6" (21101625)
- (11) TOPSOIL FURNISH AND PLACE, 18" (21101665)
- (12) SEEDING W/EROSION CONTROL BLANKET
- (13) STRUCTURAL EMBANKMENT
- (14) STEEL PLATE BEAM GUARDRAIL, TYPE A, 6' POSTS (63000001)
- (15) CONCRETE CURB, TYPE B (60600605)
- (16) 23", SUBBASE GRANULAR MATERIAL, TYPE C (31102000)
- (17) TRAFFIC BARRIER TERMINAL, TYPE 6 (63100085)

	WILLS BURKE KELSEY ASSOCIATES LTD.	
WBK	116 West Main Street, Suite 201 St. Charles, Illinois 60174	

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PLOT SCALE = 1:5	CHECKED -	REVISED -
PLOT DATE = 7/9/2013	DATE -	REVISED -

STATE	OF	ILLINOIS
DEPARTMENT O)F	TRANSPORTATION

			TYP	IC/	AL SECT	IONS	
CHEET 1	VIO.	マ	ΛF	マ	СПЕЕТС	CΤΛ	TO STA

SCHEDULE OF QUANTITIES

20100110 TREE REMOVAL (6 TO 15 UNITS DIAMETER)

UNIT	LOCATION	<u>O/S (LT)</u>	<u>O/S (RT)</u>	COMMENTS
8.0	171+68.0	58.1		
15.0	171+94.2	56.9		
12.0	172+18.0	33.2	46.7	
12.0	172+20.0		49.3	MS (18"/12")
15.0	172+34.9		58.3	
8.0	172+43.6		58.0	
13.0	172+45.1		53.2	
9.0	172+46.8		58.3	MS (18"/9")
12.0	172+51.0		46.6	
19.0	172+56.7		54.9	MS (11"/8")
8.0	172+67.8		53.8	
8.0	172+75.1		54.0	
12.0	172+93.4		50.5	
8.0	172+99.3		50.8	
8.0	173+03.7		52.3	
10.0	173+09.6		59.1	
10.0	173+11.1		56.1	
8.0	173+15.4		50.2	
10.0	173+15.7		57.0	
8.0	173+19.0		52.3	
8.0	173+24.4		55.0	
12.0	173+27.9		49.1	
8.0	173+33.7		45.5	
10.0	173+38.2		53.2	
8.0	173+54.5		48.0	
8.0	173+58.7		49.1	
12.0	173+62.3		43.4	
16.0	174+02.4	46.7		MS (8"/8")
7.0	174+12.3	49.9		
11.0	174+29.7		53.6	
25.0	174+38.9		45.3	MS (14"/9")
7.0	174+44.0		44.1	
8.0	174+50.5		49.4	
18.0	174+59.4		48.6	MS (9"/9")
33.0	174+76.5	58.8		MS (12"/11"/10
12.0	174+95.7	61.7		
8.0	175+02.3	58.0		
12.0	175+02.7	63.0		

20100110 TREE REMOVAL (6 TO 15 UNITS DIAMETER)

EAST OF BE	RIDGE			
<u>UNIT</u>	LOCATION	O/S (LT)	<u>O/S (RT)</u>	COMMENTS
6.0	176+92.3		58.0	
7.0	177+31.4		114.3	
7.0	177+32.7		115.8	
14.0	177+35.7		109.2	MS (7"/7")
13.0	177+38.1		121.7	
9.0	177+41.6		82.3	
7.0	177+47.1		60.1	
7.0	177+47.9		70.3	
7.0	177+49.8		53.1	
7.0	177+50.8		92.5	
14.0	177+62.8		30.7	MS (8"/6")
13.0	177+94.9		45.8	
11.0	178+64.9		43.6	
24.0	178+75.3	42.7		MS (12"/12"
15.0	179+40.1		54.7	MS (17"/15"
161.0	SUB TOTAL			
436.0	WEST OF BRIDG	3E		
161.0	EAST OF BRIDG	E		
597	 TOTAL			

TREE REMOVAL (OVER 15 UNITS DIAMETER)

SCALE:

<u>UNIT</u>	LOCATION	O/S (LT)	<u>O/S (RT)</u>	COMMENTS
22.0	171+07.96	48.6		
20.0	171+51.66	55.1		
18.0	171+80.75	55.0		
18.0	172+20.0		49.3	MS (18"/12")
25.0	172+30.3		57.4	100000000000000000000000000000000000000
22.0	172+38.5		57.4	
18.0	172+46.8		58.3	MS (18"/9")
18.0	173+55.3		51.4	
19.0	174+17.4	58.0		
17.0	174+19.7		42	
24.0	174+81.9		46.0	
221.0	— SUB TOTAL			

WILLS BURKE KELSEY ASSOCIATES LTD.

116 West Main Street, Suite 201
St. Charles, Illinois 60174

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).		DRAWN -	REVISED -
	PLOT SCALE = 1:1	CHECKED -	REVISED -
	PLOT DATE = 7/9/2013	DATE -	REVISED -

SUB TOTAL

SCHEDULE OF QUANTITIES								
							1542	
SHEET NO.	1	OF	10	SHEETS	STA.	TO STA.		

SCHEDULE OF QUANTITIES

	TREE REMIC	DVAL (OVER 15 UI	NITS DIAMET	TER)		20800150	TRENCH BA	CKFILL					
	EAST OF BI	RIDGE					VOLUME		PIPE DIA.	LENGTH	WIDTH	DEPTH	COEFFICENT
	UNIT	LOCATION	O/S (LT)	O/S (RT)	COMMENTS		(CU YD)	LOCATION	(INCH)	<u>(FT)</u>	(FT)	<u>(FT)</u>	CU YD/LF
	18.0	175+15.0		114.8			12	177+50.00	24	50.0	4.0	3.2	0.235
	16.0	176+38.8		52.2									
	23.0	176+49.4	35.3				12	TOTAL					
	19.0	176+83.1		128.8									
	19.0	177+15.0		114.8									
	19.0	177+28.0		131.2		54213663	PRECAST R	EINFORCED CO	NCRETE FLAR	ED END SECT	IONS 18"		
	17.0	177+29.6		144.7									
	19.0	177+32.2		131.3			EACH	LOCATION	O/S (LT)	O/S (RT)	COMMENTS		
	16.0	177+35.6		102.6			1	177+50.0		36.0	GRATING INCL	UDED IN CO	OST OF CONCRETE F.E
	19.0	177+36.6		106.6									
	19.0	177+49.2		91.5			1	TOTAL					
	16.0	177+50.8		75.7									
	16.0	177+57.2		58.0									
	17.0	177+65.1		45.5		550A0090	STORM SEV	VERS, CLASS A,	TYPE 1 18"				
	21.0	177+75.2		47.7									
	19.0	178+22.4		44.1			FOOT	LOCATION	O/S (LT)	O/S (RT)	COMMENTS		
	21.0	178+49.8		109.1			67	177+50.0	31.0	36.0			
	25.0	178+50.0		125.3				_					
	25.0	179+16.0		47.8			67	TOTAL					
	20.0	179+32.5		104.6									
	17.0	179+40.1		54.7	MS (17"/15")								
	21.0	179+51.1		37.8		60200805	CATCH BAS	INS, TYPE A, 4'-	DIAMETER, TY	PE 8 GRATE			
	25.0	179+64.6	34.4										
	18.0	179+69.0	34.5				TOTAL	LOCATION	OFFOFT				
	405.0						<u>(EACH)</u> 1	177+50.00	OFFSET 33.0' LT				
	465.0	SUB TOTAL											
	221.0	WEST OF BRID					1	TOTAL					
	465.0	EAST OF BRID	GE			72400100	REMOVE SI	GN PANEL ASSE	MBLY - TYPE	A			
	686	TOTAL					EACH	LOCATION	O(S (I T)	O/S (DT)	COMMENTS		
							EACH 1	174+26.2	O/S (LT) 23.2	<u>O/S (RT)</u>	COMMENTS INTERSECTION	I WADING I	RARNES PD
20101100	TREE TRUN	K PROTECTION					1	174+26.2	23.5		TYPE 3 OBJEC		
							1	174+87.7	23.5		TYPE 3 OBJEC		
	EACH	LOCATION	O/S (LT)	O/S (RT)	COMMENTS		1	174+37.7	20.0	28.8	BRIDGE WEIG		
							1			24.4	TYPE 3 OBJEC		
							-	1/4 + 3/11		47.7	111 E 3 ODSE(
	1	169+53.1	51.0				1	174+37.0 174+87.2			TYPE 3 OR IEC	T MARKED	
	1 1	169+53.1 169+63.3	51.0 52.2				1	174+87.2	23.5	23.0	TYPE 3 OBJEC		
	1 1 1		52.2 59.3				1 1 1	174+87.2 175+83.7	23.5 23.8		TYPE 3 OBJEC	CT MARKER	
	1 1 1 1	169+63.3	52.2 59.3 52.7				1 1 1 1	174+87.2 175+83.7 176+31.8	23.8		TYPE 3 OBJECTYPE 3 OBJECTYPE 3 OBJECT	CT MARKER CT MARKER	
	1 1 1 1	169+63.3 169+64.0	52.2 59.3 52.7 50.2				1 1 1 1 1	174+87.2 175+83.7 176+31.8 176+34.2	23.8 26.9		TYPE 3 OBJECTYPE 3 OBJECTYPE 3 OBJECT	CT MARKER CT MARKER HT LIMIT	
	1 1 1 1 1	169+63.3 169+64.0 169+96.9	52.2 59.3 52.7 50.2 60.7				1 1 1 1 2 1	174+87.2 175+83.7 176+31.8 176+34.2 177+12.3	23.8 26.9 22.9		TYPE 3 OBJECTYPE 3 OBJECTIVE 3	OT MARKER OT MARKER HT LIMIT SIGN (2)	
	1 1 1 1 1 1	169+63.3 169+64.0 169+96.9 170+05.0	52.2 59.3 52.7 50.2 60.7 57.4				1 1 1 1 2 1	174+87.2 175+83.7 176+31.8 176+34.2 177+12.3 177+84.1	23.8 26.9 22.9 26.0		TYPE 3 OBJECTIVE 3	CT MARKER CT MARKER HT LIMIT SIGN (2) SIGN	
	1 1 1 1 1 1	169+63.3 169+64.0 169+96.9 170+05.0 170+29.3	52.2 59.3 52.7 50.2 60.7 57.4 54.3				1 1 1 1 2 1 1	174+87.2 175+83.7 176+31.8 176+34.2 177+12.3 177+84.1 178+73.7	23.8 26.9 22.9	23.0	TYPE 3 OBJECTIVE 3	CT MARKER CT MARKER HT LIMIT SIGN (2) SIGN ZONE	
	1 1 1 1 1 1 1	169+63.3 169+64.0 169+96.9 170+05.0 170+29.3 170+37.4	52.2 59.3 52.7 50.2 60.7 57.4 54.3 66.3				1 1 1 1 2 1 1 1	174+87.2 175+83.7 176+31.8 176+34.2 177+12.3 177+84.1 178+73.7 175+83.5	23.8 26.9 22.9 26.0	23.6	TYPE 3 OBJECT TYPE 3 OBJECT BRIDGE WEIGHT FIRE DISTRICT NO PASSING 2 TYPE 3 OBJECT	CT MARKER CT MARKER HT LIMIT SIGN (2) SIGN ZONE CT MARKER	
	1 1 1 1 1 1 1 1	169+63.3 169+64.0 169+96.9 170+05.0 170+29.3 170+37.4 170+58.5	52.2 59.3 52.7 50.2 60.7 57.4 54.3				1 1 1 1 2 1 1 1	174+87.2 175+83.7 176+31.8 176+34.2 177+12.3 177+84.1 178+73.7 175+83.5 176+32.9	23.8 26.9 22.9 26.0	23.0 23.6 24.5	TYPE 3 OBJECT TYPE 3 OBJECT BRIDGE WEIGHT FIRE DISTRICT NO PASSING 2 TYPE 3 OBJECT TYP	CT MARKER CT MARKER HT LIMIT SIGN (2) SIGN ZONE CT MARKER CT MARKER	
	1 1 1 1 1 1 1 1	169+63.3 169+64.0 169+96.9 170+05.0 170+29.3 170+37.4 170+58.5 172+58.9	52.2 59.3 52.7 50.2 60.7 57.4 54.3 66.3 67.7	59.7			1 1 1 1 2 1 1 1 1	174+87.2 175+83.7 176+31.8 176+34.2 177+12.3 177+84.1 178+73.7 175+83.5 176+32.9 176+96.1	23.8 26.9 22.9 26.0	23.0 23.6 24.5 30.6	TYPE 3 OBJECT TYPE 3 OBJECT BRIDGE WEIGHT FIRE DISTRICT NO PASSING 2 TYPE 3 OBJECT TYPE 3 OBJECT FIRE DISTRICT	CT MARKER CT MARKER HT LIMIT SIGN (2) SIGN ZONE CT MARKER CT MARKER	
	1 1 1 1 1 1 1 1 1	169+63.3 169+64.0 169+96.9 170+05.0 170+29.3 170+37.4 170+58.5 172+58.9 172+69.4	52.2 59.3 52.7 50.2 60.7 57.4 54.3 66.3 67.7	59.7			1 1 1 1 2 1 1 1 1	174+87.2 175+83.7 176+31.8 176+34.2 177+12.3 177+84.1 178+73.7 175+83.5 176+32.9 176+96.1 177+39.5	23.8 26.9 22.9 26.0	23.0 23.6 24.5 30.6 28.6	TYPE 3 OBJECT TYPE 3 OBJECT BRIDGE WEIGHT FIRE DISTRICT NO PASSING 2 TYPE 3 OBJECT TYPE 3 OBJECT FIRE DISTRICT STOP SIGN	CT MARKER CT MARKER HT LIMIT SIGN (2) SIGN ZONE CT MARKER CT MARKER SIGN	
	1 1 1 1 1 1 1 1 1	169+63.3 169+64.0 169+96.9 170+05.0 170+29.3 170+37.4 170+58.5 172+58.9 172+69.4 173+43.4 174+21.6 174+29.0	52.2 59.3 52.7 50.2 60.7 57.4 54.3 66.3 67.7				1 1 1 1 2 1 1 1 1 1	174+87.2 175+83.7 176+31.8 176+34.2 177+12.3 177+84.1 178+73.7 175+83.5 176+32.9 176+96.1	23.8 26.9 22.9 26.0	23.0 23.6 24.5 30.6	TYPE 3 OBJECT TYPE 3 OBJECT BRIDGE WEIGHT FIRE DISTRICT NO PASSING 2 TYPE 3 OBJECT TYPE 3 OBJECT FIRE DISTRICT	CT MARKER CT MARKER HT LIMIT SIGN (2) SIGN ZONE CT MARKER CT MARKER SIGN SIGN	
	1 1 1 1 1 1 1 1 1	169+63.3 169+64.0 169+96.9 170+05.0 170+29.3 170+37.4 170+58.5 172+58.9 172+69.4 173+43.4 174+21.6	52.2 59.3 52.7 50.2 60.7 57.4 54.3 66.3 67.7	59.7 60.6	RE'S DESCRETION AND MAINTENANCE		1 1 1 1 1 1 1 1 1 1 1 1 1 1 1 1 1 1 1 1	174+87.2 175+83.7 176+31.8 176+34.2 177+12.3 177+84.1 178+73.7 175+83.5 176+32.9 176+96.1 177+39.5 177+76.5	23.8 26.9 22.9 26.0	23.0 23.6 24.5 30.6 28.6 19.0	TYPE 3 OBJECT TYPE 3 OBJECT BRIDGE WEIGHT FIRE DISTRICT NO PASSING 2 TYPE 3 OBJECT TYPE 3 OBJECT FIRE DISTRICT STOP SIGN SPEED LIMIT,	CT MARKER CT MARKER HT LIMIT SIGN (2) SIGN ZONE CT MARKER CT MARKER SIGN SIGN	

WILLS BURKE KELSEY ASSOCIATES LTD.

116 West Main Street, Suite 201
St. Charles, Illinois 60174

USER NAME = nparris	DESIGNED -	KENIZED -
	DRAWN -	REVISED -
PLOT SCALE = 1:1	CHECKED -	REVISED -
PLOT DATE = 7/9/2013	DATE -	REVISED -

TOTAL

SCALE:

TOTAL SHEET NO. 86 11

SCHEDULE OF QUANTITIES

	EACH	LOCATION	<u>O/S (LT)</u>	<u>O/S (RT)</u>	COMMENTS
	1	172+80.60		26.6	
	1	173+60.50		26.6	
	1	173+90.00	27.5		
	1	174+40.50		26.6	
	1	176+30.00	26.6		
	1	176+80.50		27.3	
	6	TOTAL			
78200530	BARRIER W	ALL MARKERS,	TYPE C		
	EACH	LOCATION	O/S (LT)	<u>O/S (RT)</u>	COMMENTS
	1	174+70.00	26.5		
	1	175+20.50	730	26.5	
	1	175+50.00	26.5		
	1	176+00.50		26.5	
	4	TOTAL			
78201000	TERMINAL I	MARKER - DIREC	T APPLIED		
	EACH	LOCATION	O/S (LT)	<u>O/S (RT)</u>	COMMENTS
	1	172+06.07		27.6	
	1	173+81.07	27.6		
	1	176+50.30	26.6		
	1	176+99.53		27.6	
	4	TOTAL			
XX007562	SIGN REMO	VAL, SPECIAL			
	LSUM	LOCATION	O/S (LT)	O/S (RT)	COMMENTS
	1	176+96.0		41.3	JERICHO LAKE PARK SIGN
	1	TOTAL			
20055905	TEMPORAR	Y CONSTRUCTIO	N FENCE		
	FOOT	LOCATION	O/S (LT)	O/S (RT)	COMMENTS
	37.7	176+29.3		125.1	ASSUME 12' DIAMETER CIRCLE FENC
	37.7	176+40.1		95.7	FOR ALL LOCATIONS AROUND TREES
	37.7	176+56.3	22.7	74.0	
	37.7	177+02.8	52.9		
	37.7	177+20.3		88.1	

		WILLS BURKE KELSEY ASSOCIATES LTD
	WBK	116 West Main Street, Suite 201 St. Charles, Illinois 60174
]		A

USER NAME = nparris	DESIGNED -	REVISED -
	DRAWN -	REVISED -
PLOT SCALE = 1:1	CHECKED -	REVISED -
PLOT DATE = 7/9/2013	DATE -	REVISED -

500.0

689 TOTAL

STATE OF ILLINOIS
DEPARTMENT OF TRANSPORTATION

RE'S DESCRETION AND MAINTENANCE

SCHEDULE OF QUANTITIES	F.A.U. RTE.				SHEET NO.	
		1542	04-00329-00-BR	KANE	86	12
				CONTRACT	NO.	
EET NO. 3 OF 10 SHEETS STA.	TO STA.		ILLINOIS FED. A	ID PROJECT		

MISCELLANEOUS REMOVAL SCHEDULE

			44000100	44000200	50105220	56400500	63200310	X0300249	X0323697	X5610662	X5610666	X6026622	XX005896	Z0022810
LOCATION			PAVEMENT REMOVAL	DRIVEWAY PAVEMENT REMOVAL	PIPE CULVERT REMOVAL	FIRE HYDRANTS TO BE REMOVED	GUARDRAIL REMOVAL	REMOVE EXISTING GATE	RUSTIC RAIL FENCE REMOVAL	WATER MAIN TO BE	WATER MAIN TO BE ABANDONED, 16"	VALVE VAULTS TO	CONCRETE PAD REMOVAL	FENCE REMOVAL (SPECIAL)
			(SQ YD)	(SQ YD)	(FOOT)	(EACH)	(FOOT)	(EACH)	(FOOT)	(FOOT)	(FOOT)	(EACH)	(SQ FT)	(FOOT)
JERICI	HO F	ROAD												
169+00.00	-	169+50.00							2.25.29					
169+50.00	-	170+00.00							32.20					
170+00.00	0	170+50.00							50.00					17.0
170+50.00	_	171+00.00	39.9						50.00					
474 . 00 00	_	171+50.00	122.7						50.60	19.3	19.30			
171+50.00	2	172+00.00	121.8						31.5	50.0	50.0			
172+00.00	_	172+50.00	122.6							50.0	50.0			
170 . 50 00	Ú.	173+00.00	123.4							50.0	50.0			
173+00.00	-	173+50.00	126.0			1				50.1	50.1			
	9					'				100000000000000000000000000000000000000				
173+50.00	-	174+00.00	124.1				24.0			50.2	50.2			
174+00.00	-	174+50.00	143.1				24.9			50.9	50.9			
174+50.00	-	174+83.30	140.3			1	79.2			10.5	10.5			
BRIDGE	OMI	MISION			4.4		5.25		10.00	100.0	1.0074			
175+97.30	-	176+00.00	73.7		7.2		37.2		21.2	55.3	1.0			
176+00.00	-	176+50.00	209.9	107.4	32.8		65.8		55.4		5.4			
176+50.00	<u> -</u>	177+00.00	144.0	421.2				1	19.6	50.0	55.3	2	61.9	
177+00.00	-	177+50.00	129.0	152.5	19.0	1		1	31.1	50.0	50.0			91.6
177+50.00	_	178+00.00	128.6	16.3					1907.9	50.0	50.0			30.4
178+00.00	-2	178+50.00	126.8	89.8	22.0					50.0	50.0			4.5
170 . 50 00		179+00.00	124.9	00.0	22.0					50.0	50.0			
				1 4	18.0						50.0			
179+00.00	-	179+50.00	126.8		16.0					50.0				
179+50.00	-	180+00.00	133.9							50.0	50.0			
180+00.00	-	180+50.00								13.9	33.2			
180+50.00	-	181+00.00												
JERICHO LAN	KE P	ARK ENTR												
4.00.00	_	1+50.00	96.4											
4. 50.00	_	2+00.00												
2+00.00		2+50.00	103.8											
2+50.00		3+00.00	100.0											
	7		140.0											
3+00.00	-	3+50.00	142.8											
3+50.00	-	3+81.50	074.0											
3+81.50	-	4+00.00	271.3											
4+00.00 4+50.00		4+50.00 5+00.00												
4130.00		3.00.00					11							
TOTAL			2875.7	787.2	99.0	3	207.1	2	341.6	750.2	724.9	2	61.9	139.0
ADJUSTED TO	OTA		2,876	788	99	3	208	2	342	751	725	2	62	139

WILLS BURKE KELSEY ASSOCIATES LTD.

116 West Main Street, Suite 201
St. Charles, Illinois 60174

USER NAME = nparris	DESIGNED -	REVISED -
	DRAWN -	REVISED -
PLOT SCALE = 1:1	CHECKED -	REVISED -
PLOT DATE = 7/9/2013	DATE -	REVISED -

SCALE:

SCHEDULE OF QU	ANTITIES		F.A.U. RTE.	SECTION	COUNTY	TOTAL SHEETS
			1542	04-00329-00-BR	KANE	86
					CONTRACT	NO.
SHEET NO. 4 OF 10 SHEETS	STA.	TO STA.		ILLINOIS FED. A	ID PROJECT	

COUNTY TOTAL SHEET NO. KANE 86 13

PAVEMENT SCHEDULE

		30300112	31101200	31102000	35102200	40600200	40600300	40603080	40603310	40603335	42001430	48101500	48203013	48203021	60107600	60600605
LOCATION		AGGREGATE SUBGRADE IMPROVEMENT 12"	SUBBASE GRANULAR MATERIAL, TYPE B 4"	SUBBASE GRANULAR MATERIAL, TYPE C	AGGREGATE BASE COURSE, TYPE B, 10"	BITUMINOUS	AGGREGATE (PRIME COAT)	HOT-MIX ASPHALT BINDER COURSE, IL- 19.0, N50	HOT-MIX ASPHALT SURFACE COURSE, MIX "C", N50	HOT-MIX ASPHALT SURFACE COURSE, MIX "D", N50	BRIDGE APPROACH PAVEMENT CONNECTOR (FLEXIBLE)	AGGREGATE SHOULDERS, TYPE B 6"	HOT-MIX ASPHALT SHOULDERS, 4"	HOT-MIX ASPHALT SHOULDERS, 6"	PIPE UNDERDRAINS 4"	CONCRETE CURB, TYPE B
		(SQ YD)	(SQ YD)	(CU YD)	(SQ YD)	(TON)	(TON)	(TON)	(TON)	(TON)	(SQ YD)	(SQ YD)	(SQ YD)	(SQ YD)	(FOOT)	(FOOT)
	CHO ROAD															
169+00.00	- 169+50.00															
169+50.00	- 170+00.00															
170+00.00	- 170+50.00	46.7				0.40	0.10	10.4		4.0		6.7				
170+50.00	- 171+00.00	46.7		2.0		0.10	0.12	19.4 73.4		4.9		6.7		26.1		
171+00.00 171+50.00	- 171+50.00 - 172+00.00	211.4 273.8		2.0 2.9		0.38 0.49	0.53 0.68	73.4 94.6		22.4 29.4		2.4		36.1 51.5		
171+30.00	- 172+50.00 - 172+50.00	288.1		3.7		0.49	0.68	94.6		31.0				65.9		
172+50.00	- 172+30.00 - 173+00.00	283.4		3.4		0.49	0.72	94.6		30.5				61.1		
173+00.00	- 173+50.00	285.9		3.6		0.48	0.71	93.7		30.8				65.6		
173+50.00	- 174+00.00	331.6		6.7		0.46	0.83	89.6		35.9				120.4		
174+00.00	- 174+50.00	335.4		6.9		0.41	0.84	79.2		33.7	35.2			124.3		
174+50.00	- 174+83.30	9.9		0.2		0.11	0.02	70.2		1.9	25.7		7.03	10.3		
	OMMISION	3,3		4.5			0.94							3,7,7		
175+97.30	- 176+00.00	1 1		4.5						1 0			7.03			
176+00.00	- 176+50.00	140.7		2.9		0.13	0.35	24.4		13.5	60.9		2002	59.3		
176+50.00	- 177+00.00	353.7		7.9		0.46	0.88	89.6		38.4	1,757,757			142.6		
177+00.00	- 177+50.00	312.2		5.6		0.46	0.78	89.6		33.7				100.9		
177+50.00	- 178+00.00	239.4		0.7		0.50	0.60	96.4		25.6				13.1		
178+00.00	- 178+50.00	233.3				0.51	0.58	99.6		24.9				1000		
178+50.00	- 179+00.00	233.3				0.51	0.58	99.6		24.9						
179+00.00	- 179+50.00	233.3				0.51	0.58	99.6		24.9						
179+50.00	- 180+00.00	216.8				0.48	0.54	92.1		23.0						
180+00.00	- 180+50.00					14010				170.22						
180+50.00	- 181+00.00															
DDIVATE EN	ITRANCES (P.E.)															
	36.40 LT		34.0			0.07	0.09	10.8	3.6							
	14.60 LT		98.8			0.22	0.25	31.7	10.6							
JERICHO LA	KE PARK ENTR						2-1-2			1,2						
1+00.00	- 1+50.00				74.1	0.16	0.19	9.6		5.7						
1+50.00	- 2+00.00				144.4	0.31	0.36	18.7		11.2						
2+00.00	- 2+50.00				144.4	0.31	0.36	18.7		11.2						
2+50.00	- 3+00.00				144.4	0.31	0.36	18.7		11.2						
3+00.00	- 3+50.00				144.4	0.31	0.36	18.7		11.2						
3+50.00	- 3+81.50	6.00			114.3	0.24	0.29	14.8		8.9						
3+81.50	- 4+00.00	76.7				0.16	0.19	31.4		7.8						
4+00.00	- 4+50.00	233.0				0.50	0.58	97.5		24.4						80.6
4+50.00	- 5+00.00	305.8				0.70	0.76	134.7		33.7						23.8
		10000		-	-, 7,1											
TOTAL		4644.42	132.76	55.57	766.20	10.2	13.9	1734.9	14.1	554.7	121.9	9.1	14.1	851.1		104.4
ADJUSTED TO	ΓAL	4645.0	133.0	56.0	767.0	11	14	1,735	15	555	122	10	15	852		105

WILLS BURKE KELSEY ASSOCIATES LTD.

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PLOT SCALE = 1:1	CHECKED -	REVISED -
PLOT DATE = 7/9/2013	DATE -	REVISED -

STATE OF ILLINOIS
DEPARTMENT OF TRANSPORTATION

SCHEDULE OF QUA	ANTITIES		F.A.U. RTE.	SECTION	COUNTY	TOTAL SHEETS	SHEET NO.
			1542	04-00329-00-BR	KANE	86	14
					CONTRAC	Γ NO.	
SHEET NO. 5 OF 10 SHEETS	STA.	TO STA.		ILLINOIS FED. A	ID PROJECT		

STRIPING AND GUARDRAIL SCHEDULE

STEEL PLATE BE GUARDRAIL, TYPE FOOT POSTS	63000001 6310	0085 63100167	X0640200	78009000	78009004	78009008	78009012	78009024
COCATION FOOT POSTS	[12] [14] [15] [16] [16] [16] [16] [16] [16] [16] [16	. 프리스트웨어 보안되었다 1	TRAFFIC BARRIER	MODIFIED URETHANE	MODIFIED URETHANE	MODIFIED URETHANE		MODIFIED URETHANE
JERICHO ROAD 169+00.00 169+50.00 169+50.00 170+00.00 170+00.00 170+00.00 170+00.00 170+50.00 171+00.00 171+00.00 171+00.00 171+00.00 171+00.00 172+00.00 172+00.00 172+00.00 172+50.00 172+50.00 173+00.00 43.9 173+00.00 173+50.00 50.0 173+50.00 50.0 173+50.00 174+00.00 174+00.00 174+30.00 31.1 174+30.00 174+30.00 174+30.00 176+00.00 176+00.00 176+50.00 176+50.00 177+00.00 177+00.00 177+50.00 177+50.00 178+00.00 178+00.00 178+50.00 179+00.00 179+00.00 179+50.00 180+00.00 180+00.00 180+00.00 180+50.00 180+50.00 180+50.00 180+50.00 180+50.00 1450.00 2+50.00 2+50.00 2+50.00 3+50.00 3+50.00 3+50.00 3+81.50 3+81.50 3+81.50 3+81.50 4+00.00		L, TYPE 6 TERMINAL, TYPE 1 (SPECIAL) TANGENT	TERMINAL (SPECIAL)	PAVEMENT MARKING - LETTERS AND SYMBOLS	LINE 4"	PAVEMENT MARKING - LINE 8"	LINE 12"	LINE 24"
169+00.00 - 169+50.00 169+50.00 - 170+00.00 170+00.00 - 170+50.00 170+50.00 - 171+00.00 171+00.00 - 171+50.00 171+50.00 - 172+00.00 172+00.00 - 172+50.00 172+50.00 - 173+00.00 173+50.00 - 174+00.00 174+00.00 - 174+50.00 174+00.00 - 174+50.00 174+50.00 - 174+83.30 BRIDGE OMMISION 175+97.30 - 176+00.00 176+00.00 - 177+00.00 177+00.00 - 177+50.00 177+50.00 - 178+00.00 177+50.00 - 178+00.00 178+00.00 - 178+00.00 179+00.00 - 179+00.00 179+00.00 - 179+00.00 179+00.00 - 180+00.00 180+00.00 - 180+00.00 180+00.00 - 180+00.00 180+00.00 - 180+00.00 180+50.00 - 3+00.00 180+50.00 - 3+50.00 3+50.00 - 3+81.50 3+81.50 - 4+00.00 4+00.00 - 4+50.00	(FOOT) (EA	CH) (EACH)	(EACH)	(SQ FT)	(FOOT)	(FOOT)	(FOOT)	(FOOT)
169+50.00 - 170+00.00 170+00.00 - 170+50.00 170+50.00 - 171+00.00 171+00.00 - 171+50.00 171+50.00 - 172+00.00 172+00.00 - 172+50.00 172+50.00 - 173+00.00 172+50.00 - 173+50.00 173+50.00 - 174+00.00 174+00.00 - 174+50.00 174+00.00 - 174+50.00 174+50.00 - 174+83.30 BRIDGE OMMISION 175+97.30 - 176+00.00 176+00.00 - 176+50.00 176+50.00 - 177+00.00 177+00.00 - 178+00.00 178+00.00 - 178+00.00 178+00.00 - 179+00.00 178+00.00 - 179+50.00 179+50.00 - 180+00.00 180+00.00 - 180+50.00 180+00.00 - 180+50.00 180+00.00 - 180+50.00 180+50.00 - 2+00.00 2+00.00 - 2+50.00 2+50.00 - 3+00.00 3+50.00 - 3+81.50 3+81.50 - 4+00.00 4+00.00 - 4+50.00								
170+00.00 - 170+50.00 170+50.00 - 171+00.00 171+00.00 - 171+50.00 171+50.00 - 172+00.00 172+00.00 - 172+50.00 172+50.00 - 173+00.00 172+50.00 - 173+50.00 173+50.00 - 174+00.00 174+00.00 - 174+50.00 174+00.00 - 174+50.00 174+50.00 - 174+83.30 BRIDGE OMMISION 175+97.30 - 176+00.00 176+00.00 - 177+00.00 177+00.00 - 177+50.00 177+50.00 - 178+00.00 178+00.00 - 178+00.00 178+00.00 - 179+00.00 179+50.00 - 179+00.00 179+50.00 - 180+00.00 180+00.00 - 180+50.00 180+00.00 - 180+50.00 180+50.00 - 2+00.00 2+00.00 - 2+50.00 2+50.00 - 3+00.00 3+50.00 - 3+81.50 3+81.50 - 4+00.00 4+00.00 - 4+50.00					20.0			
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3+50.00 - 3+81.50 3+81.50 - 4+00.00 4+00.00 - 4+50.00						18.5		
3+81.50 - 4+00.00 4+00.00 - 4+50.00						63.4		
4+00.00 - 4+50.00						41.8		
						67.2		
				72.8		117.6	60.6	36.8
TOTAL 175.0	175.0	3	1	72.8	4620.0	308.5	60.6	36.8
ADJUSTED TOTAL 175	175	3	1	73	4,620	309	61	37

WILLS BURKE KELSEY ASSOCIATES LTD.

116 West Main Street, Suite 201
St. Charles, Illinois 60174

USER NAME = nparris	DESIGNED -	REVISED -
	DRAWN -	REVISED -
PLOT SCALE = 1:1	CHECKED -	REVISED -
PLOT DATE = 7/9/2013	DATE -	REVISED -

STATE OF ILLINOIS
DEPARTMENT OF TRANSPORTATION

SCHEDULE	OF QUA	ANTITIES		F.A.U. RTE.	SECTION	COUNTY
				1542	04-00329-00-BR	KANE
						CONTRA
SHEET NO. 6 OF 10	SHEETS	STA.	TO STA.		ILLINOIS FED. A	ID PROJECT

86 15

CONTRACT NO.

EROSION CONTROL SCHEDULE

	25100630	28000250	28000305	28000315	28000400	28000500	28100105	28100107	28200200	XX006345
LOCATION	EROSION CONTROL BLANKET	TEMPORARY EROSION CONTROL SEEDING *	TEMPORARY DITCH CHECKS	AGGREGATE DITCH CHECKS	PERIMETER EROSION BARRIER	INLET AND PIPE PROTECTION	STONE RIPRAP, CLASS A3	STONE RIPRAP, CLASS A4	FILTER FABRIC	TURBIDITY BARRIER
	(SQ YD)	(POUND)	(FOOT)	(TON)	(FOOT)	(EACH)	(SQ YD)	(SQ YD)	(SQ YD)	(FOOT)
JERICHO ROAD	(04.12)	(. 552)	(. 5.5.1)	(1011)	(1.00.)	(2.13.1)	(04.12)	(34.12)	(5 4 1 2)	(, 55.)
169+00.00 - 169+50.00	78.4	3.2			39.2					
169+50.00 - 170+00.00	266.7	11.0			92.1					
170+00.00 - 170+50.00	247.9	10.2	1.77		100.0					
170+50.00 - 171+00.00	323.5	13.4	10.0		100.0					
[[[하다]] [[[[[] [[] [[] [[] [[] [[] [[] [[] [19.2	10.0							
	464.2		1.533.53		100.0					
171+50.00 - 172+00.00	404.0	16.7	10.0		100.0					
172+00.00 - 172+50.00	389.7	16.1	10.0		100.0					
172+50.00 - 173+00.00	449.1	18.6	10.0		110.0					
173+00.00 - 173+50.00	447.5	18.5	10.0		100.0					
173+50.00 - 174+00.00	401.8	16.6	10.0		100.0					
174+00.00 - 174+50.00	397.9	16.4		1.3	100.0					
174+50.00 - 174+83.30	232.4	9.6			66.6			1-8-22	100,000	72.455
BRIDGE OMMISION	408.1	16.9			143.9			869.0	869.0	269.0
175+97.30 - 176+00.00					5.4				V	
176+00.00 - 176+50.00	615.3	25.4	30.0		247.1					
176+50.00 - 177+00.00	804.8	33.3	10.0		92.8					
177+00.00 - 177+50.00	688.4	28.4	3.344		120.9	1 1	4.6		4.6	
177+50.00 - 178+00.00	732.8	30.3	10.0		84.2		27792			
178+00.00 - 178+50.00	669.5	27.7	10.0		77.4					
178+50.00 - 179+00.00	369.7	15.3	10.0		108.0					
179+00.00 - 179+50.00	653.2	27.0			175.5					
179+50.00 - 180+00.00		16.8	10.0		179.7					
	405.6	10.0	10.0		179.7					
180+00.00 - 180+50.00 180+50.00 - 181+00.00										
JERICHO LAKE PARK ENTR										
1+00.00 - 1+50.00			2.19							
1+50.00 - 2+00.00			20.0							
2+00.00 - 2+50.00			20.0							
2+50.00 - 3+00.00			100							
3+00.00 - 3+50.00			20.0							
3+50.00 - 3+81.50			10.0							
3+81.50 - 4+00.00			10.0							
4+00.00 - 4+50.00	32.4	1.3	30.0							
	7.6	0.3	30.0							
4+50.00 - 5+00.00	7.0	0.3								
MAINTENANCE	100.0		20.0	0.5	200.0	1				
TOTAL	9,590.6	392.2	260.0	1.8	2,542.8	2	4.6	869.0	873.6	269.0
ADJUSTED TOTAL	9,591	393	260	2	2,543	2	5	869	874	269

WILLS BURKE KELSEY ASSOCIATES LTD.
116 West Main Street, Suite 201
St. Charles, Illinois 60174

USER NAME = nparris	DESIGNED -	REVISED -
	DRAWN -	REVISED -
PLOT SCALE = 1:1	CHECKED -	REVISED -
PLOT DATE = 7/9/2013	DATE -	REVISED -

STATE OF ILLINOIS
DEPARTMENT OF TRANSPORTATION

SCHEDULE OF QUANTITIES		F.A.U. RTE.	SECTION	COUNTY	TOTAL SHEETS	SHEET NO.
		1542	04-00329-00-BR	KANE	86	16
				CONTRACT	NO.	
SHEET NO. 7 OF 10 SHEETS STA.	TO STA.		ILLINOIS FED. A	ID PROJECT		

SEEDING SCHEDULE

	21101625	21101665	25000100	25000210	25000310	25000312	25000320	25000324	ZZZZZZ 03	25000400	25000500	25000600
LOCATION	TOPSOIL FURNISH AND PLACE, 6"	TOPSOIL FURNISH AND PLACE, 18"	SEEDING, CLASS 1	SEEDING, CLASS 2A	SEEDING, CLASS 4	SEEDING, CLASS 4A	SEEDING, CLASS 5	SEEDING, CLASS 5B	SEEDING, CLASS 4 MODIFIED (SHADED STREAMBANK)	NITROGEN FERTILIZER NUTRIENT	PHOSPHORUS FERTILIZER NUTRIENT	POTASSIUM FERTILIZER NUTRIENT
	(SQ YD)	(SQ YD)	(ACRE)	(ACRE)	(ACRE)	(ACRE)	(ACRE)	(ACRE)	(ACRE)	(POUND)	(POUND)	(POUND)
JERICHO ROAD	VIII 2007.5		7 7	200	7 =	4 5 5				7.07		A.S.S.
169+00.00 - 169+50.00				0.02			40.4			1.5	1.5	1.5
169+50.00 - 170+00.00				0.03	0.03		0.03			5.0	5.0	5.0
170+00.00 - 170+50.00	247.9			0.03	0.02		0.02			4.6	4.6	4.6
170+50.00 - 171+00.00	323.5			0.04	0.02		0.02	0.00		6.0	6.0	6.0
171+00.00 - 171+50.00	464.2			0.07	0.02		0.01	0.01		8.6	8.6	8.6
171+50.00 - 172+00.00	404.0			0.04	0.04		0.02	0.02		7.5	7.5	7.5
172+00.00 - 172+50.00	389.7			0.02	0.06		0.04	0.02		7.2	7.2	7.2
172+50.00 - 173+00.00				0.02	0.07		0.05	0.02		8.4	8.4	8.4
173+00.00 - 173+50.00	447.5			0.02	0.07		0.04	0.03		8.3	8.3	8.3
173+50.00 - 174+00.00				0.01	0.08		0.05	0.03		7.5	7.5	7.5
174+00.00 - 174+50.00				515.0	0.08		0.05	0.03		7.4	7.4	7.4
174+50.00 - 174+83.30					0.03		0.02	0.01	0.01	4.3	4.3	4.3
BRIDGE OMMISION	408.1				0.00		0.02	0.01	0.08	7.6	7.6	7.6
175+97.30 - 176+00.00									0.00	7.0	7.0	7.0
176+00.00 - 176+50.00			0.05	0.02	0.03	0.03	0.03			11.4	11.4	11.4
176+50.00 - 177+00.00			0.07	0.01	0.03	0.05	0.03			15.0	15.0	15.0
			0.04		0.03		0.03			12.8	42 D VC	12.8
				0.06	0.01	0.04	0.01				12.8	
177+50.00 - 178+00.00			0.04	0.07		0.04				13.6	13.6	13.6
178+00.00 - 178+50.00			0.06	0.06	0.04	0.02	0.04			12.4	12.4	12.4
178+50.00 - 179+00.00			0.03	0.04	0.01		0.01			6.9	6.9	6.9
179+00.00 - 179+50.00			0.06	0.05	0.02		0.02			12.1	12.1	12.1
179+50.00 - 180+00.00				0.06	0.02		0.02			7.5	7.5	7.5
180+00.00 - 180+50.00				6.72-4	4-4-		h 3				the discount	
180+50.00 - 181+00.00												
JERICHO LAKE PARK ENTR	60											
1+00.00 - 1+50.00												
1+50.00 - 2+00.00												
2+00.00 - 2+50.00	A land											
2+50.00 - 3+00.00												
3+00.00 - 3+50.00												
3+50.00 - 3+81.50												
3+81.50 - 4+00.00	X											
4+00.00 - 4+50.00		32.4	0.01							0.6	0.6	0.6
4+50.00 - 5+00.00		7.7	0.00							0.0	0.1	0.0
MAINTENANCE												
TOTAL	9,450.6	40.1	0.36	0.68	0.66	0.17	0.49	0.17	0.09	176.5	176.5	176.5
ADJUSTED TOTAL	9,451	41	0.50	0.75	0.75	0.25	0.50	0.25	0.25	177	177	177
ADDOOR TO TAL	3,731		0.00	0.13	0.75	0.23	0.50	0.23	0.23			111

WILLS BURKE KELSEY ASSOCIATES LTD.

116 West Main Street, Suite 201
St. Charles, Illinois 60174

USER NAME = nparris	DESIGNED -	REVISED -
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PLOT SCALE = 1:1	CHECKED -	REVISED -
PLOT DATE = 7/9/2013	DATE -	REVISED -

STATE OF ILLINOIS
DEPARTMENT OF TRANSPORTATION

SCALE:

SCHEDULE OF QUANTITIES				F.A.U RTE.	F.A.U. RTE.	
				1542		04-00329
SHEET NO. 8 OF	10 SHEETS	STA.	TO STA.			

LANDSCAPING SCHEDULE

	A2001724	A2005030	A2005670	A2006420	A2006726	B2000668	B2004170	Z0055900
LOCATION	TREE, ACER SACCHARUM (SUGAR MAPLE), 3" CALIPER, BALLED AND BURLAPPED	COFFEETREE), 4"	TREE, OSTRYA VIRGINIANA (AMERICAN HOPHORNBEAM), 8' HEIGHT, CLUMP FORM, BALLED AND BURLAPPED	CALIPER, BALLED AND	TREE, QUERCUS MACROCARPA (BUR OAK), 3" CALIPER, BALLED AND BURLAPPED	SERVICEBERRY), 7'	TREE, MALUS PRAIRIFIRE (PRAIRIFIRE CRABAPPLE), 8' HEIGHT, CLUMP FORM, BALLED AND BURLAPPED	RUSTIC WOOD POST AND RAIL FENCE
	(EACH)	(EACH)	(EACH)	(EACH)	(EACH)	(EACH)	(EACH)	(FOOT)
JERICHO ROAD	A Section 1							
169+00.00 - 169+50.00 169+50.00 - 170+00.00 170+00.00 - 170+50.00 170+50.00 - 171+00.00								56.0 50.0 50.0 50.0
171+00.00 - 171+50.00 171+50.00 - 172+00.00 172+00.00 - 172+50.00								50.0 31.3
172+50.00 - 173+00.00 173+00.00 - 173+50.00 173+50.00 - 174+00.00 174+00.00 - 174+50.00								
174+50.00 - 174+83.30								
BRIDGE OMMISION								14.6
175+97.30 - 176+00.00 176+00.00 - 176+50.00			1		4	2		2.7 50.0
176+50.00 - 177+00.00 177+00.00 - 177+50.00 177+50.00 - 178+00.00		1 1	1		ı			50.0 50.0 50.0
178+00.00 - 178+50.00 178+50.00 - 179+00.00 179+00.00 - 179+50.00	2			1	1		1	31.8
179+50.00 - 180+00.00 180+00.00 - 180+50.00 180+50.00 - 181+00.00								
JERICHO LAKE PARK ENTR 1+00.00 - 1+50.00 1+50.00 - 2+00.00								
2+00.00 - 2+50.00 2+50.00 - 3+00.00 3+00.00 - 3+50.00								
3+50.00 - 3+81.50 3+81.50 - 4+00.00 4+00.00 - 4+50.00 4+50.00 - 5+00.00								
TOTAL	2	2	2	2	2	2	1	536.4
ADJUSTED TOTAL	2	2	2	2	2	2	1	537

WILLS BURKE KELSEY ASSOCIATES LTD.

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PLOT SCALE = 1:1	CHECKED -	REVISED -
PLOT DATE = 7/9/2013	DATE -	REVISED -

STATE OF ILLINOIS
DEPARTMENT OF TRANSPORTATION

SCHEDULE OF QUANTITIES			F.A.U. RTE.	SECTION	COUNTY	TOTAL SHEETS	SHI
			1542	04-00329-00-BR	KANE	86	1
					CONTRACT	NO.	
SHEET NO. 9 OF 10 SHEETS	STA.	TO STA.		ILLINOIS FED. A	ID PROJECT		

WATER MAIN SCHEDULE

	56100600	56100900	56101000	56400820	60248900	X2090215	X5630712	X5630716	XX003032	XX007682	Z0041900
LOCATION	WATER MAIN 6"	WATER MAIN 12"	WATER MAIN 16"	FIR HYDRANT WITH AUXILIARY VALVE AND VALVE BOX	VALVE VAULTS, TYPE A, 5'-DIAMTER, TYPE 1 FRAME, CLOSED LID	SELECT GRANULAR BACKFILL, SPECIAL	CONNECTION TO EXISTING WATER MAIN 12"	CONNECTION TO EXISTING WATER MAIN 16"		GATE VALVES, 16"	POLYETHYLENE ENCASEMENT
	(FOOT)	(FOOT)	(FOOT)	(EACH)	(EACH)	(CU YD)	(EACH)	(EACH)	(EACH)	(EACH)	(FOOT)
Territorial Road 169+00.00 169+50.00 170+00.00 170+00.00 170+50.00 170+50.00 170+50.00 170+50.00 171+00.00 171+00.00 171+50.00 171+50.00 172+00.00 172+00.00 172+50.00 172+50.00 173+00.00 173+00.00 173+50.00 173+50.00 174+00.00 174+00.00 174+50.00 174+50.00 174+50.00 174+83.30 RIDGE OMMISION 175+97.30 176+00.00 176+50.00 176+50.00 177+00.00 177+00.00 177+50.00 178+00.00 178+50.00 178+50.00 179+00.00 179+00.00 179+50.00 179+50.00 180+00.00 180+50.00 180+50.00 180+50.00 180+50.00	3.0 4.0	29.4 50.0 50.0 33.3 21.1	23.2 50.0 50.0 50.0 50.0 50.0 10.5 8.4 100.0 100.0 100.0 100.0 100.0 100.0 100.0 100.0	1	2		1	1 3	1	1	23.2 50.0 50.0 82.4 104.0 100.0 43.8 21.1 8.4 100.0 100.0 100.0 100.0 100.0 100.0 100.0
PRIVATE ENTRANCES (P.E.) 176+86.40 LT 178+14.60 LT						14.6 23.3					
JERICHO LAKE PARK ENTR 1+00.00 - 1+50.00 1+50.00 - 2+00.00 2+00.00 - 2+50.00 2+50.00 - 3+00.00 3+00.00 - 3+50.00 3+50.00 - 3+81.50 3+81.50 - 4+00.00 4+00.00 - 4+50.00 4+50.00 - 5+00.00						41.7					
TOTAL	10.0	183.8	1137.8	3	2	79.6	2	6	1	1	1331.6
ADJUSTED TOTAL	10	184	1,138	3	2	80	2	6	1	1	1,332

WILLS BURKE KELSEY ASSOCIATES LTD.


116 West Main Street, Suite 201
St. Charles, Illinois 60174

USER NAME = nparris	DESIGNED -	REVISED -
	DRAWN -	REVISED -
PLOT SCALE = 1:1	CHECKED -	REVISED -
PLOT DATE = 7/9/2013	DATE -	REVISED -

STATE OF ILLINOIS
DEPARTMENT OF TRANSPORTATION

SCALE:

SCHEDULE OF QUANTITIES				F.A.U. RTE.	SECTION	COUNTY	TOTAL SHEETS	SHEET NO.
				1542	04-00329-00-BR	KANE	86	19
						CONTRAC	T NO.	
	SHEET NO. 10 OF 10 SHEETS	STA.	TO STA.		ILLINOIS FED.	AID PROJECT		

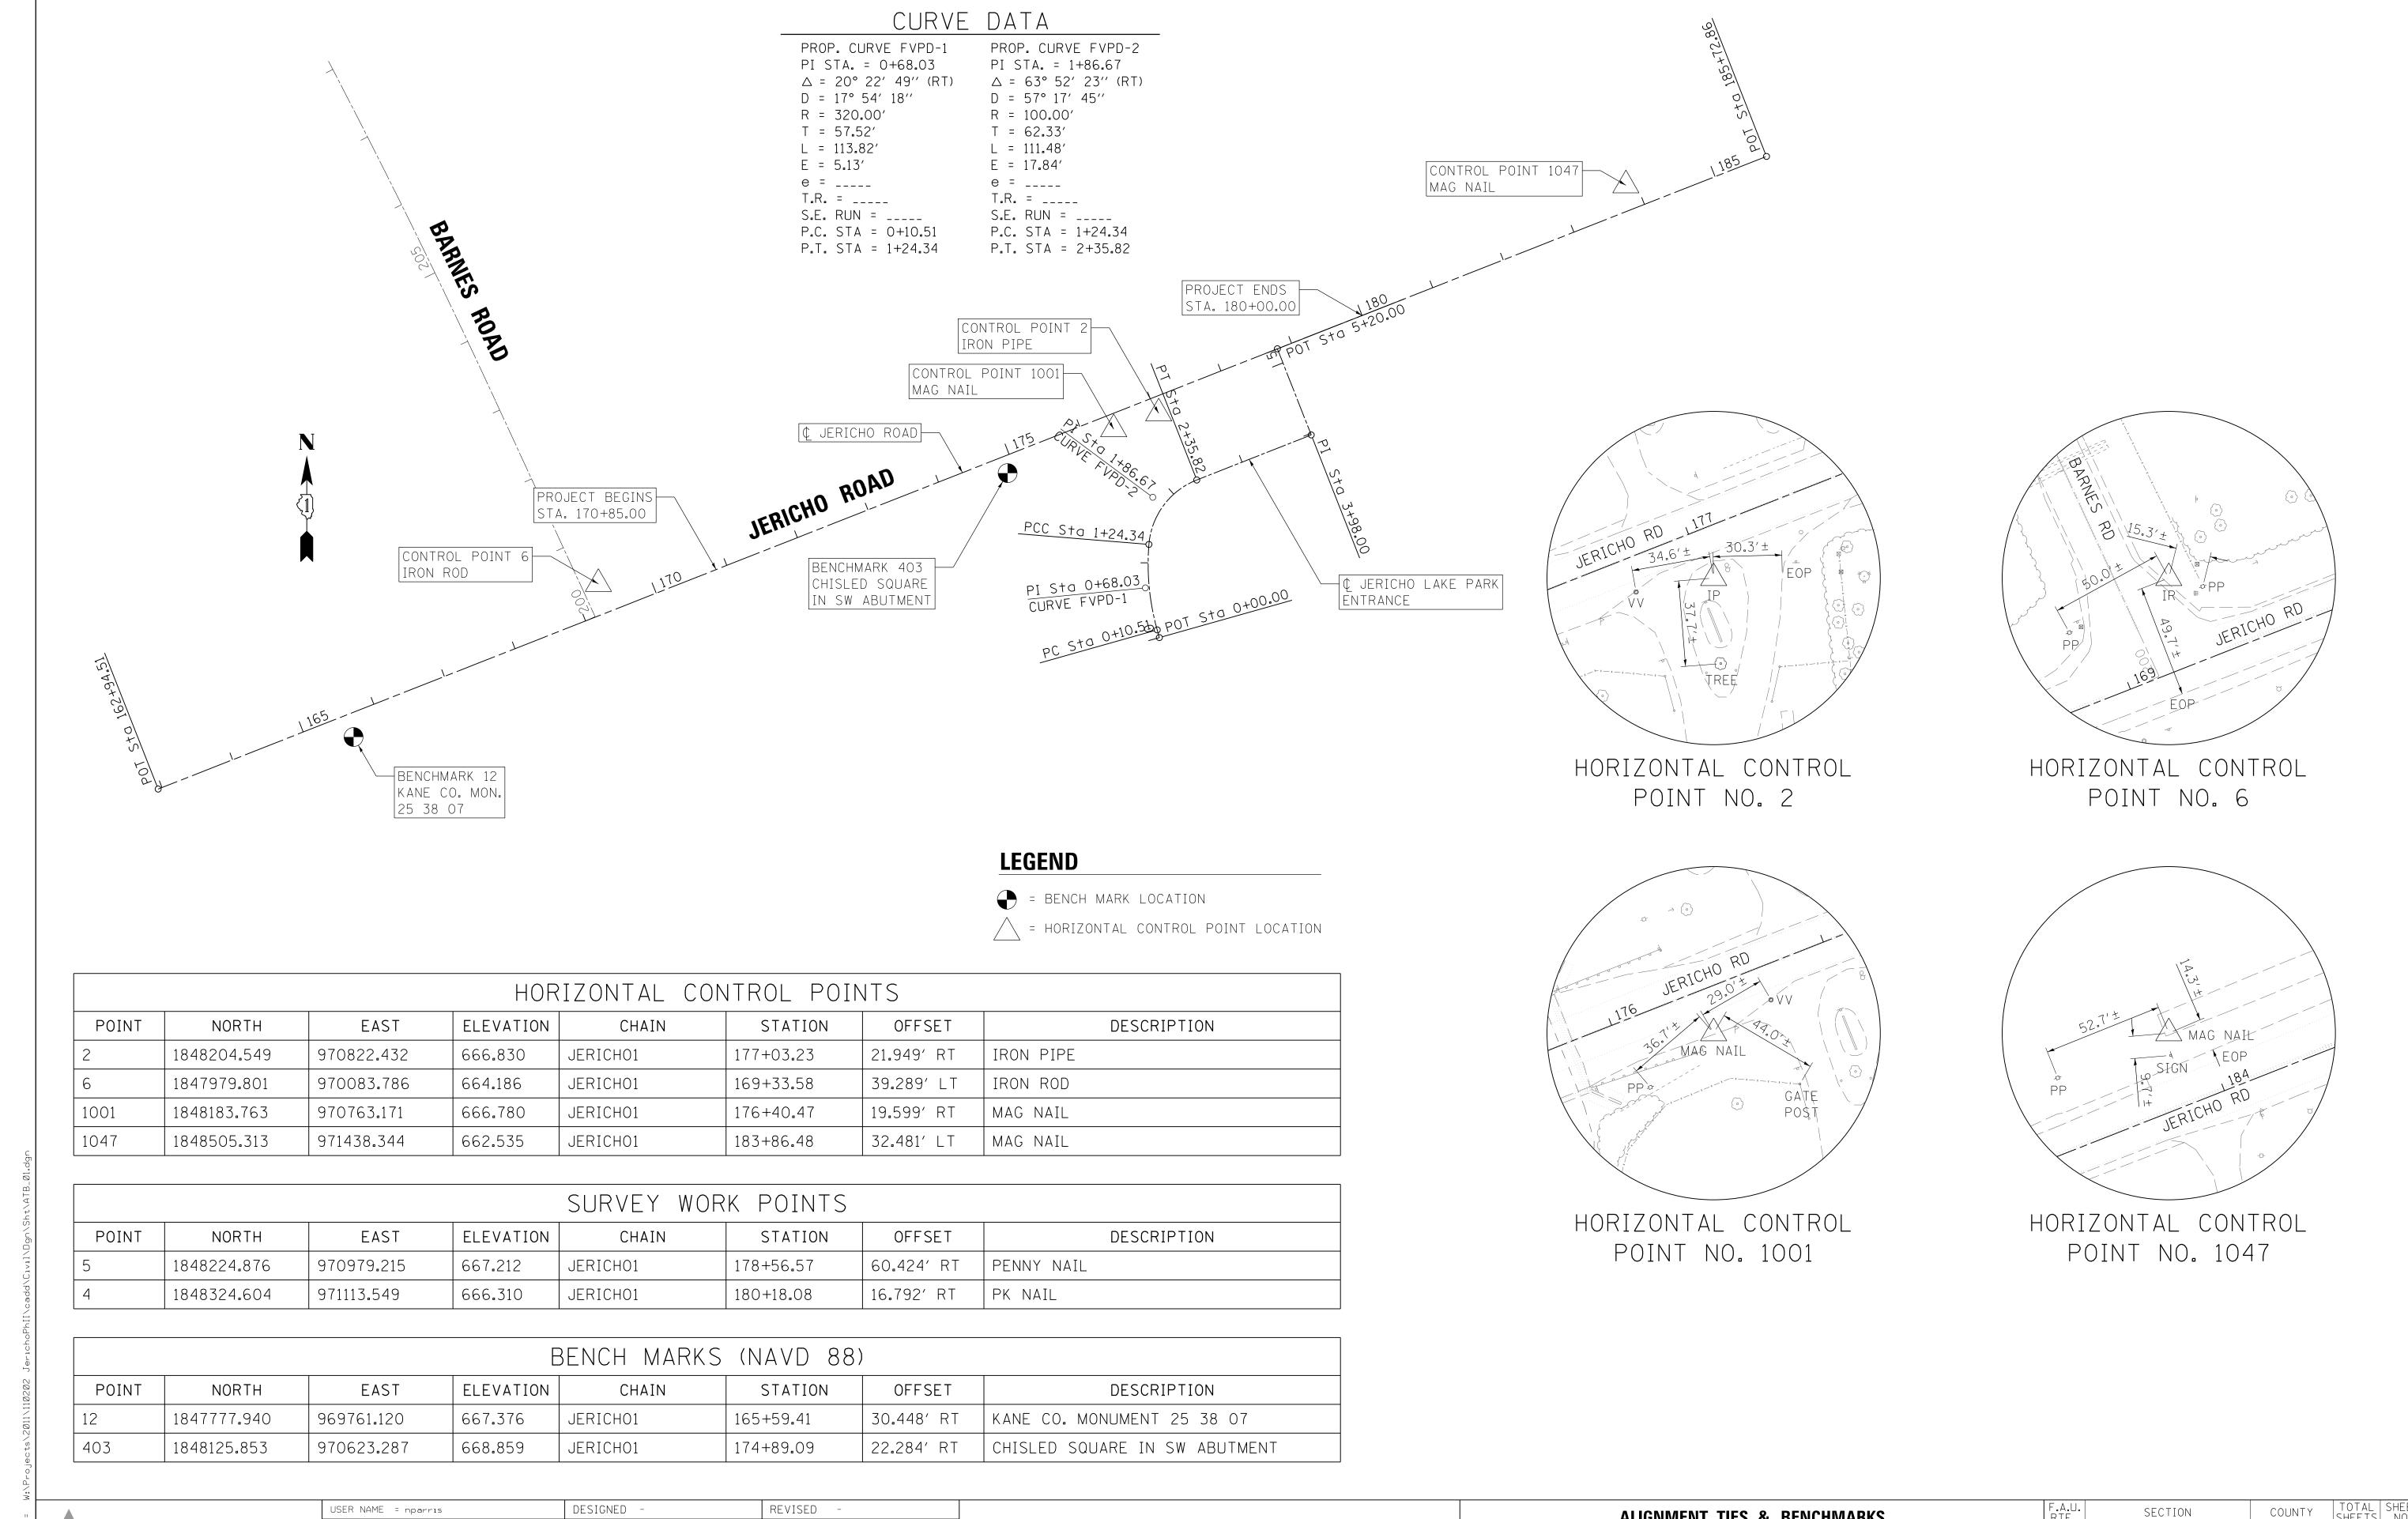

WILLS BURKE KELSEY ASSOCIATES LTD. WBK 116 West Main Street, Suite 201 St. Charles, Illinois 60174

REVISED DRAWN REVISED PLOT SCALE = 1:100 CHECKED PLOT DATE = 7/9/2013DATE REVISED

STATE OF ILLINOIS DEPARTMENT OF TRANSPORTATION

ALIGNMENT, TIES & BENCHMARKS 04-00329-00-BR SCALE: SHEET NO.1 OF 1 SHEETS STA. TO STA.

86 20 KANE CONTRACT NO. ILLINOIS FED. AID PROJECT

GENERAL NOTES:

1. THE CONTRACTOR SHALL CONSTRUCT AND MAINTAIN AGGREGATE SURFACE COURSE FOR TEMPORARY ACCESS TO PRIVATE ENTRANCES AND FIELD ENTRANCES. THE TEMPORARY CLOSURE OF DRIVEWAYS WILL BE LIMITED TO THE DURATION OF THE CONSTRUCTION DIRECTLY IN FRONT OF THE DRIVEWAYS. IN ALL CASES, THE ENTRANCES SHALL BE OPEN AT THE END OF THE WORK DAY. THE CONTRACTOR SHALL COORDINATE CLOSURES WITH THE RESIDENT ENGINEER AND PROPERTY OWNER A MINIMUM OF FORTY EIGHT (48) HOURS IN ADVANCE OF THE CLOSURE.

TEMPORARY DETOUR DURATION

THE CONTRACT DOCUMENTS WILL ALLOW THE ROADWAY CLOSURE AND TEMPORARY DETOUR DETAILED ON THIS SHEET TO REMAIN IN PLACE UNTIL AUGUST XX, 2014. THE CONTRACTOR WILL BE EXPECTED TO COMPLETE ALL THE PROPOSED WORK RELATED TO THE CONSTRUCTION OF THE PROPSED BRIDGE AND ROADWAY DURING THIS CLOSURE. THE ROADWAY MUST HAVE THE HMA SURFACE COURSE PLACED AND THE GUARDRAIL INSTALLED BEFORE THE ROADWAY IS OPENED TO TRAFFIC. IF THE SURFACE COURSE AND GUARD RAIL ARE NOT COMPLETED IN THE ALLOWED TIME, ADDITIONAL TRAFFIC CONTROL DEVISES REQUIRED FOR THE COMPLETION OF REMAINING CONSTRUCTION OPERATIONS WILL BE AT THE CONTRACTOR

CHANGEABLE MESSAGE SIGN

THE CONTRACTOR SHALL PLACE ELECTRONIC CHANGEABLE MESSAGE SIGNS ON THE EAST AND WEST SIDE OF THE BRIDGE TO WARN THE PUBLIC OF THE PENDING CLOSURE. THE MESSAGE BOARDS WILL NEED TO BE PLACED AND SET OUT FOR SEVEN (7) DAYS IN ADVANCE OF THE ANTICIPATED FIRST DAY OF CONSTRUCTION. THE SIGNS SHALL REMAIN IN PLACE FOR THE SPECIFIED CONTRACT TIME. THE CONTRACTOR WILL COORDINATE WITH THE RESIDENT ENGINEER ON THE EXACT PLACEMENT OF THE MESSAGE BOARDS AND THE MESSAGE THAT IS TO BE DISPLAYED. THE MESSAGE MAY PERIODICALLY BE CHANGED BY THE COUNTY. THERE WILL BE NO ADDITIONAL COMPENSATION FOR CHANGING OF THE MESSAGE(S). THE MESSAGE BOARDS WILL BE PAID FOR AS CHANGEABLE MESSAGE SIGN. PER CALENDAR MONTH FOR EACH MESSAGE SIGN UTILIZED.

TEMPORARY INFORMATION SIGN

THE CONTRACTOR SHALL ERECT ON THE EAST AND WEST SIDE OF THE BRIDGE TO INFORM THE PUBLIC OF THE CONSTRUCTION DURATION. THE CONTRACTOR WILL COORDINATE WITH THE RESIDENT ENGINEER ON THE EXACT PLACEMENT OF THE SIGN. THE SIGN SHALL BE IN PLACE FOR THE ENTIRE DURATION OF THE CONTRACT OR AS DIRECTED BY THE RESIDENT ENGINEER. THE TEMPORARY SIGN WILL BE AS DIMENSIONED ON STD. TC22 EXCEPT THE MESSAGE SHALL BE AS DETAILED ON THE DETOUR PLAN. THE SIGNING, WHICH INCLUDES POST AND MOUNTING, WILL BE PAID AS TEMPORARY INFORMATION SIGNING, PER EACH SIGN ERECTED.

CONTACTS

THE CONTRACTOR WILL BE REQUIRED TO COORDINATE ALL MAINTENANCE OF TRAFFIC OPERATIONS WITH ALL MUNICIPALITIES, TOWNSHIP, AND COUNTY ENTITIES WITHIN THE PROJECT LIMITS. THE FOLLOWING IS THE APPLICABLE LIST OF CONTACTS:

KANE COUNTY DIVISION OF TRANSPORTATION CITY OF AURORA PUBLIC WORKS SUGAR GROVE TOWNSHIP KANE CO. SHERIFF KANE CO. OFFICE OF EMERGENCY MANAGEMENT AURORA FIRE DEPARTMENT SUGAR GROVE FIRE DEPARTMENT KANELAND SCHOOL DISTRICT 302 AURORA POLICE DEPARTMENT MONTGOMERY POLICE DEPARTMENT

DAVE BOESCH, CHEIF OF CNSTR. 630-584-1170 KEN SCHROTH, DIRECTOR 630-256-3200 GREG HUGGINS, COMMISSIONER 630-466-4283 PATRICK PEREZ, SHERIFF 630-232-6840 DONALD BRYANT, DIRECTOR 630-232-5985 HAL CARLSON, CHIEF 630-256-4000 630-466-4513 MARTY KUNKEL, CHIEF JEFF SCHULER. SUPERINTENDENT 630-365-5111 GREGORY THOMAS, CHIEF 630-256-5001 DANIEL MEYERS, CHIEF 630-896-8080

LIMITATIONS OF CONSTRUCTION

THE CONTRACTOR SHALL COORDINATE THE ITEMS OF WORK IN ORDER TO KEEP HAZARDS AND TRAFFIC INCONVENIENCES TO A MINIMUM, AS SPECIFIED BELOW:

- 1. DURING THE CONSTRUCTION WHEN THE ROADWAY IS NOT CLOSED, CONSTRUCTION OPERATIONS WILL BE CONDUCTED SO ONE LANE IN EACH DIRECTION ON JERICHO ROAD REMAINS OPEN.
- 2. THE CONTRACTOR SHALL PROVIDE. ERECT. AND MAINTAIN ALL THE NECESSARY SIGNS. BARRICADES. CONES. DRUMS, AND LIGHTS FOR THE WARNING AND PROTECTION OF TRAFFIC, AS REQUIRED BY SECTIONS 107 AND 701 THROUGH 703 OF THE STANDARD SPECIFICATIONS, AND AS MODIFIED.
- 3. THE CONTRACTOR SHALL FURNISH AND ERECT "ROAD CONSTRUCTION AHEAD" SIGNS (W20-1 (0)-48) AT BOTH ENDS OF THE PROJECT AND AT ALL SIDE ROADS WITHIN THE LIMITS OF THIS SECTION WHEN WORKING IN THE VICINITY OF THE SIDE ROAD INTERSECTION.

OFF-PEAK HOURS

FOR CONSTRUCTION OPERATION OUTSIDE THE DESIGNATED DETOUR PERIOD, THE "OFF-PEAK" HOURS ARE DEFINED AS THE DAYTIME HOURS FROM 9:00 A.M. TO 3:00 P.M. AND NIGHT TIME HOURS FROM 9:00 P.M. TO 6:00 A.M., MONDAY THROUGH FRIDAY. THE CONTRACTOR MAY REQUEST IN WRITING FOR THESE HOURS TO BE EXTENDED.

KEEPING ROADS OPEN TO TRAFFIC

THE CONTRACTOR SHALL SCHEDULE HIS SEQUENCE OF OPERATIONS TO PERMIT THE CONSTRUCTION OF THIS SECTION WITH THE LEAST INCONVENIENCE TO THE TRAVELING PUBLIC. THE CONTRACTOR'S SCHEDULE SHALL REFLECT THE FOLLOWING REQUIREMENTS AND SEQUENCE OF CONSTRUCTION. THESE REQUIREMENTS FOLLOW THE SUGGESTED TRAFFIC CONTROL PLAN INCLUDED IN THE DRAWINGS.

- 1. JERICHO ROAD MAY BE COMPLETELY CLOSED TO TRAFFIC FOR THE DURATION SPECIFIED IN THE CONTRACT DOCUMENTS.
- 2. ACCESS TO FIELD AND PRIVATE ENTRANCES SHALL REMAIN OPEN AT ALL TIMES. ON PROPERTIES THAT HAVE MORE THAN ONE ACCESS, ONE ENTRANCE MAY BE TEMPORARILY CLOSED. HOWEVER, VEHICULAR ACCESS MUST REMAIN OPEN TO TRAFFIC FOR THE OPPOSITE ENTRANCE. WHEN IT IS NECESSARY TO CLOSE AN ENTRANCE, THE CONTRACTOR SHALL COORDINATE WITH THE RESIDENT ENGINEER AND THE PROPERTY OWNER FORTY-EIGHT (48) HOURS IN ADVANCE OF THE WORK. IN ALL CASES, THE ENTRANCE SHALL BE OPEN AT THE END OF THE WORKDAY.

TRAILER MOUNTED ARROW BOARD

UNLESS OTHERWISE REQUIRED BY A SPECIFIED TRAFFIC CONTROL STANDARD, THE USE OF A TRAILER MOUNTED ARROW BOARD(S) ARE NOT ANTICIPATED FOR THIS PROJECT.

SEQUENCE OF CONSTRUCTION

IN GENERAL, THE STAGING OF CONSTRUCTION FOR THIS SECTION SHALL BE AS FOLLOWS: MAJOR WORK ITEMS - STAGE 1 JERICHO ROAD

- COORDINATE UTILITY RELOCATES.
- SET UP CHANGEABLE MESSAGE BOARD.
- SET UP DETOUR AS DETAILED IN THE PLANS.
- SET UP TEMPORARY EROSION CONTROL MEASURES.
- REMOVE EXISTING VEGETATION, PAVEMENTS, AND BRIDGE STRUCTURE (SEE REMOVAL PLANS SHEETS).
- CONSTRUCT THE PROPOSED BRIDGE, SUBGRADE, AGGREGATE BASE COURSES, PAVEMENTS (TO SURFACE), STROM SEWERS, GUARD RAILS AND UNDERDRAINS.
- CONSTRUCT GUARDRAILS AND SIGNAGE.

MAJOR WORK ITEMS - STAGE 2 - RESTORATION


- THESE ITEMS MAY TAKE PLACE AFTER THE ROADWAY IS OPEN TO TRAFFIC.
- PLACE PERMANENT RESTORATION.
- PLACE PERMANENT PAVEMENT MARKINGS.
- FINALIZE PUNCH LIST AND SITE CLEANUP.


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	WILLS BURKE KELSEY ASSOCIATES LTD.	I
WBK	116 West Main Street, Suite 201 St. Charles, Illinois 60174	l
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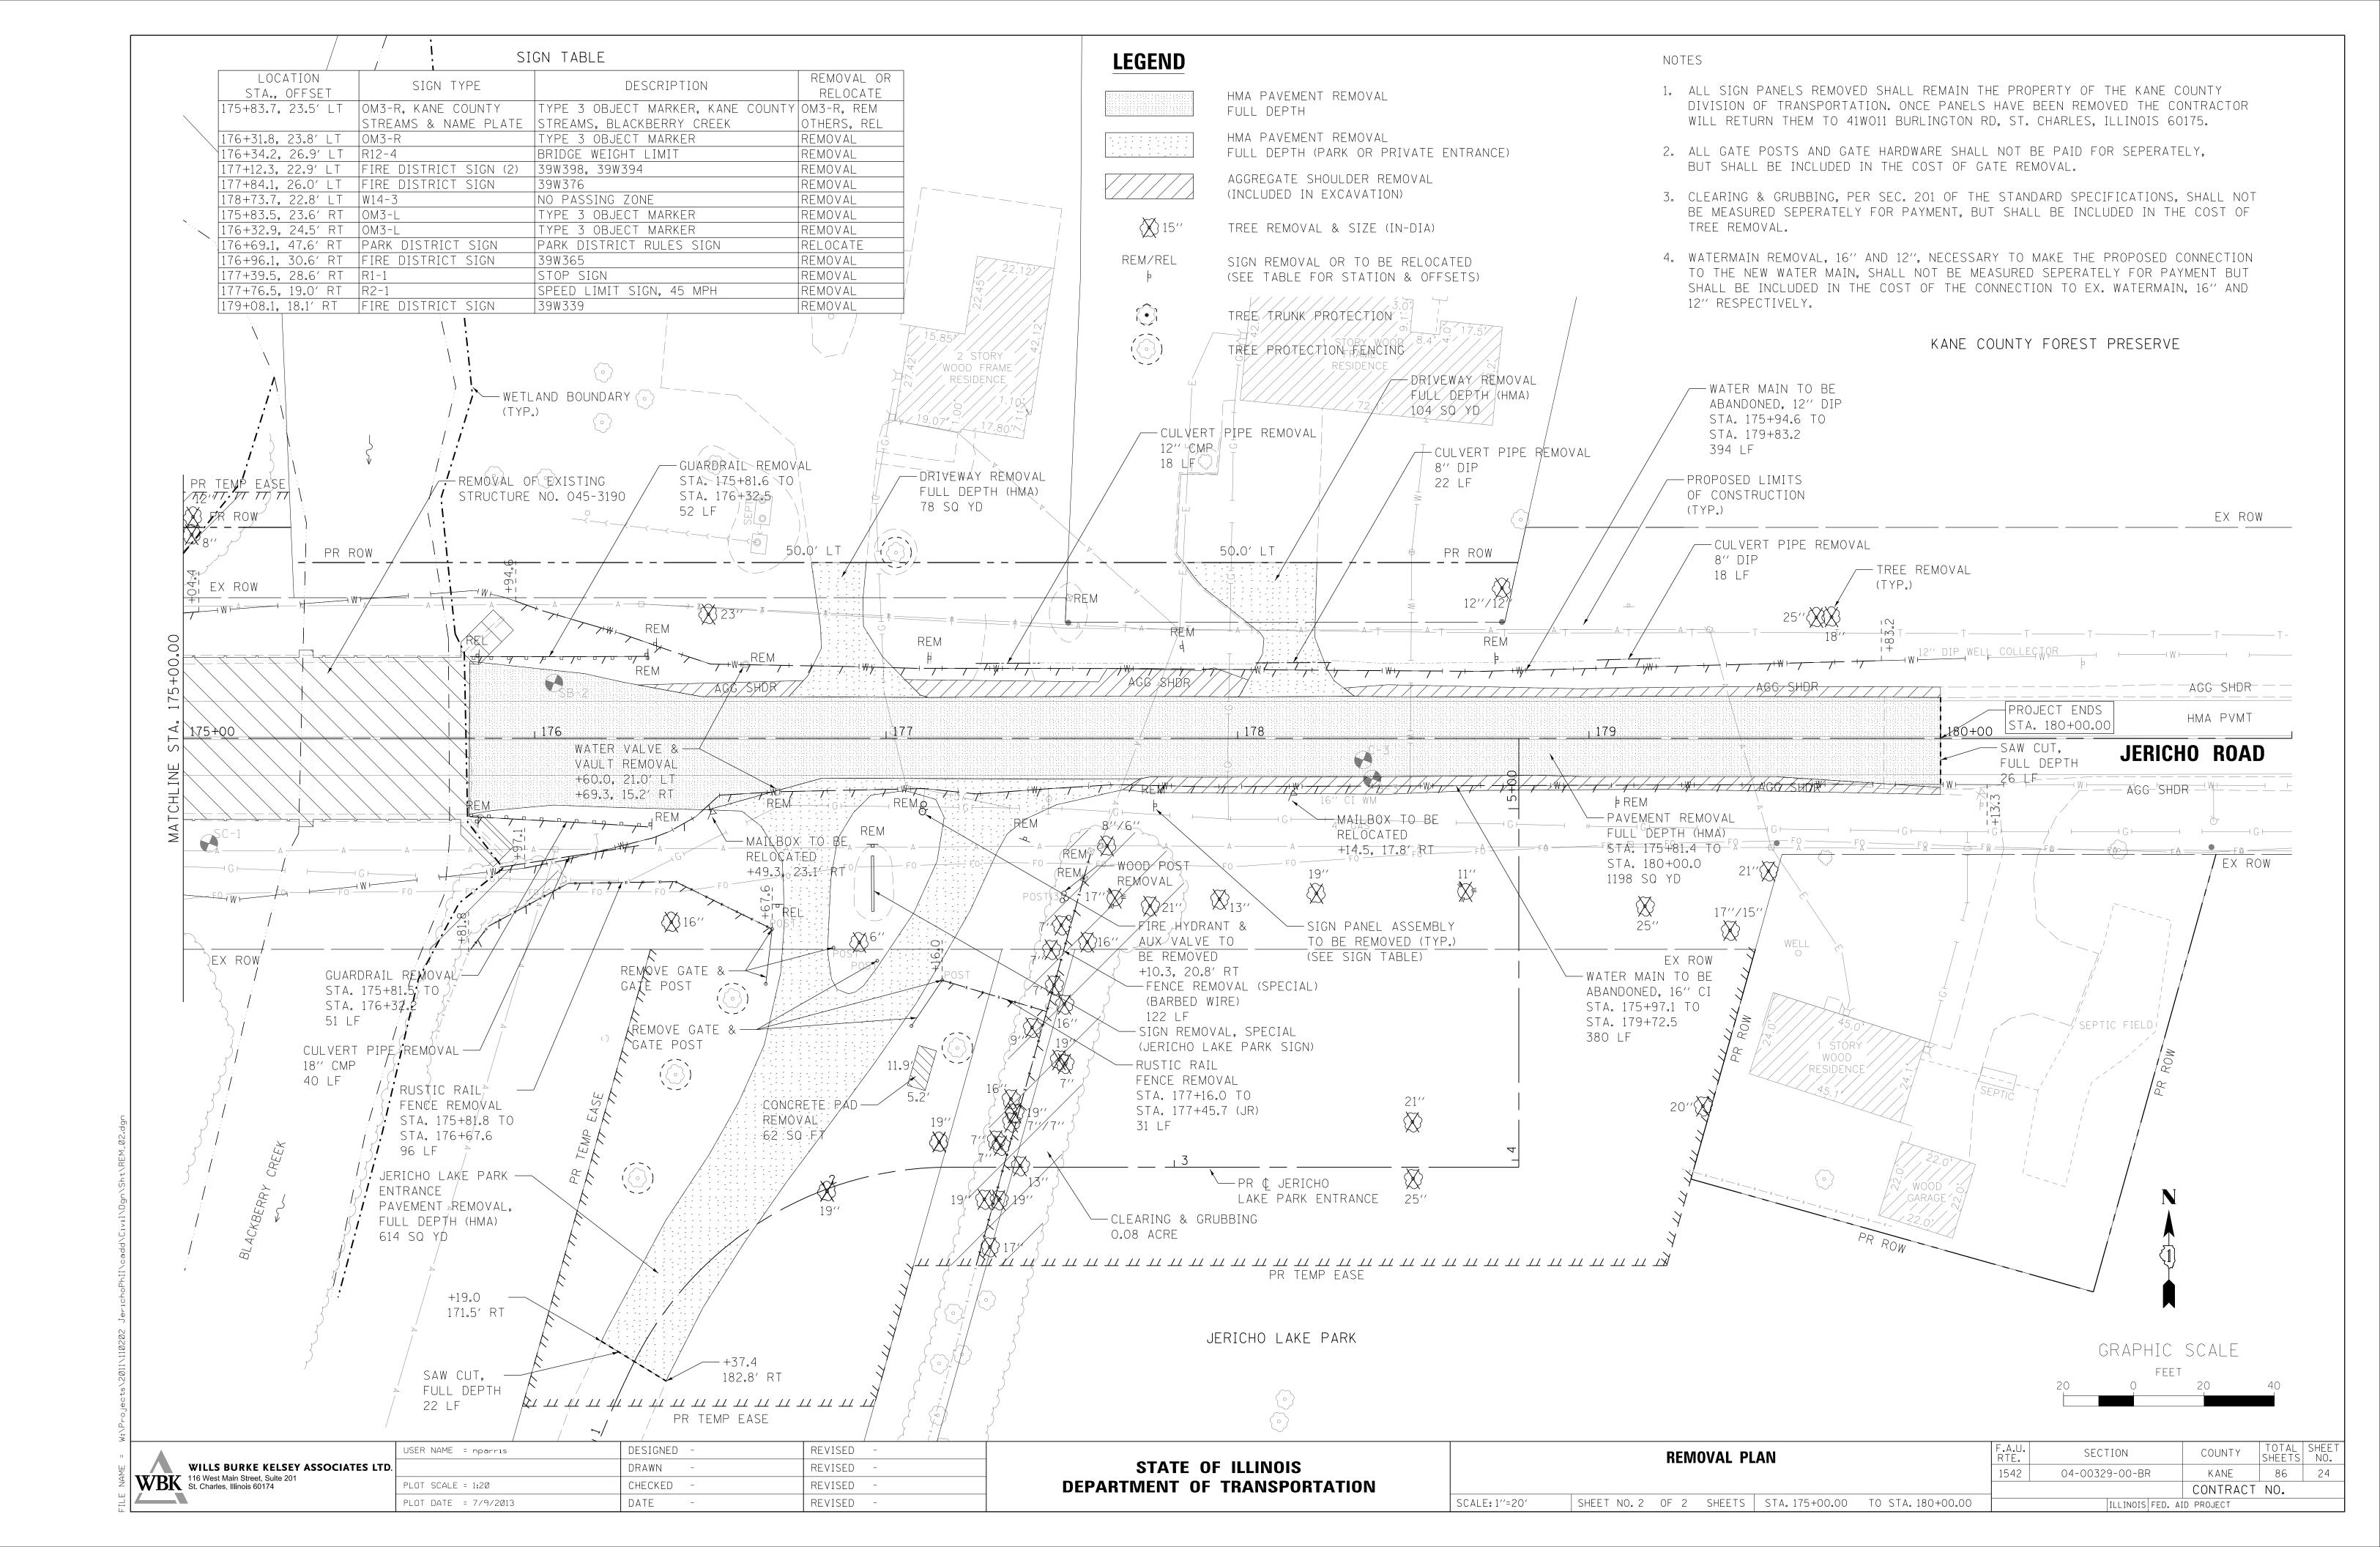
USER NAME = nparris	DESIGNED -	REVISED -
	DRAWN - KMA	REVISED -
PLOT SCALE = 1:500	CHECKED -	REVISED -
PLOT DATE = 7/9/2013	DATE -	REVISED -


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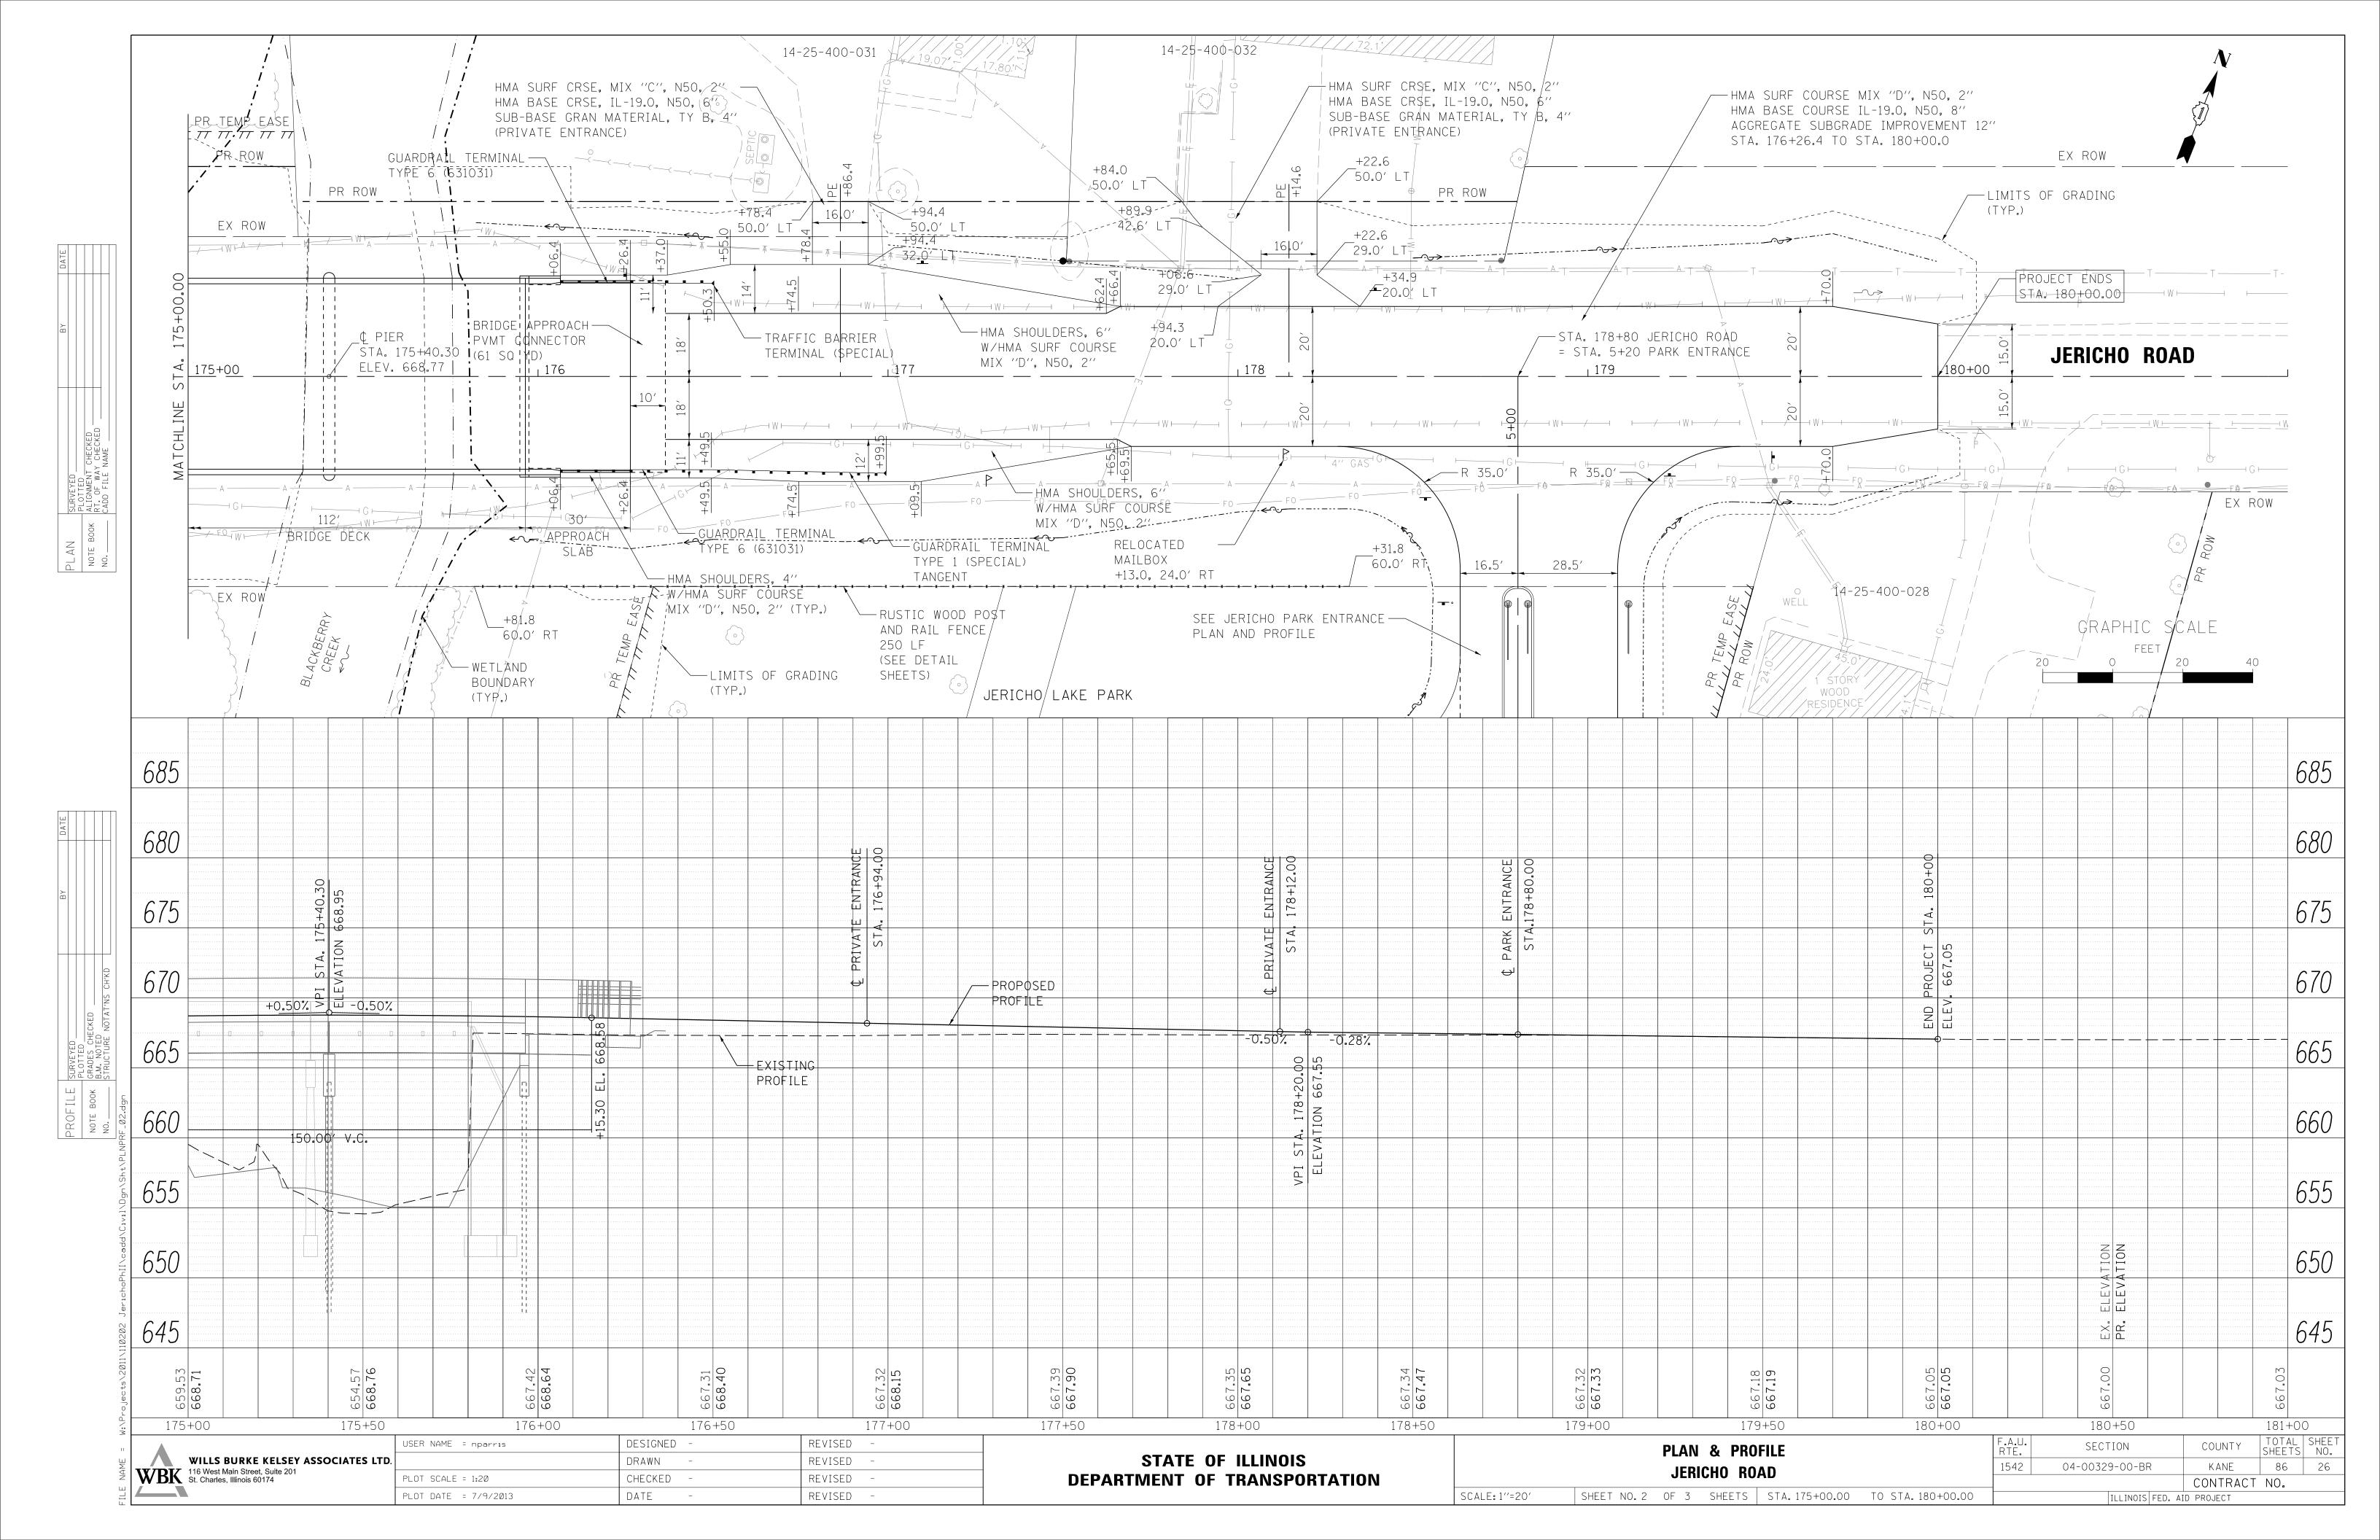
MAINTENANCE OF TRAFFIC		F.A.U. RTE.	SECTION	COUNTY	TOTAL SHEETS	SHE		
JERICHO ROAD DETOUR NOTES			1542	04-00329-00-BR	KANE	86	2	
					CONTRACT	NO.		
SHEET NO. 1	OF 2 SHEETS	STA.	TO STA.		ILLINOIS FED.	AID PROJECT		







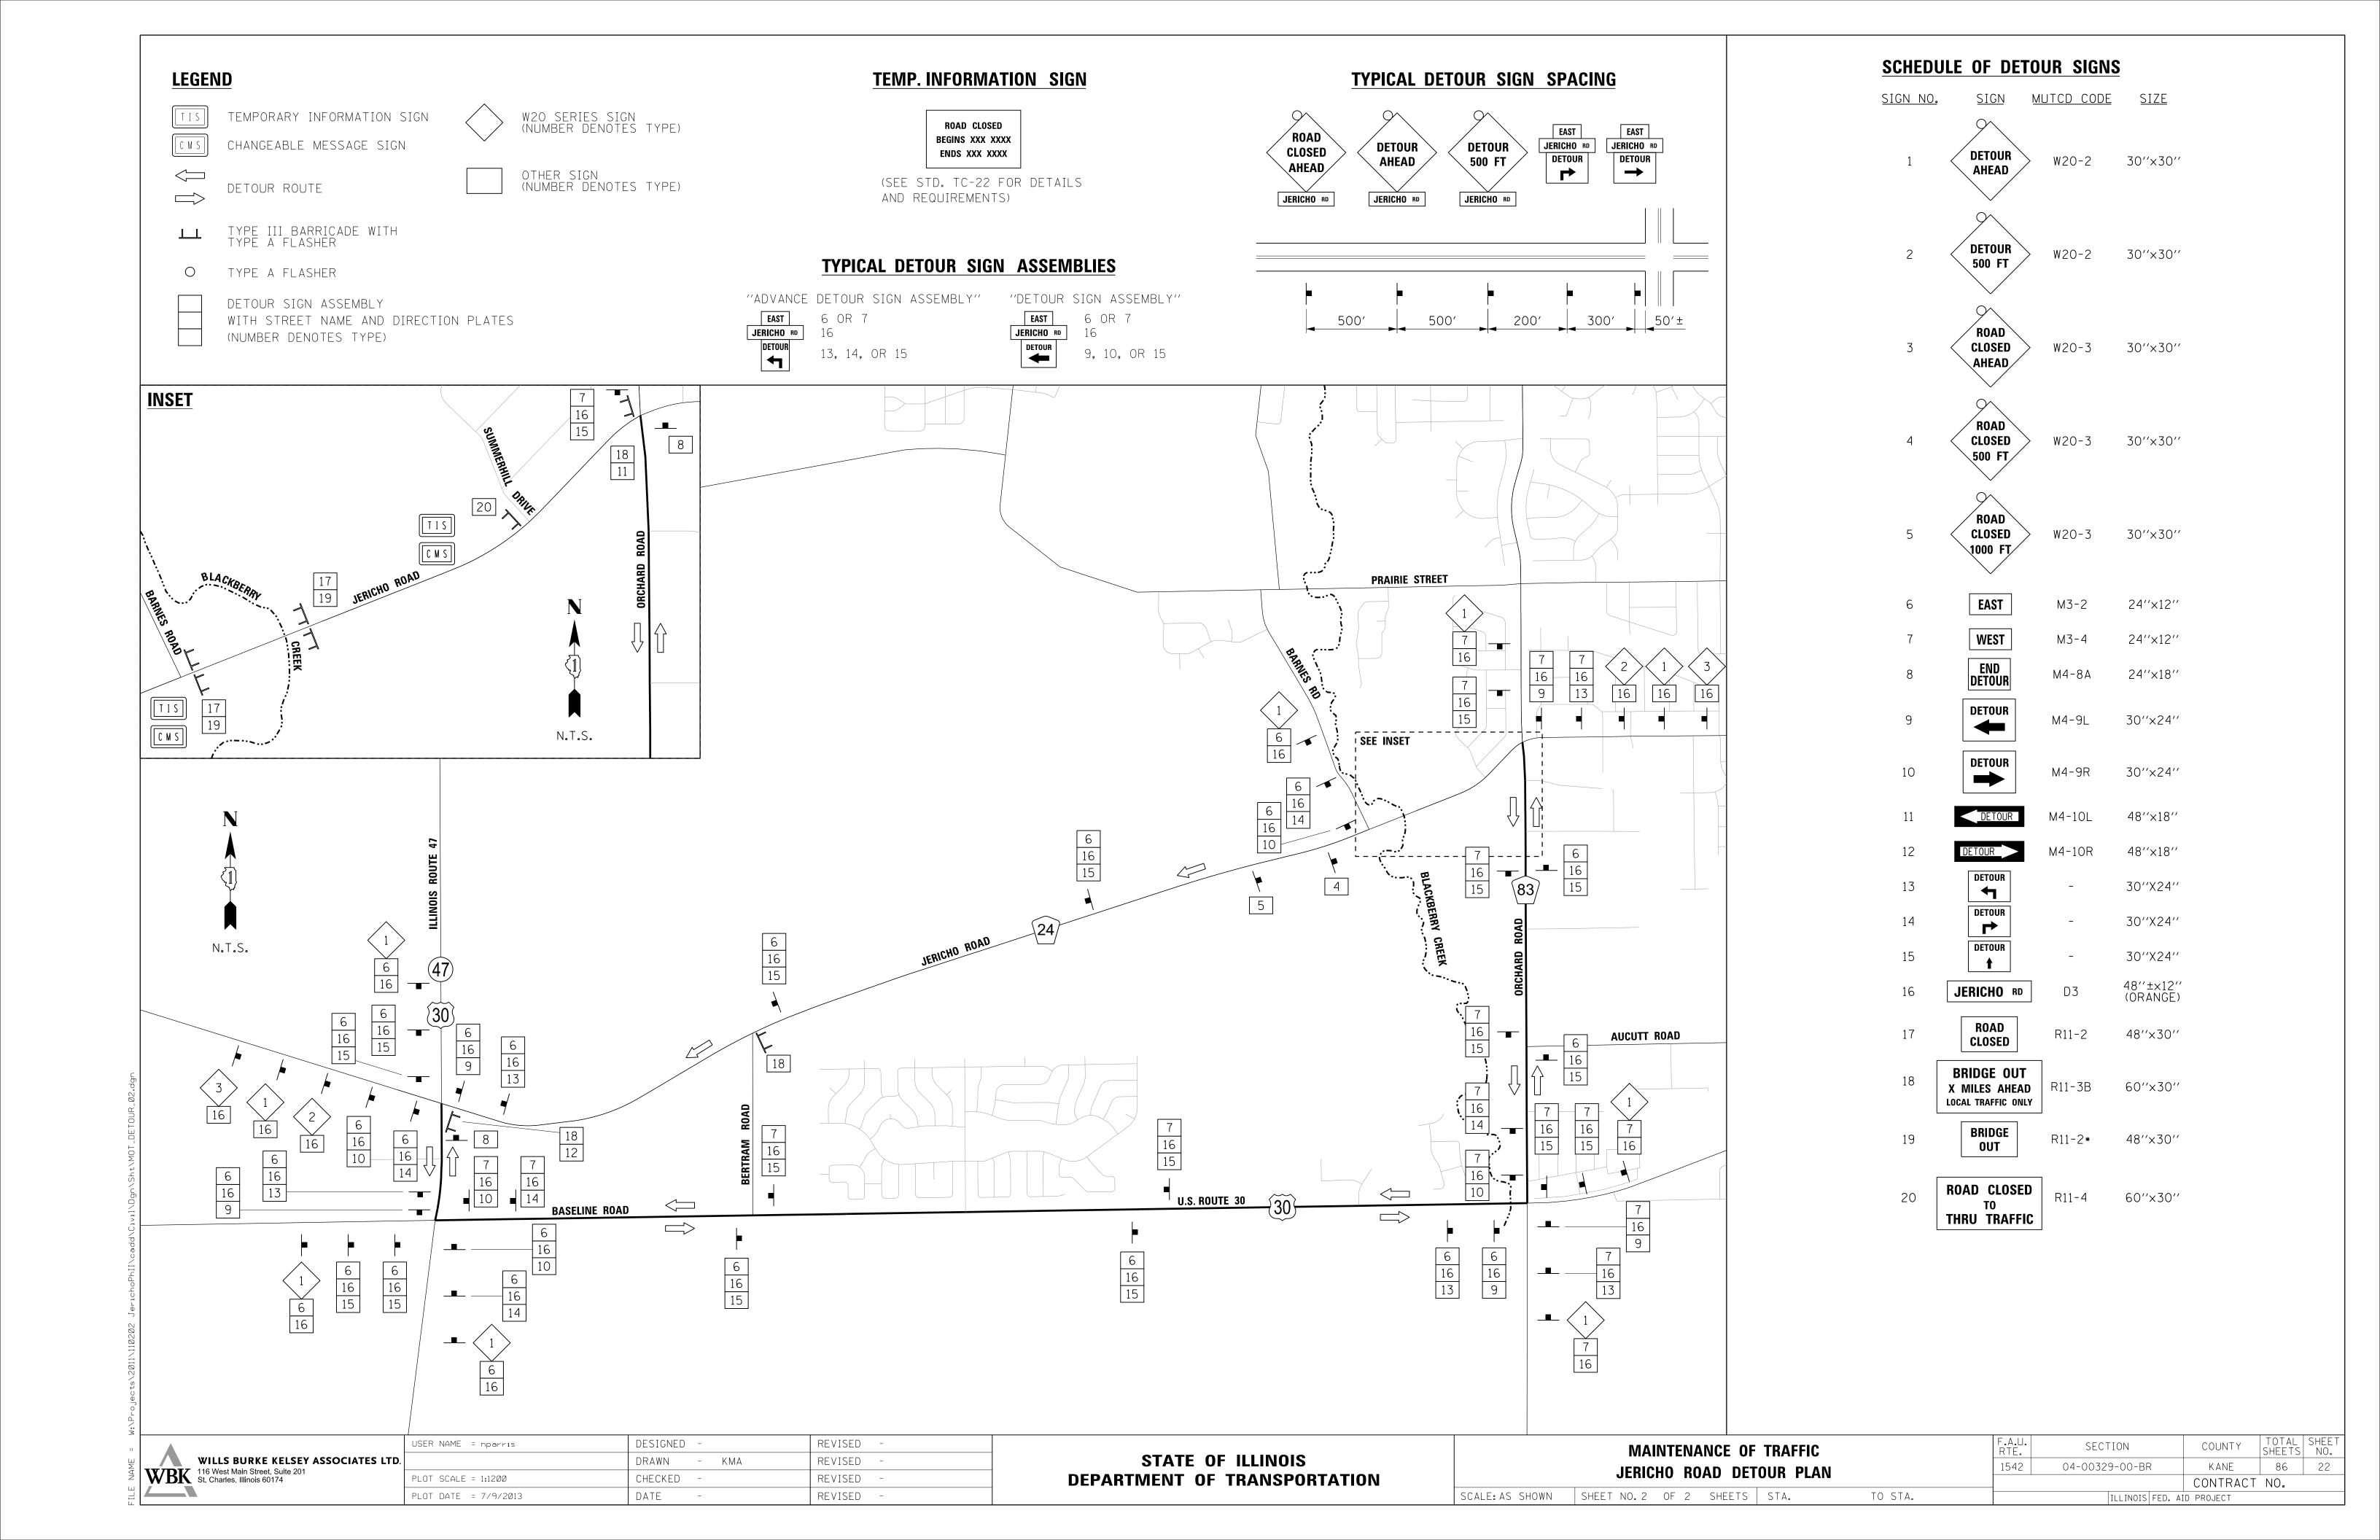


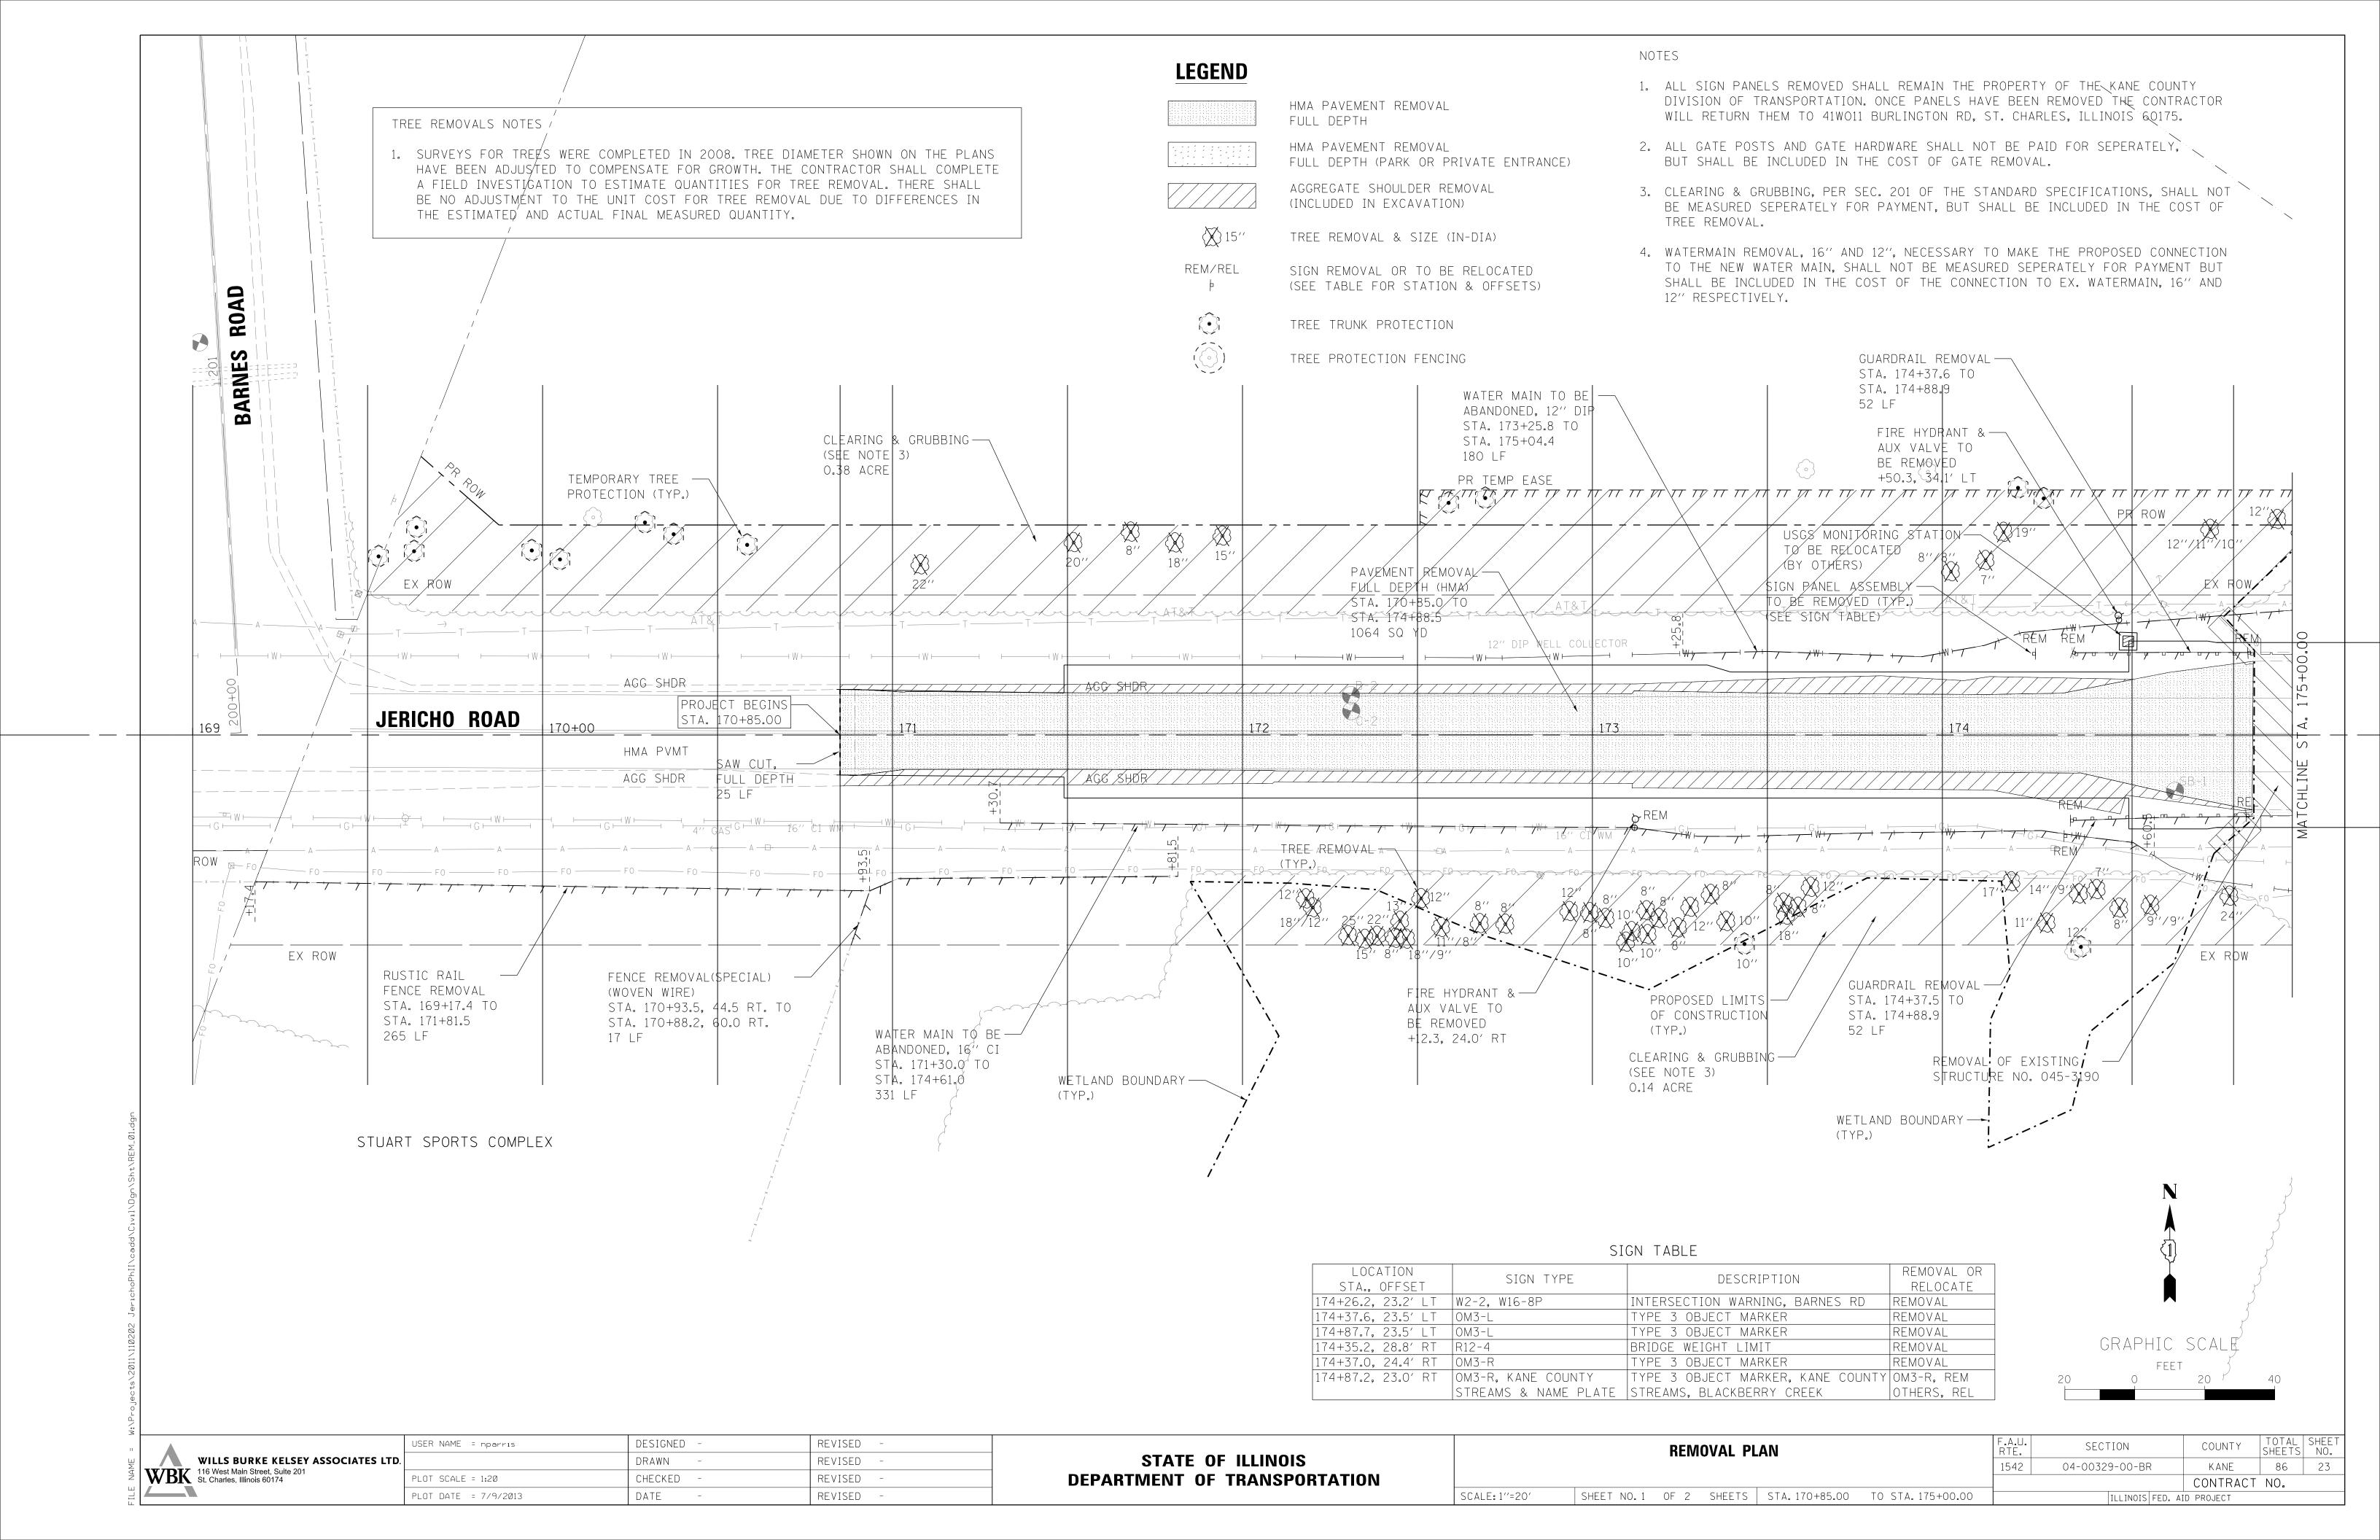

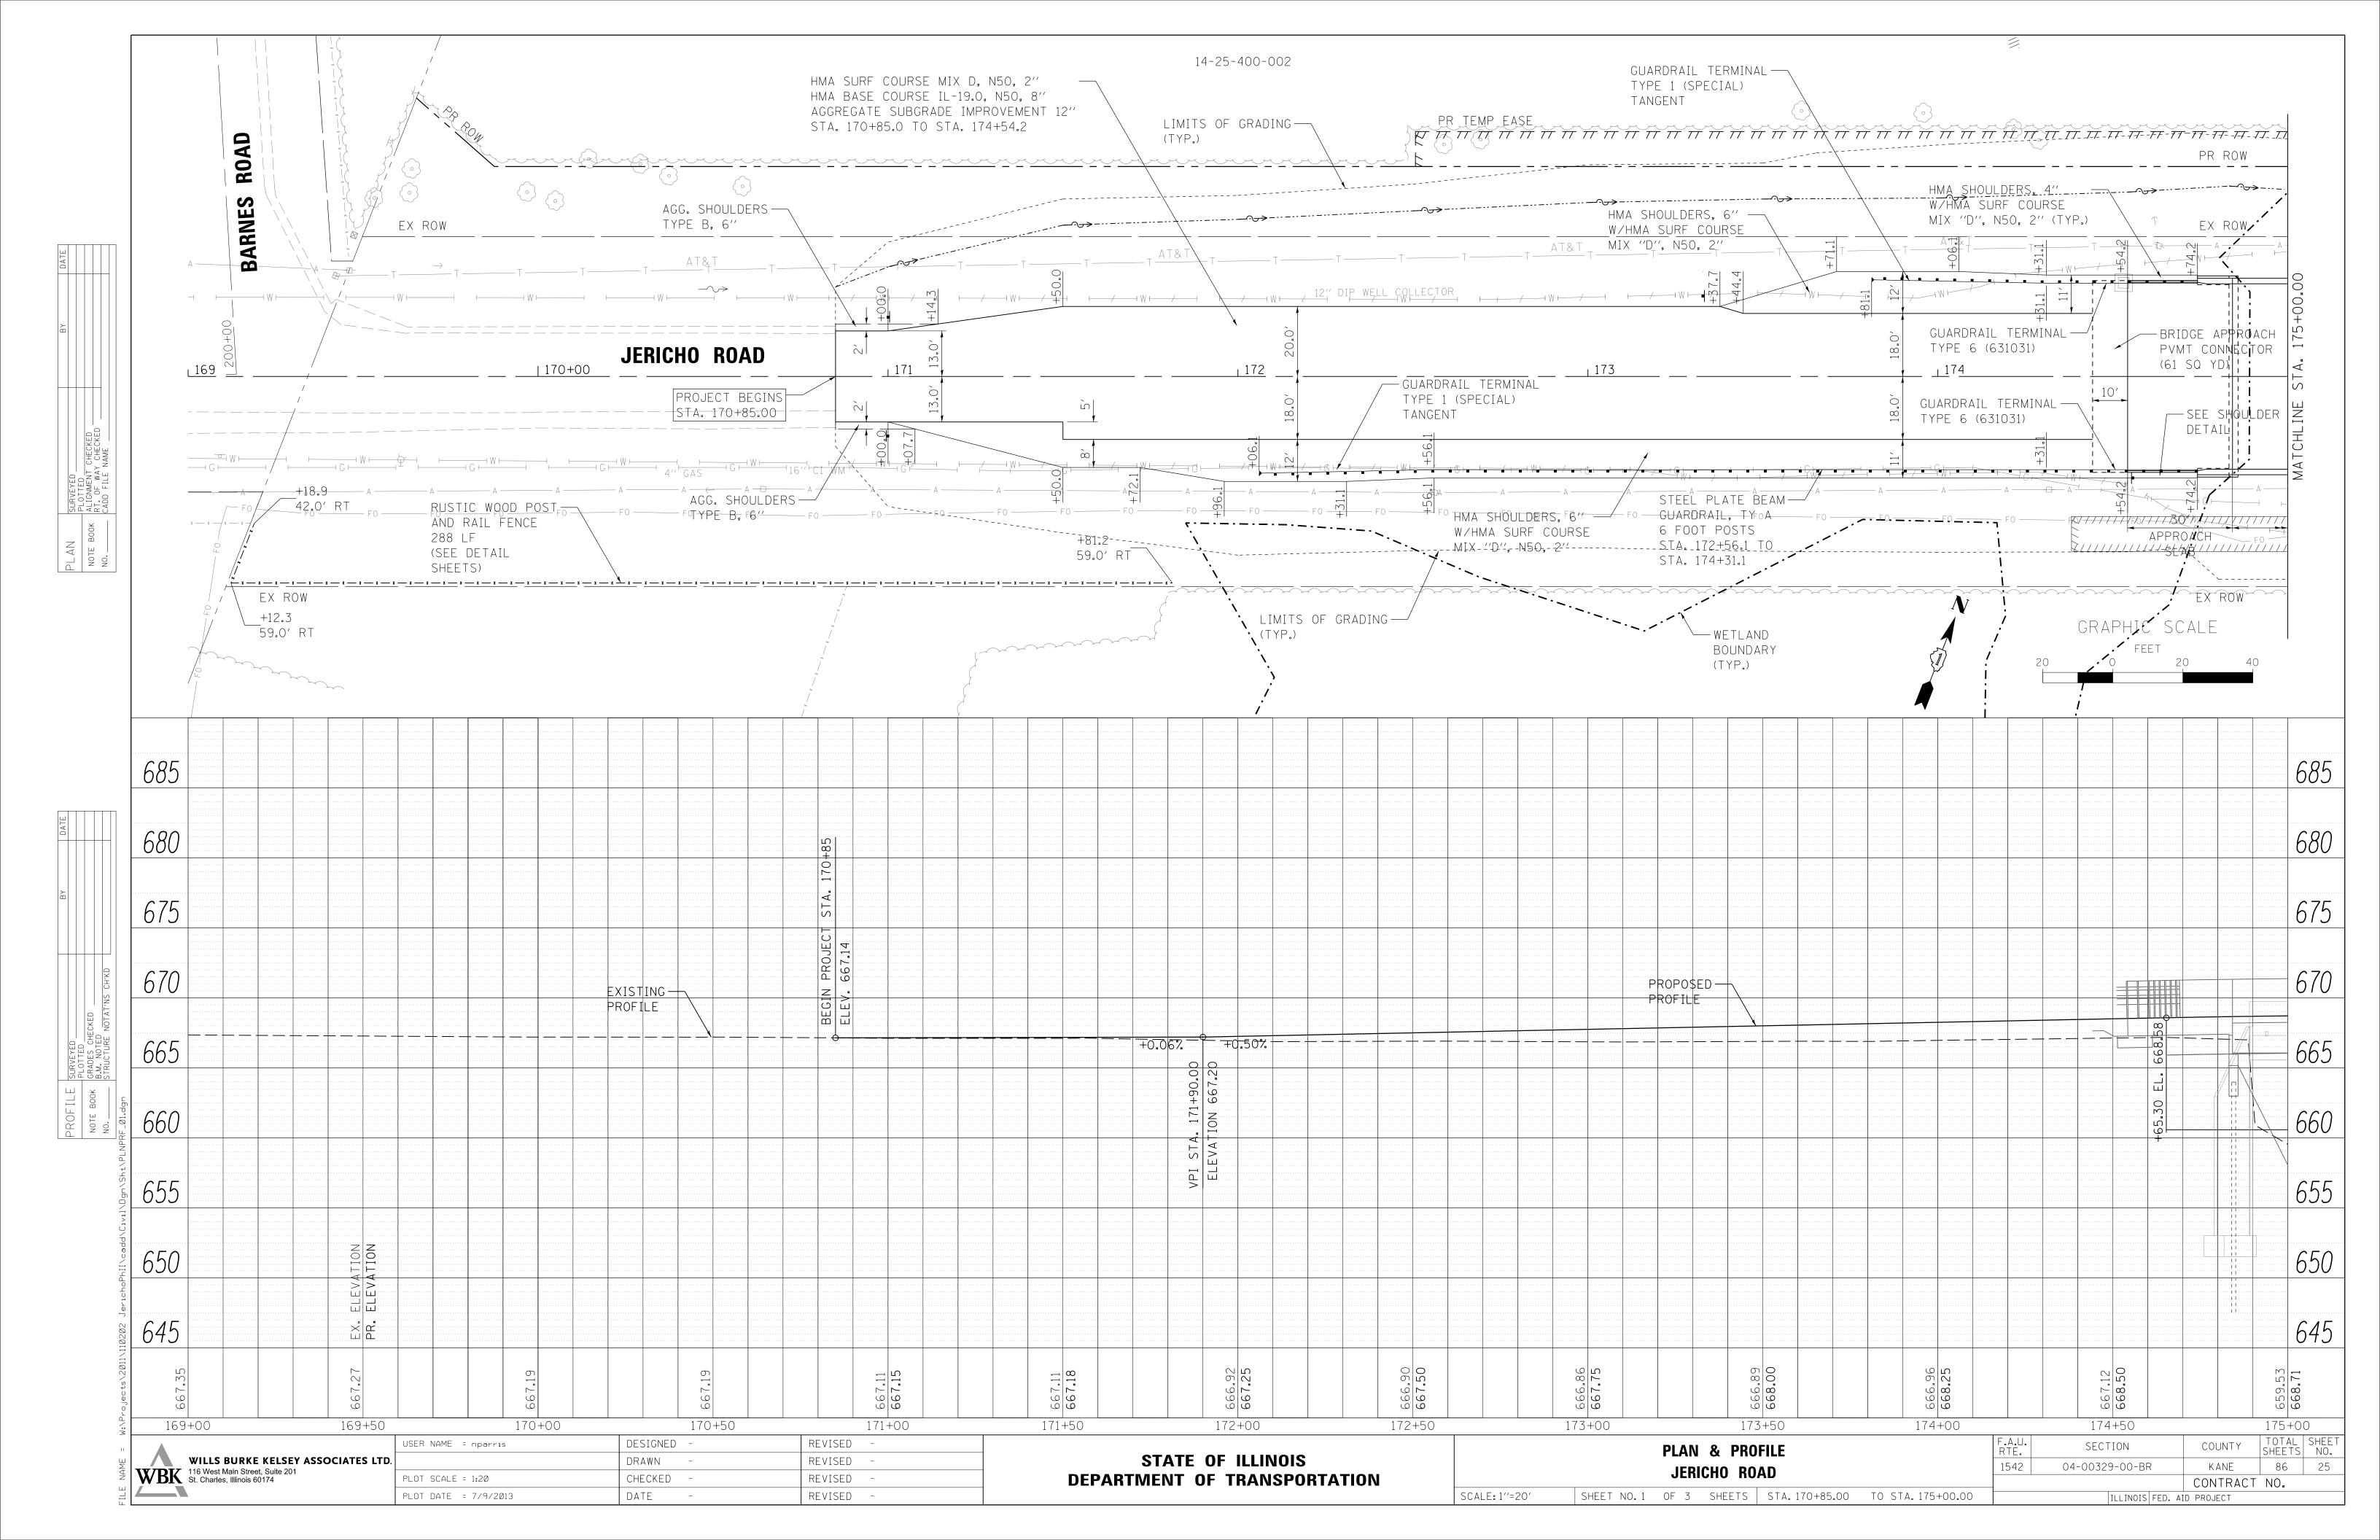

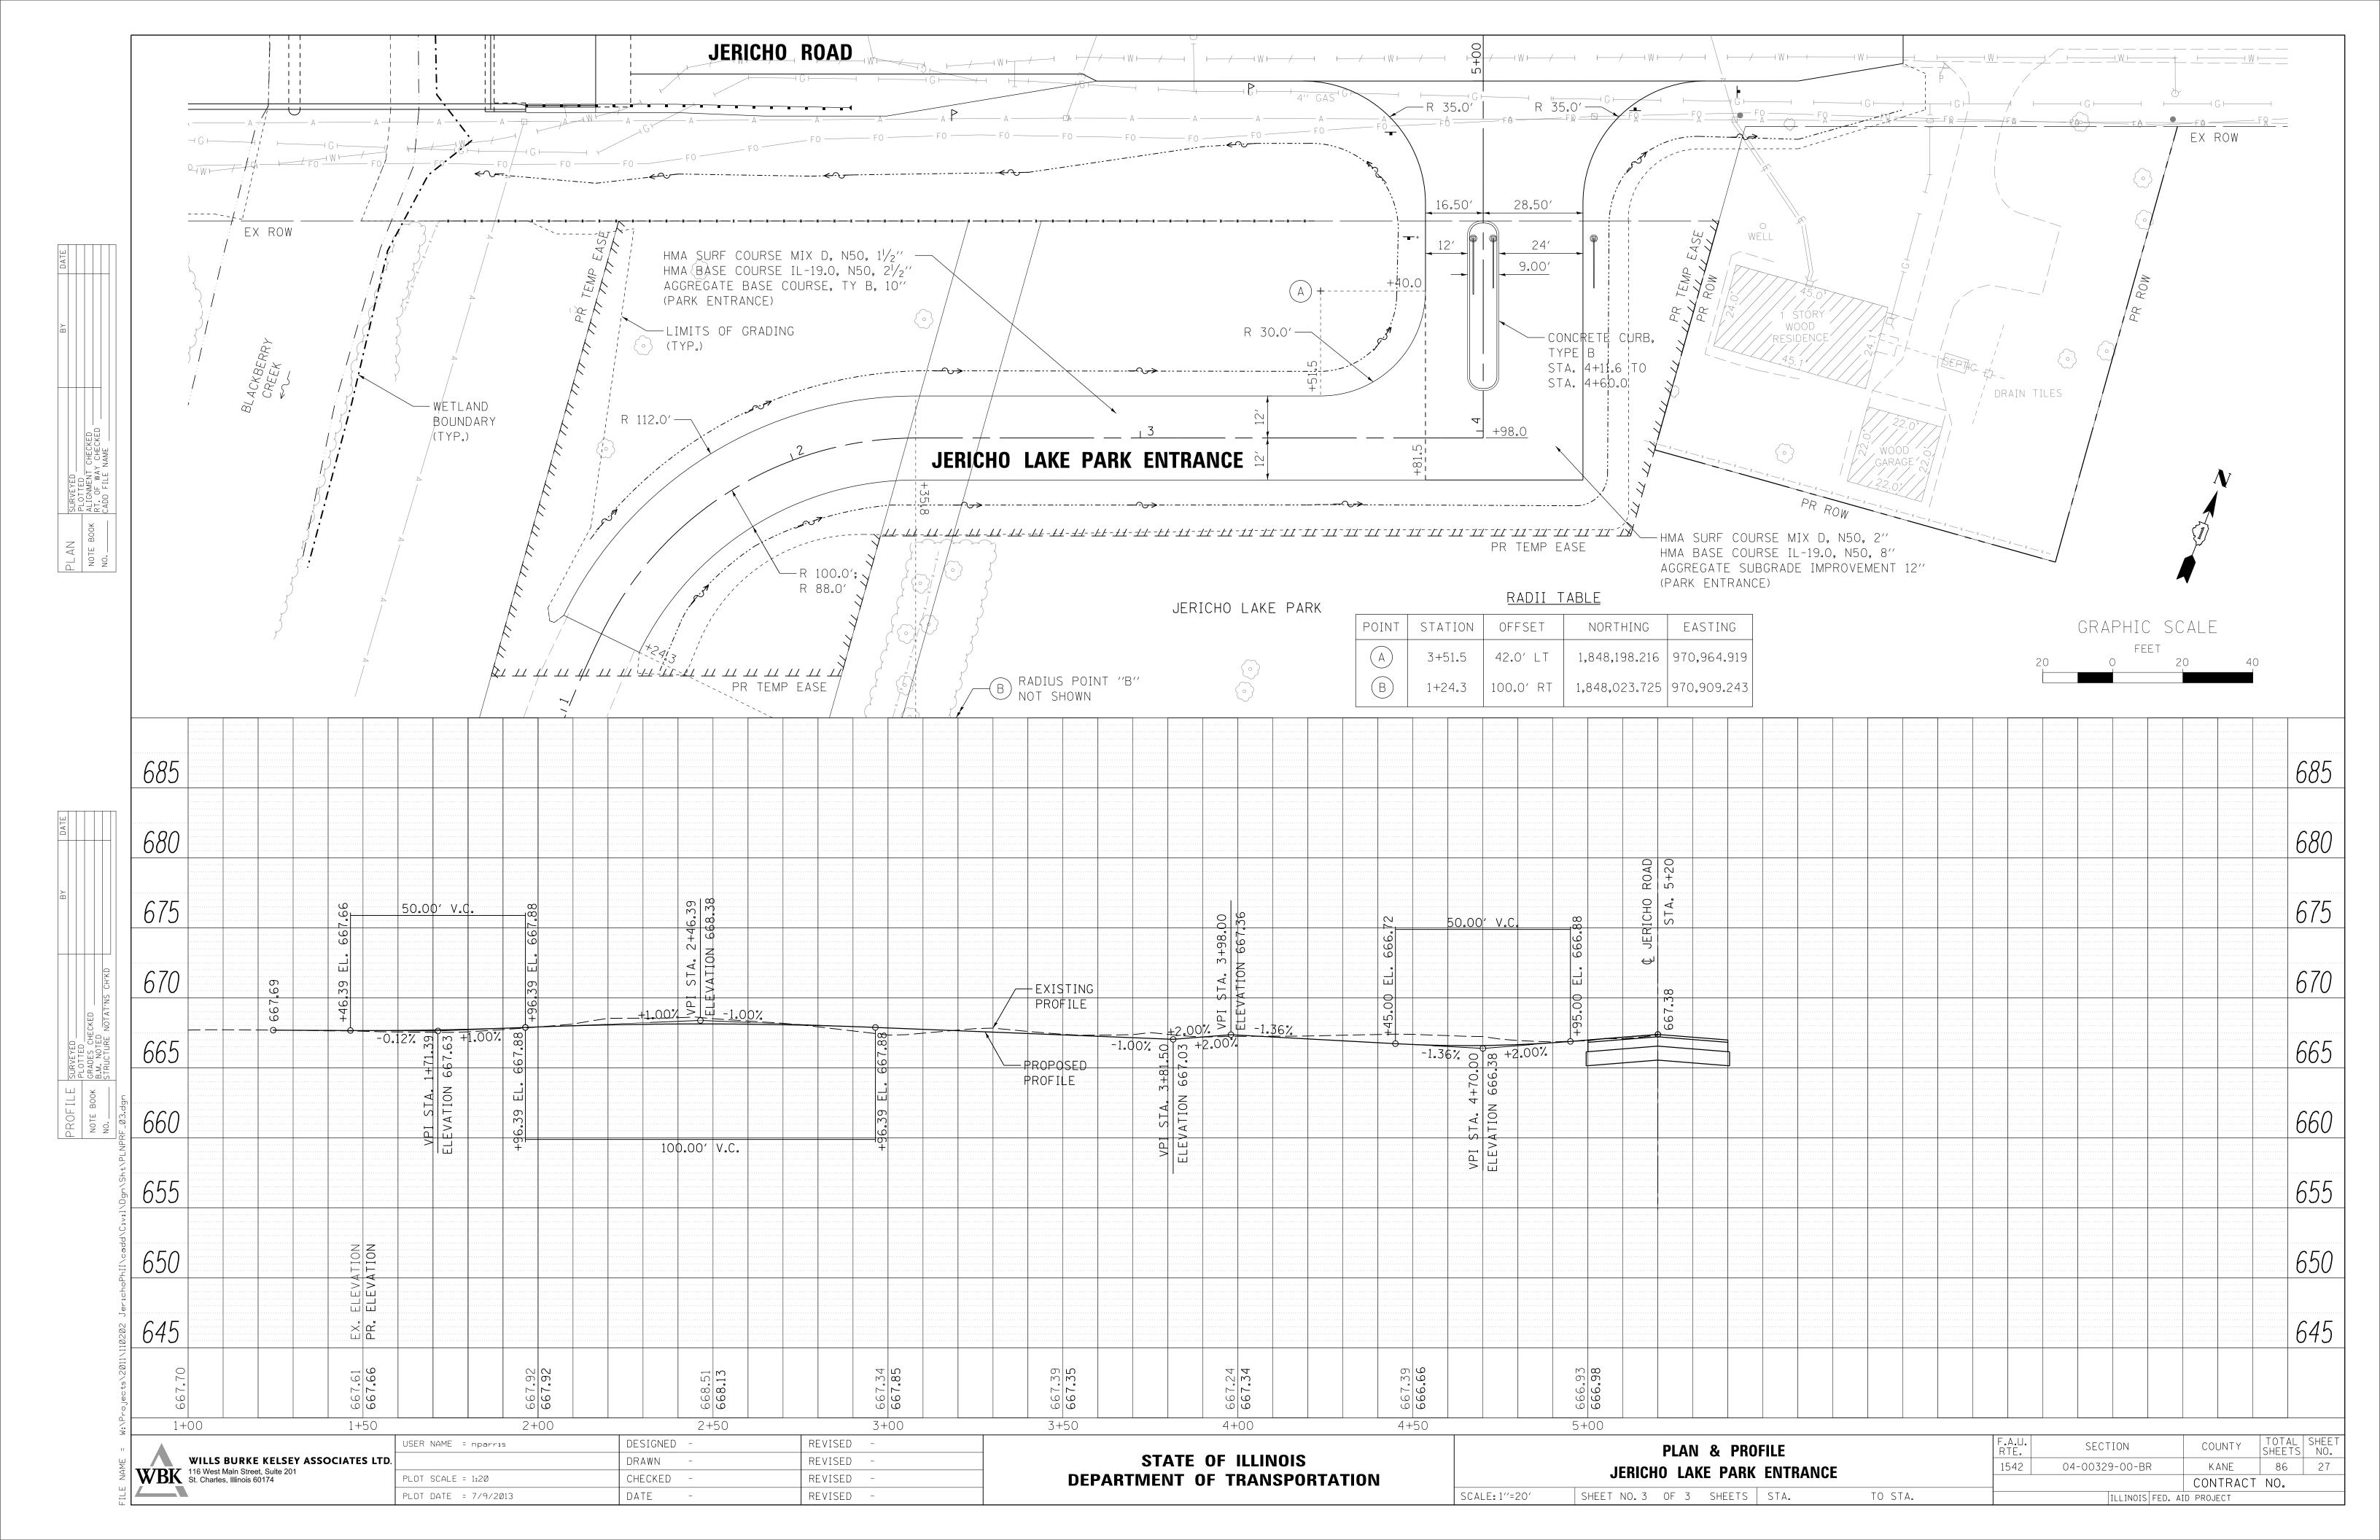

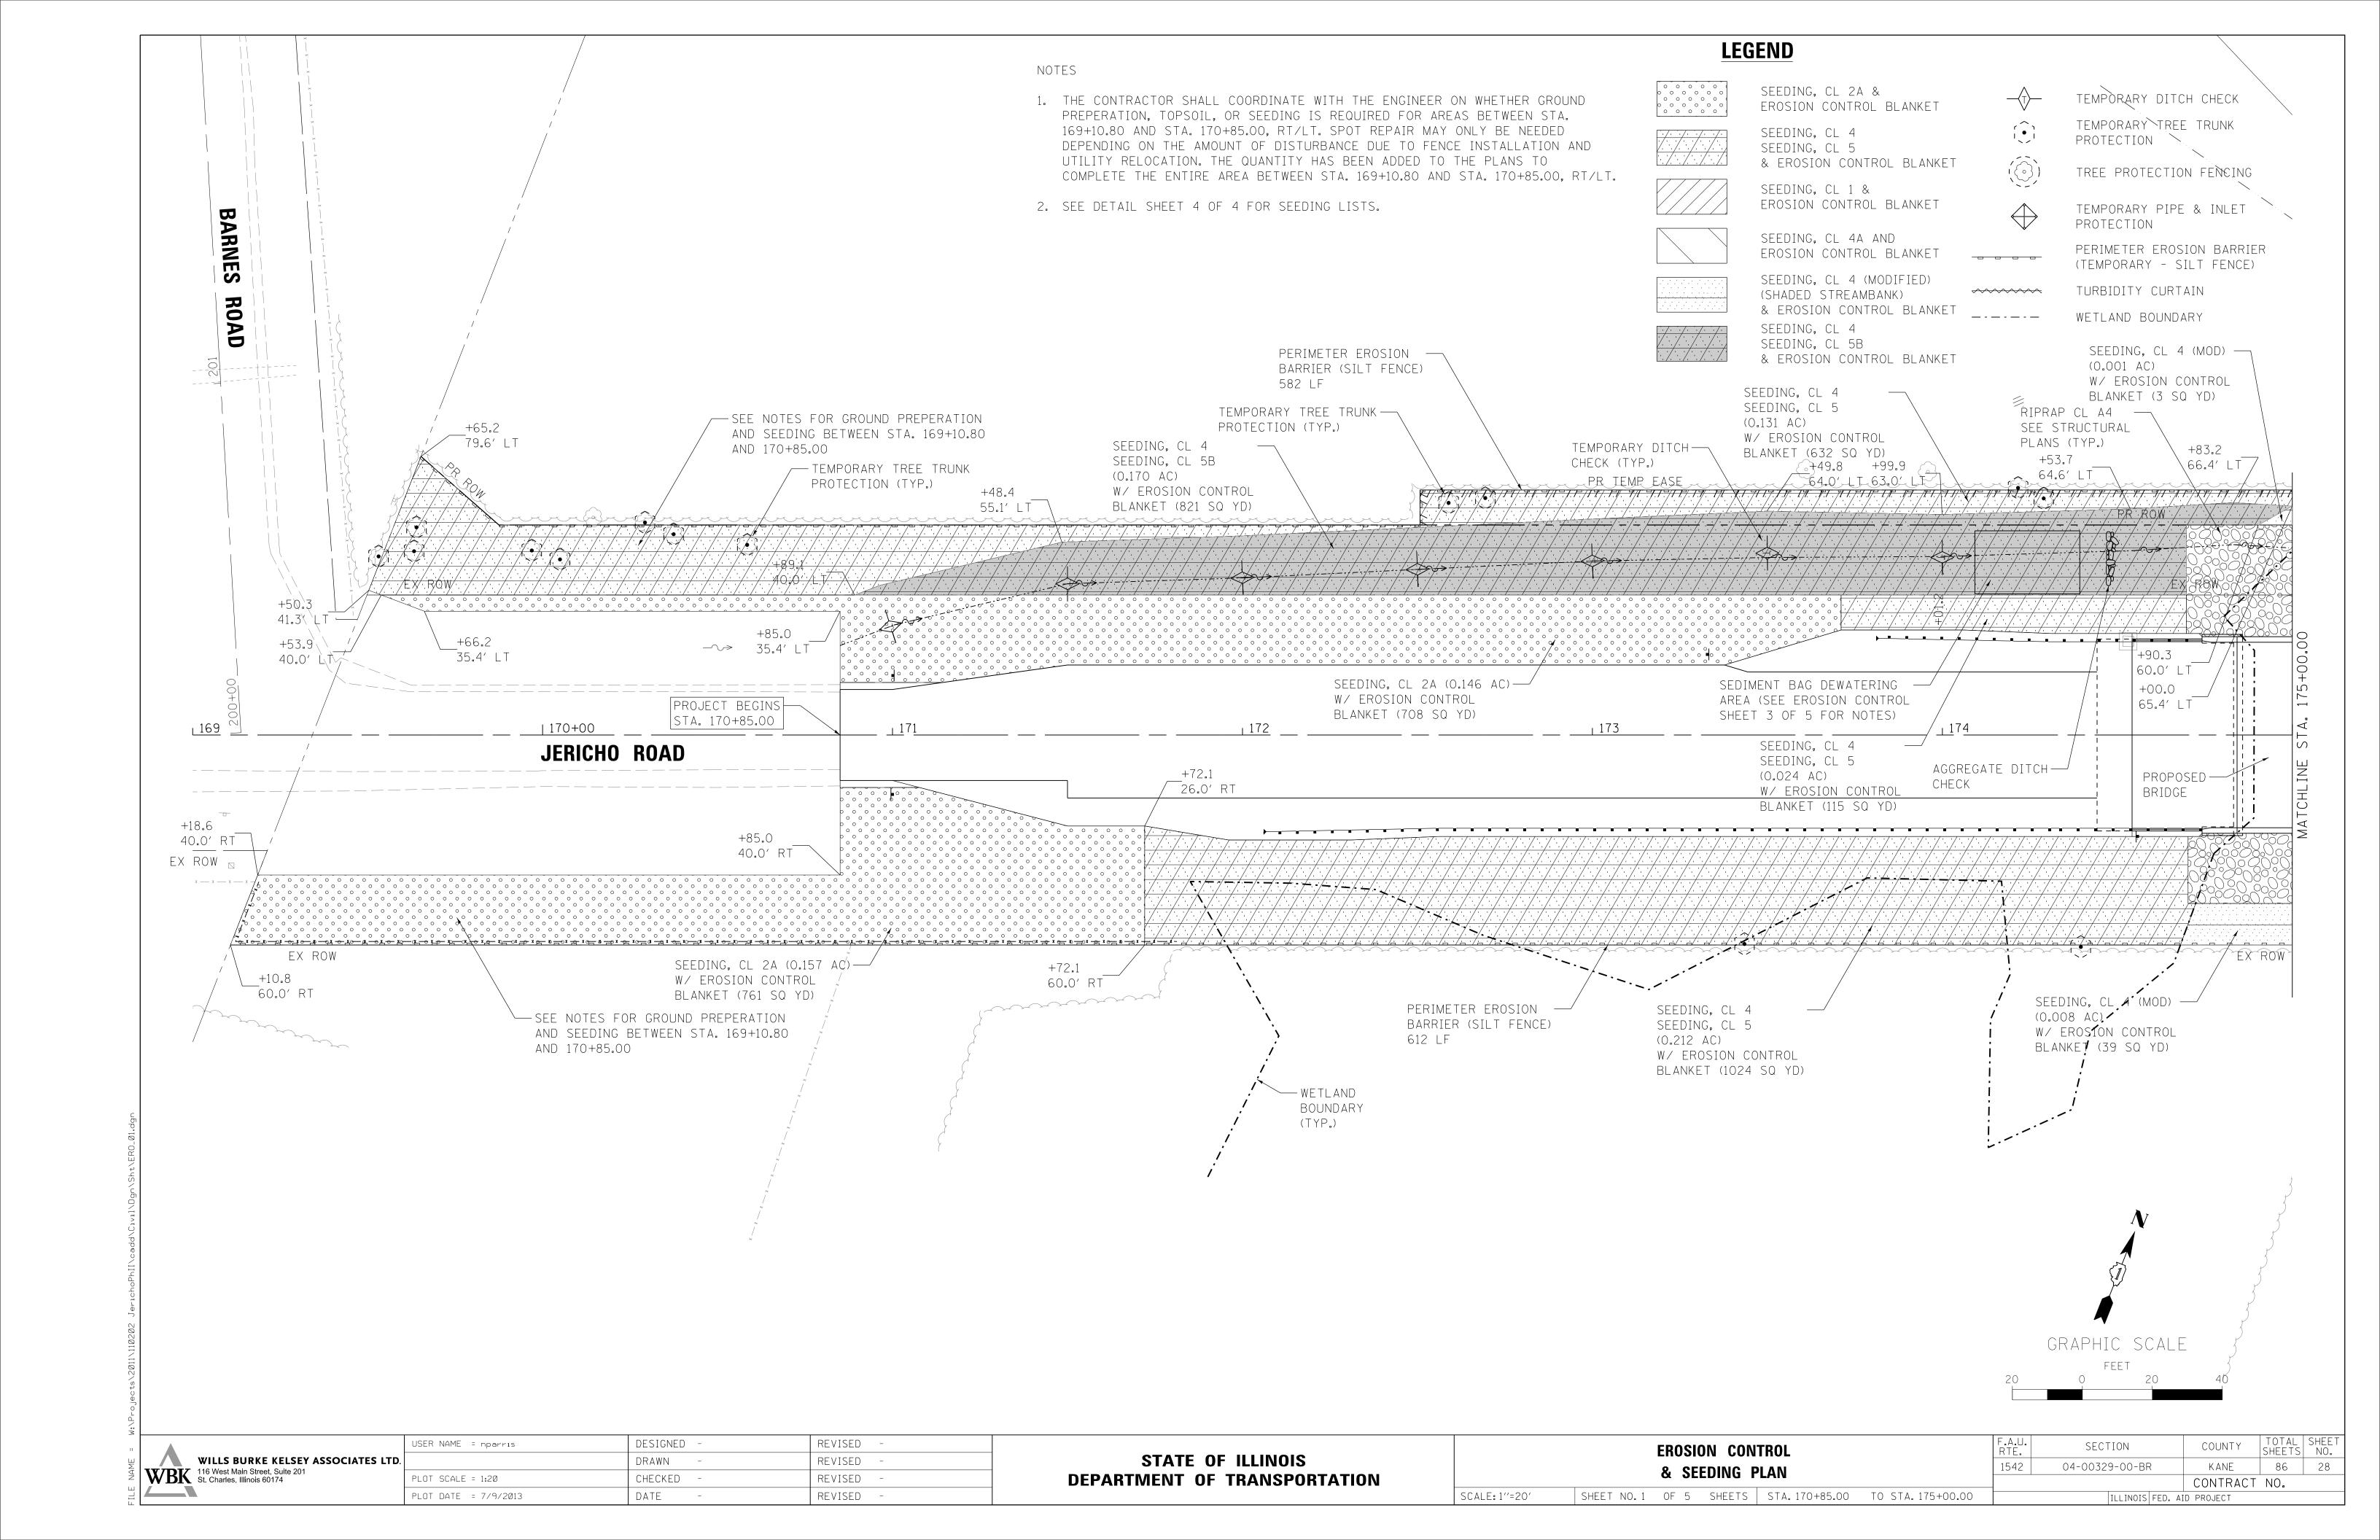

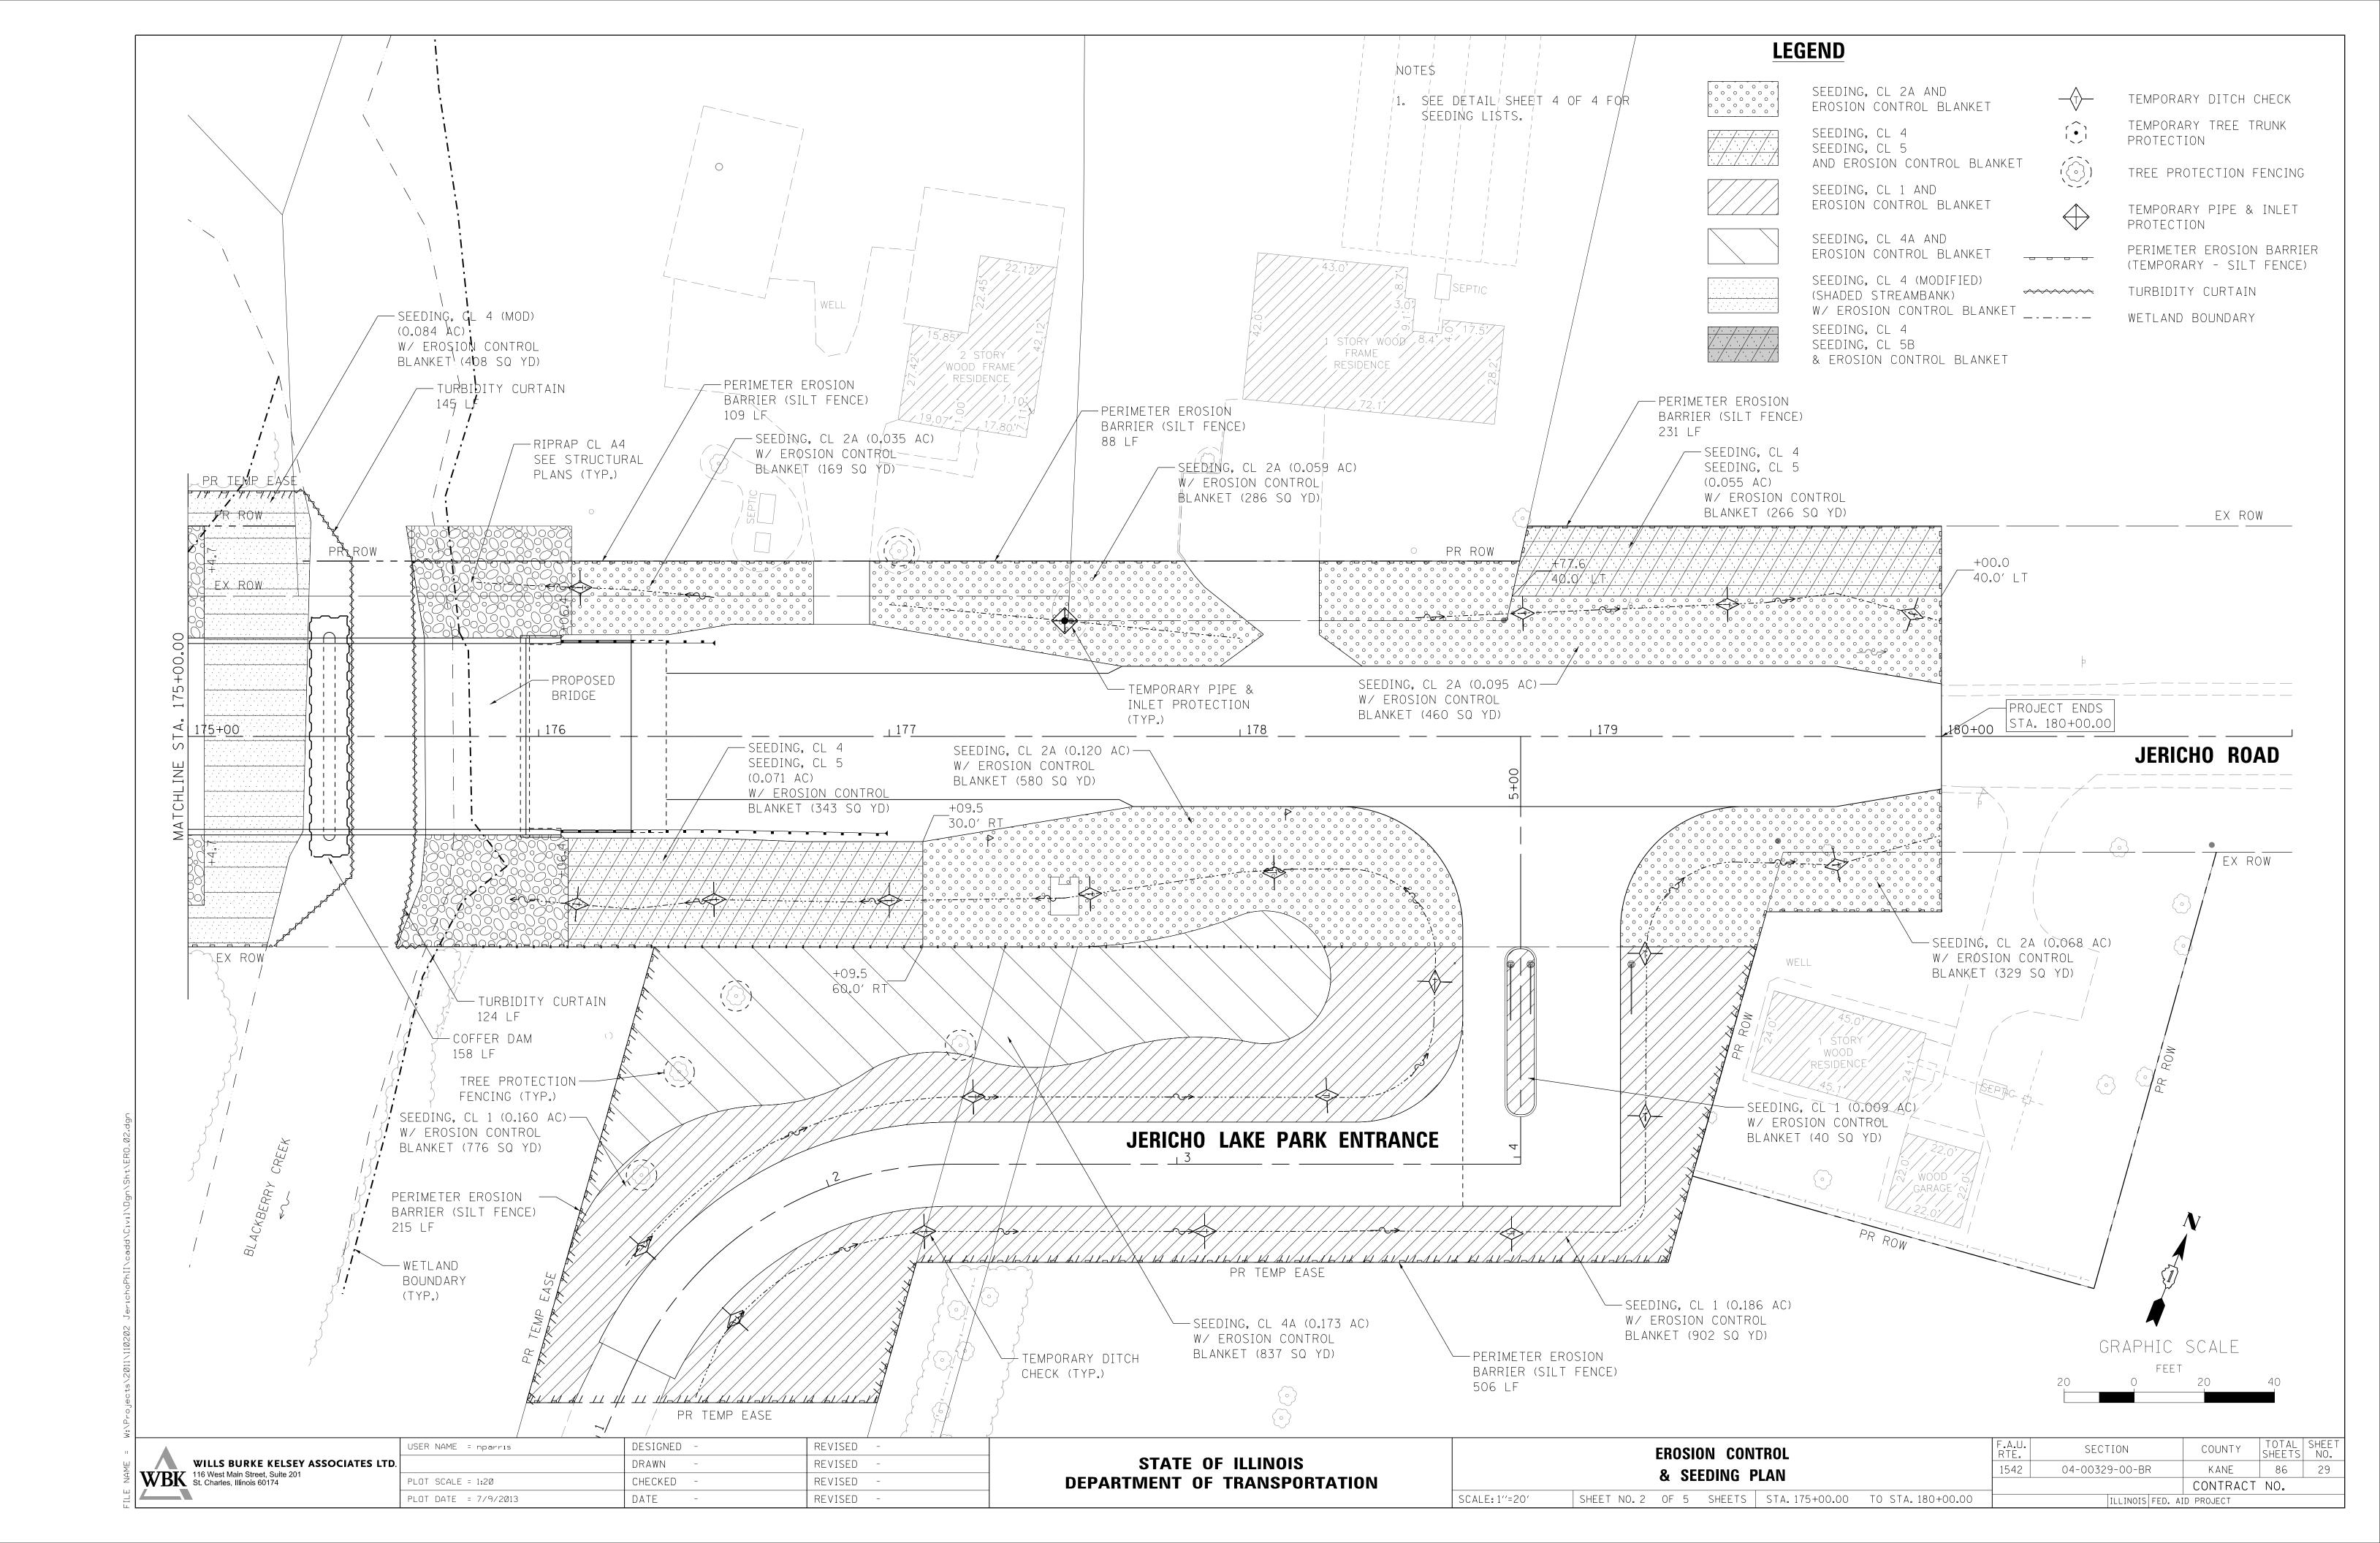

EROSION CONTROL INSPECTION

ALL EROSION CONTROL MEASURES MUST BE INSPECTED WEEKLY AND AFTER EACH $\frac{1}{2}$ " RAIN EVENT.

WINTER SHUT DOWN

A WINTER SHUT DOWN IS NOT ANTICIPATED FOR THIS PROJECT. BUT IN THE EVENT THAT UNAVOIDABLE CIRCUMSTANCE REQUIRE A WINTER SHUT DOWN, THE CONDITION OF THE CONSTRUCTION SITE FOR WINTER SHUTDOWN SHALL BE ADDRESSED EARLY IN THE FALL GROWING SEASON SO THAT SLOPES AND OTHER BARE EARTH AREAS MAY BE STABILIZED WITH TEMPORARY AND/OR PERMANENT VEGETATIVE COVER FOR PROPER EROSION AND SEDIMENT CONTROL. ALL OPEN AREAS THAT ARE TO REMAIN IDLE THROUGHOUT THE WINTER SHALL RECEIVE TEMPORARY EROSION CONTROL MEASURES INCLUDING TEMPORARY SEEDING, MULCHING AND/OR EROSION CONTROL BLANKET PRIOR TO THE END OF THE FALL GROWING SEASON. THE AREAS TO BE WORKED BEYOND THE END OF THE GROWING SEASON MUST INCORPORATE SOIL STABILIZATION MEASURES THAT DO NOT RELY ON VEGETATIVE COVER SUCH AS EROSION CONTROL BLANKET AND HEAVY MULCHING.

TEMPORARY DITCH CHECKS

TEMPORARY DITCH CHECKS WILL BE REQUIRED AT THOSE LOCATIONS WHERE THE CONTRACTORS OPERATIONS REQUIRE TEMPORARY OR PERMENTENT DITCHES. THE LOCATION OF TEMPORARY DITCH CHECKS ARE SHOWN ON THE PLANS. THE EXACT LOCATION MAY REQUIRE FIELD ADJUSTMENT AND WILL BE COORDINATED IN THE FIELD WITH THE ENGINEER. THE QUANTITIES INCLUDE A PLAN ALLOWANCE OF FIVE (5) ADDITIONAL TEMPORARY DITCH CHECKS FOR MAINTENANCE PURPOSES. TEMPORARY DITCH CHECKS SHALL BE CONSTRUCTED AS SPECIFIED IN SECTION 280 OF THE STANDARD SPECIFICATIONS FOR ROAD AND BRIDGE CONSTRUCTION, LATEST EDITION.

PERIMETER EROSION BARRIER (SILT FENCE)

PERIMETER EROSION CONTROL BARRIER (SILT FENCE) SHALL BE PLACED AT THE LOCATIONS SHOWN ON THE PLANS. THE PERIMETER EROSION CONTROL BARRIER SHALL BE CONSTRUCTED AS DETAIL ON IDOT STANDARD 280001 AND AS SPECIFIED IN SECTION 280 OF THE STANDARD SPECIFICATIONS FOR ROAD AND BRIDGE CONSTRUCTION, LATEST EDITION.

STOCK PILE LOCATIONS AND PROTECTING STOCK PILE AREAS

STOCK PILES SHOULD NOT BE PLACED IN OR NEAR CRITICAL AREAS, OR AREAS THAT HAVE HIGH POTENTIAL FOR CONTRIBUTING SEDIMENTS TO STROMWATER FACILTIES.

CONTRACTOR MAY OPT TO STOCK PILE MATERIAL. STAGING OF THE PROJECT IS AT HIS DISCRETION OF THE CONTRACTOR AND COORDINATION OF STOCK PILES WILL BE WITH KANE COUNTY DIVISION OF TRANSPORTATION (KDOT) AND KANE-DUPAGE SOIL AND WATER CONSERVATION DISTRICT (KDSWCD). STOCKPILES OF SOIL AND OTHER CONSTRUCTION MATERIALS TO REMAIN IN PLACE MORE THAN THREE (3) DAYS SHALL BE FURNISHED WITH EROSION AND SEDIMENT CONTROL MEASURES (I.E. PERIMETER SILT FENCE). STOCKPILES, NOT BEING ACTIVELY WORKED AND TO REMAIN IN PLACE FOR 14 DAYS OR MORE SHALL RECEIVE TEMPORARY SEEDING.

STABILIZED CONSTRUCTION AREA

STABILIZATION OF THE CONSTRUCTION AREA SHOULD TAKE PLACE AT THE END OF EACH WORK DAY.

WORK IN FLOWING WATER

NO WORK SHALL BE PERFORMED IN FLOWING WATER. WORK IN AND NEAR THE CRITICAL AREAS SHOULD BE ISOLATED FROM CONCENTRATED FLOWS OR STREAM FLOW. ONCE WORK IN THIS AREA BEGINS, PRIORITY SHALL BE GIVEN TO THE COMPLETION OF THE WORK AND FINAL STABILIZATION OF ALL DISTURBED AREAS

<u>Dewatering</u>

WHEN DEWATERING THE CONSTRUCTION AREA IS NECESSARY, ALL WATERS SHALL BE FILTERED BY USING FILTER BAGS OR AN ALTERNATIVE MEASURE APPROVED BY THE KANE-DUPAGE SOIL & WATER CONSERVATION DISTRICT. ALL FILTER BAGS MUST HAVE SECONDARY CONTAINMENT DEVICES, AND SHOULD BE PLACED ON LEVEL GROUND. WATER MUST HAVE SEDIMENT REMOVED BEFORE BEING ALLOWED TO RETURN TO THE ORIGINAL CREEK. THE DISCHARGE SHALL BE DESIGNED SO THAT RETURNING WATERS DO NOT CAUSE EROSION. THE CONTRACTOR WILL COORDINATE THE METHOD, DESIGN AND LOCATION OF THE DEWATERING PLAN AND FILTER BAG(S) WITH KANE-DUPAGE SOIL & WATER CONSERVATION DISTRICT AT THE PRE-CONSTRCUTION MEETING.

KEEPING PAVEMENTS CLEAN

THE CONTRACTOR WILL KEEP ALL PERMANENT PAVEMENT SURFACES CLEAN OF DIRT OR CONSTRUCTION DEBRIS. THE PAVEMENT SHALL BE CLEANED AT THE END OF EACH DAYS OPERATION OR MORE FREQUENTLY AS REQUIRED BY THE ENGINEER IF THE DEBRIS IS DEEMED TO BE A HAZARD TO THE MOTORING PUBLIC.

GENERAL NOTES

- A) UNLESS OTHERWISE INDICATED, ALL VEGETATIVE AND STRUCTURAL EROSION AND SEDIMENT CONTROL PRACTICES WILL BE CONSTRUCTED ACCORDING TO MINIMUM STANDARDS AND SPECIFICATIONS IN THE ILLINOIS URBAN MANUAL. LATEST EDITION.
- B) THE KANE-DUPAGE SOIL AND WATER CONSERVATION DISTRICT (KDSWCD) MUST BE NOTIFIED ONE WEEK PRIOR TO THE PRE-CONSTRUCTION CONFERENCE, ONE WEEK PRIOR TO THE COMMENCEMENT OF LAND DISTURBING ACTIVITIES, AND ONE WEEK PRIOR TO THE FINAL INSPECTION.
- C) A COPY OF THE APPROVED EROSION AND SEDIMENT CONTROL PLAN SHALL BE MAINTAINED ON THE SITE AT ALL TIMES.
- D) PRIOR TO COMMENCING LAND-DISTURBING ACTIVITIES IN AREAS OTHER THAN INDICATED ON THESE PLANS (INCLUDING BUT NOT LIMITED TO, ADDITIONAL PHASES OF DEVELOPMENT AND OFF-SITE BORROW OR WASTE AREAS) A SUPPLEMENTARY EROSION CONTROL PLAN SHALL BE SUBMITTED TO THE OWNER FOR REVIEW BY THE KDSWCD.
- E) THE CONTRACTOR IS RESPONSIBLE FOR INSTALLATION OF ANY ADDITIONAL EROSION CONTROL MEASURES NECESSARY TO PREVENT EROSION AND SEDIMENTATION AS DETERMINED BY THE KDSWCD.
- F) DURING DEWATERING OPERATIONS, WATER WILL BE PUMPED INTO SEDIMENT BASINS OR SILT TRAPS. DEWATERING DIRECTLY INTO FIELD TILES, STORMWATER STRUCTURES, OR BLACKBERRY CREEK IS PROHIBITED.
- G) IT IS THE RESPONSIBILITY OF THE OWNER AND/OR GENERAL CONTRACTOR TO INFORM ANY SUB-CONTRACTOR(S) WHO MAY PERFORM WORK ON THIS PROJECT, OF THE REQUIREMENTS IN IMPLEMENTING AND MAINTAINING THESE EROSION CONTROL PLANS AND THE NATIONAL POLLUTANT DISCHARGE ELIMINATION SYSTEM (NPDES) PERMIT REQUIREMENTS SET FORTH BY THE ILLINOIS EPA.

STABILIZATION TYPE	JAN.	FEB.	MAR.	APR.	MAY	JUNE	JULY	AUG.	SEPT.	OCT.	NOV.	DEC.
PERMANENT SEEDING			-	A		*	*	A			_	
DORMANT SEEDING	В										В	
TEMPORARY SEEDING			+C									
EROSION CONTROL	D											

- A. CLASS 4B
 CLASS 5B
 CLASS 4
 CLASS 5
- B. INCREASE SEEDING RATES BY 25% WHEN DORANT SEEDING (NOT ANTICIPATED)
- (PERMANENT SEED AREAS ONLY)

SPRING OATS)

C. TEMPORARY SEEDING (PERENIAL RYE GRASS.

D. EROSION CONTROL BLANKET (EXCELSIOR) AND

HEAVY DUTY EROSION CONTROL BLANKET

NOTE: SEEDING TO BE COMPLETED PER REQUIREMENTS
OF SECTION 250 OF THE IDOT STANDARD SPECIFICATIONS
FOR ROAD AND BRIDGES AND THE SPECIAL PROVISIONS.

* IRRIGATION MAY BE NEEDED DURING JUNE AND JULY

- H) WHERE WORK IS COMPLETE, PERMANENT STABILIZTION SHALL OCCUR WITHIN SEVEN (7) DAYS OF COMPLETION. WHERE WORK HAS TEMPORARILY CEASED FOR FOURTEEN (14) DAYS OR MORE, TEMPORARY STABILIZATION SHALL OCCUR BY THE SEVENTH DAY AFTER WORK HAS CEASED.
- I) THE CONTRACTOR IS RESPONSIBLE FOR INDICATING THE CURRENT LOCATION OF THE CONCRETE WASHOUT AND ANY MODIFICATIONS TO THE LOCATIONS OR DETAILS OF EROSION AND SEDIMENT CONTROLS ON THESE PLANS.

STABILIZED CONSTRUCTION ENTRANCE

A STABILIZED CONSTRUCTION ENTRANCE IS NOT ANTICIPATED FOR THIS PROJECT. HOWEVER, IF IT IS DETERMINED BY THE ENGINEER OR THE KANE-DUPAGE SOIL AND WATER CONVERSATION DISTRICT THAT THE CONTRACTOR OPERATIONS REQUIRE A STABILIZED ENTRANCE, QUANTITY HAS BEEN INCLUDED IN THE PROJECT TO COMPLETE THIS WORK. THERE WILL BE NO ADJUSTMENT TO THE CONTRACT IF THE ENTRANCE IS NOT CONSTRUCTED. IF REQUIRED, THE CONTRACTOR WILL SUBMIT THE LOCATION AND DETAILS TO KDSWCD FOR APPROVAL.

CONSTRUCTION SEQUENCE NOTES

- A) TURBIDITY CURTAINS SHOULD BE PLACED IN THE CREEK PRIOR TO ANY DEMOLITION TO THE BRIDGE DECK AND/OR PIERS.
- B) CONSTRUCTION OF PIERS, EMBANKMENT AND RIP RAP ARE ANTICIPATED TO REQUIRE WORK WITHIN THE CREEK, WORK MUST BE TIMED TO TAKE PLACE DURING LOW FLOW CONDITIONS.
- C) BYPASS IS NOT ANTICIPATED FOR THIS PROJECT. HOWEVER, IF BYPASS IS NECESSARY, THE INLET OF THE HOSE SHALL BE PLACED IN A SUMP PIT AND THE OUTLET PLACED ON A NON-ERODIBLE, ENERGY DISSIPATING SURFACE PRIOR TO REJOINING THE CREEK FLOW.
- D) IF DEWATERING THE CONSTRUCTION AREA IS NECESSARY, ALL WATERS SHALL BE FILTERED BY USING FILTER BAGS OR AN ALTERNATIVE MEASURE. WATER MUST HAVE SEDIMENT REMOVED BEFORE BEING ALLOWED TO RETURN TO THE ORIGINAL CREEK.
- E) THE SIDE SLOPES MUST BE RESEEDED AND STABILIZED WITH AN APPROPRIATE EROSION CONTROL BLANKET PRIOR TO ACCEPTING FLOWS. THE BOTTOM OF THE SWALE MUST BE BROUGHT BACK TO ITS ORIGINAL GRADE AND STABLE ENOUGH TO ACCEPT FLOWS.

DEWATERING - BASIS OF PAYMENT

SCALE: N/A


DEWATERING FOR ALL CONSTRUCTION OPERATIONS WILL NOT BE MEASURED SEPERATELY FOR PAYMENT BUT SHALL BE INCLUDED IN THE COST OF THE RELATED WORK ITEM REQUIRING DEWATERING. DEWATERING WILL INCLUDE MEANS, METHODS AND ALL MATERIALS TO DEWATER AND TO PROVIDE FILTRATION OF WATERS BEFORE RE-ENTERING THE CREEK.



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DEPARTMENT OF TRA	NSPORTATION


EROSION CONTROL & SEEDING NOTES						SECTION	COUNTY	TOTAL SHEETS	SHEET NO.
						04-00329-00-BR	KANE	86	30
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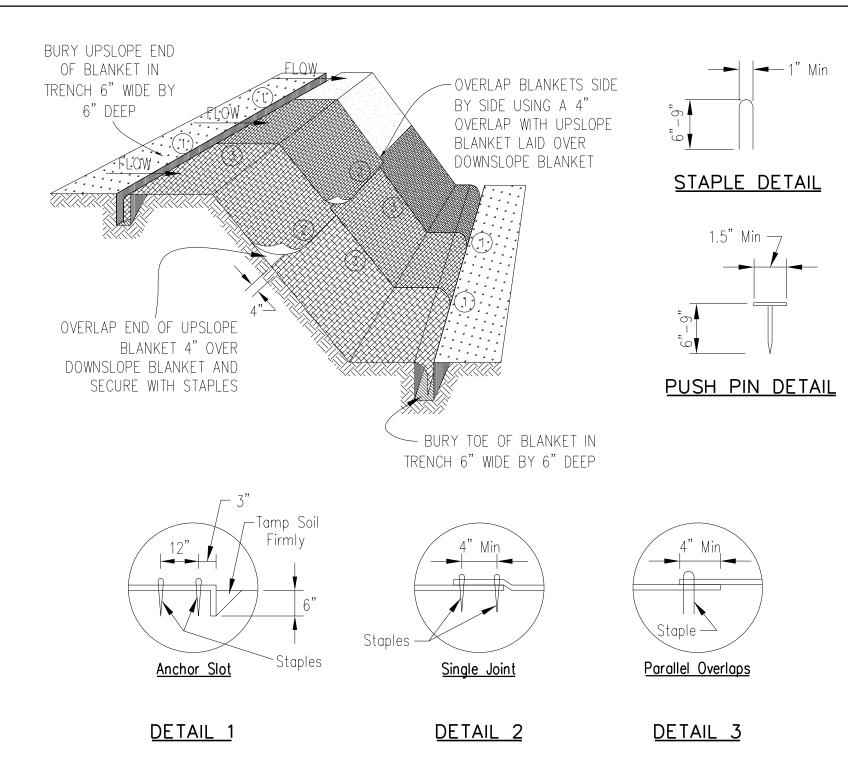
NOTES:

- 1. PIT DIMENSIONS ARE OPTIONAL.
- 2. THE STANDPIPE WILL BE CONSTRUCTED BY PERFORATING A 12''-24" DIAMETER CORRUGATED METAL OR PVC PIPE.
- 3. A BASE OF 2" AGGREGATED WILL BE PLACED IN THE PIT TO A MINIMUM DEPTH OF 12". AFTER INSTALLING THE STANDPIPE, THE PIT SURROUNDING THE STANDPIPE WILL THEN BE BACKFILLED WITH 2" AGGREGATE.
- 4. THE STANDPIPE WILL EXTEND 12" TO 18" ABOVE THE LIP OF THE PIT. 5. IF DISCHARGE WILL BE PUMPED DIRECTLY TO A STORM DRAINAGE SYSTEM, THE STANDPIPE WILL BE WRAPPED WITH FILTER FABRIC BEFORE INSTALLATION.
- 6. IF DESIRED, $\frac{1}{4}$ " HARDWARE CLOTH MAY BE PLACED AROUND THE STANDPIPE PRIOR TO ATTACHING THE FILTER FABRIC. THIS WILL INCREASE THE RATE OF WATER SEEPAGE INTO THE PIPE.

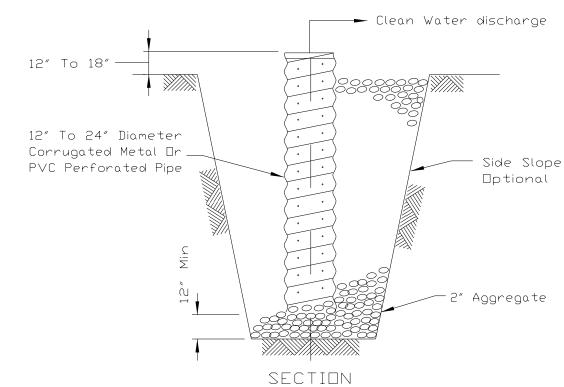SUMP PIT PLAN




TREE TRUNK PROTECTION

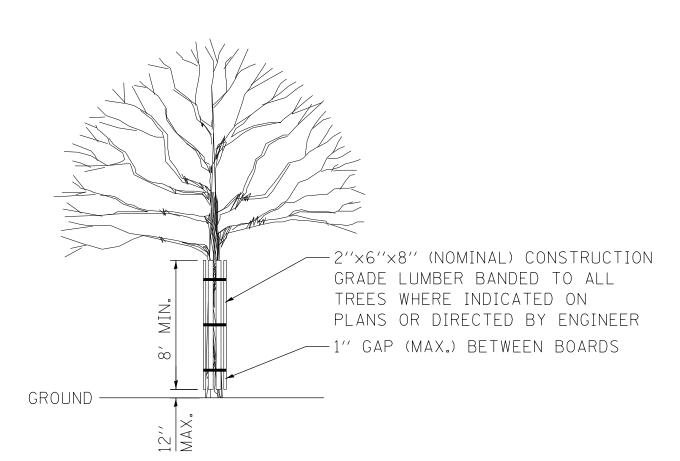

NOTES:

- 1. STAPLES SHALL BE PLACED IN A DIAMOND PATTERN AT 2 PER S.Y. FOR STITCHED BLANKETS. NON-STICHED SHALL USE 4 STAPLES PER S.Y. OF MATERIAL. THIS EQUATES TO 200 STAPLES WITH STITCHED BLANKET AND 400 STAPLES WITH NON-STICHED BLANKET PER 100 S.Y. OF MATERIAL
- 2. STAPLE OR PUSH PIN LENGTHS SHALL BE SELECTED BASED ON SOIL TYPE AND CONDITIONS. (MINIMUM STAPLE LENGTH IS 6")
- EROSION CONTROL MATERIAL SHALL BE PLACED IN CONTACT WITH THE SOIL OVER A PREPARED SEEDBED.
- 4. ALL ANCHOR SLOTS SHALL BE STAPLED AT APPROXIMATELY 12" INTERVALS.

EROSION CONTROL BLANKET INSTALLATION DETAILS

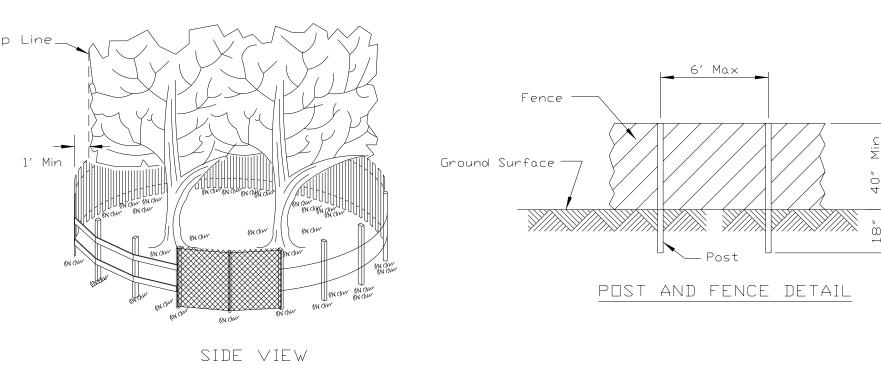


NOTES:

- 1. THE FENCE SHALL BE LOCATED A MINIMUM OF 1 FOOT OUTSIDE THE DRIP LINE OF THE TREE TO BE SAVED AND IN NO CASE CLOSER THAN 5 FEET TO THE TRUNK OF
- 2. FENCE POSTS SHALL BE EITHER STANDARD STEEL POSTS OR WOOD POSTS WITH A MINIMUM CROSS SECTIONAL AREA OF 3.0 SQ. IN.
- 3. THE FENCE MAY BE EITHER 40" HIGH SNOW FENCE, 40" PLASTIC WEB FENCING OR ANY OTHER MATERIAL AS APPROVED BY THE ENGINEER/INSPECTOR.


SCALE: N/A

4. TO BE PAID FOR AS "TEMPORARY CONSTRUCTION FENCE."

TREE PROTECTION FENCING

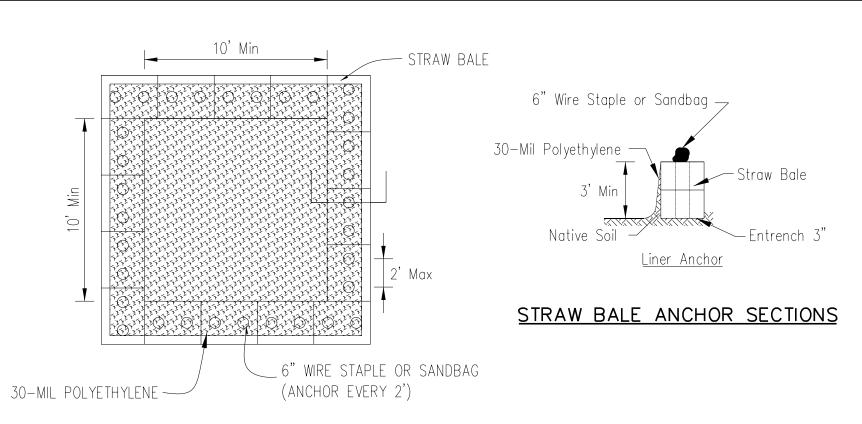


PLAN VIEW

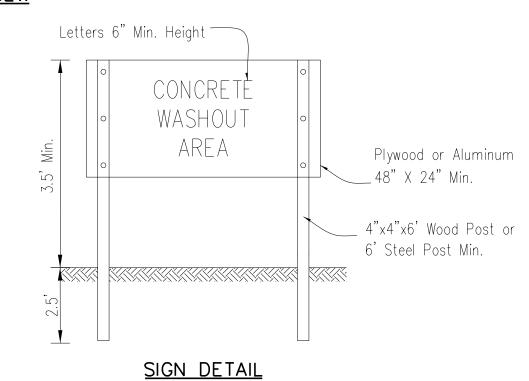

NOTES:

- 1. MAINTAINING TEMPORARY CONCRETE WASHOUT FACILITIES SHALL INCLUDE REMOVING AND DISPOSING OF HARDENED CONCRETE AND/OR SLURRY AND RETURNING THE FACILITIES TO A FUNCTIONAL CONDITION.
- 2. FACILITY SHALL BE CLEANED OR RECONSTRUCTED IN A NEW AREA ONCE WASHOUT BECOMES TWO-THIRDS FULL.
- 3. EACH STRAW BALE IS TO BE STAKED IN PLACE USING (2) 2"X2"X4" WOODEN STAKES.

TEMPORARY CONCRETE WASHOUT FACILITY - STRAW BALE

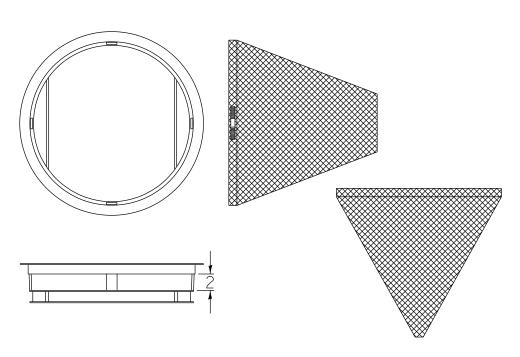

ROUND CATCH ALL

GENERAL NOTES

FRAME: TOP FLANGE FABRICATED FROM $1^{1}/_{4}^{\prime\prime}\times1^{1}/_{4}^{\prime\prime}\times|_{8}^{\prime\prime}$ ANGLE. BASE RIM FABRICATED FROM $1\frac{1}{2}$ "× $\frac{1}{2}$ "× $\frac{1}{8}$ " CHANNEL. HANDELS AND SUSPENSION BRACKETS FABRICATED FROM $1\frac{1}{4}$ "x FLAT STOCK. ALL STEEL CONFORMING TO ASTM-A36.

SEDIMENT BAG: BAG FABRICATED FROM 4 OZ./SQ.YD. NON-WOVEN POLYPROPYLENE GEOTEXTILE REINFORCED WITH POLYESTER MESH. BAG SECURED TO BASE RIM WITH A STAINLESS STEEL BAND AND LOCK.


INLET PROTECTION DETAIL



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STATE OF ILLINOIS					
DEPARTMENT OF TRANSPORTATION					


EROSION CONTROL					F.A.U. RTE.	SECTION	COUNTY	TOTAL SHEETS	SHEET NO.
& SEEDING DETAILS						04-00329-00-BR	KANE	86	31
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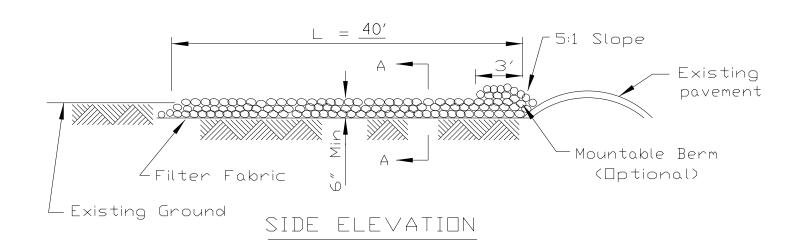
SECTION TURBIDITY BARRIER (FLOATING SILT CURTAIN) N.T.S


NOTES:

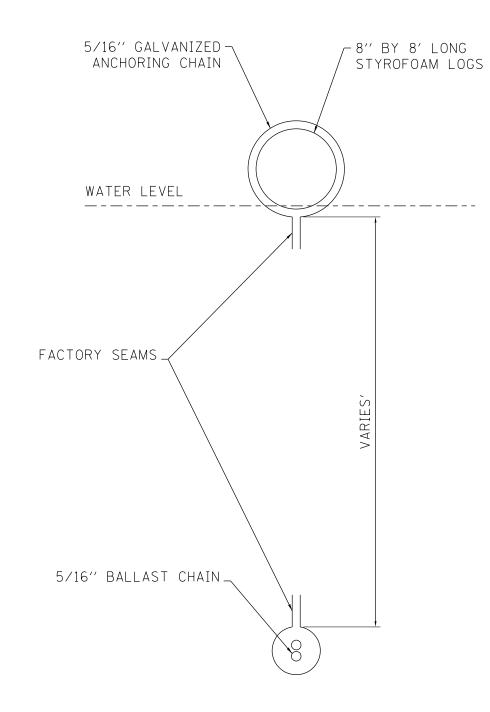- 1. THE SILT CURTAIN SHALL BE INSTALLED IN SUCH A MANNER AS TO PREVENT DRIFT SHOREWARD OR DOWNSTREAM. THE FLOATATION LOG SHALL BE SECURELY ATTACHED TO THE FABRIC IN BOTH THE HORIZONTAL ANDVERTICAL DIRECTION.
- 2. THE 5/16-INCH CABLE SHALL BE ATTACHED ABOVE THE FLOATATION MEMBERS AND EXTEND THE ENTIRE LENGTH OF EACH SECTION OF SILT CURTAIN. A 5/16-INCH CHAIN SHALL BE SEALED ON THE LOWER HEM FOR BALLAST.
- 3. CONNECTORS SHALL JOIN THE MAIN LOAD LINE AND BALLAST CHAIN TO CARRY ALL TENSILE PRESSURE. THE FABRIC SHALL BE JOINTED FOR ITS ENTIRE HEIGHT.
- 4. ANCHORAGE'S SHALL BE INSTALLED ON BOTH SHORE AND STREAM SIDE TO MAXIMUM STABILITY. SHORE ANCHORS SHALL CONSIST OF A POST WITH DEADMAN OR APPROVED EQUAL. STREAM ANCHORS SHALL BE OF SUFFICIENT SIZE, TYPE AN STRENGTH TO STABILIZE THE BARRIER BEYOND THE CONSTRUCTION AREA.
- 5. ANCHORS SHALL BE BUOYED TO PREVENT THE SILT CURTAIN FROM BEING PULLED UNDER WATER. DANFORTH-TYPE ANCHORS SHALL BE USED IN SANDY BOTTOM AND HEAVY KEDGE TYPE OR MUSHROOM ANCHORS ON MUD BOTTOMS.
- 6. THE CONTRACTOR SHALL BE RESPONSIBLE FOR MAINTENANCE OF THE SILT CURTAIN THROUGHOUT CONSTRUCTION OPERATIONS.
- 7. UPON COMPLETION OF THE WORK, THE CONTRACTOR SHALL REMOVE THE SILT CURTAIN IN A MANNER THAT WILL PREVENT SILTATION OF THE RIVER/CREEK.
- 8. THE TURBIDITY CURTAIN/SILT CURTAIN SHOULD BE PLACED IN THE CREEK PRIOR TO ANY DEMOLITION TO THE BRIDGE DECK AND/OR PIERS.





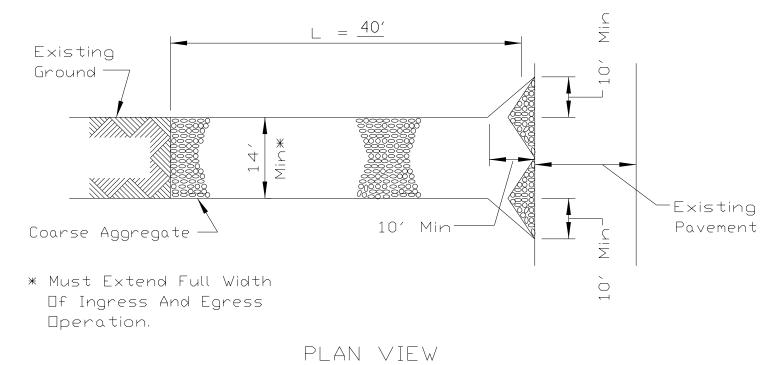

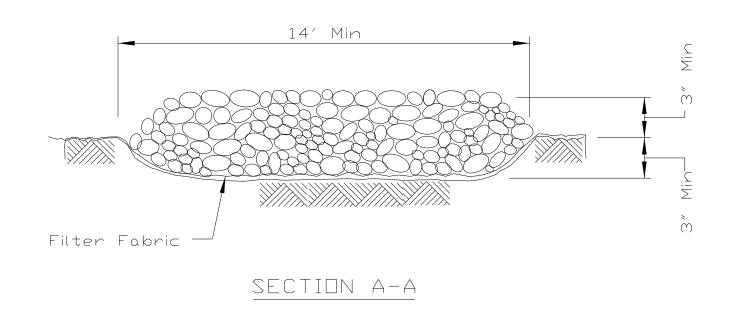

NOTES:

SCALE: N/A

- 1. FILTER FABRIC SHALL MEE THE REQUIREMENTS OF ARTICLE 1080.03 OF THE STANDARD SPECIFICATIONS AND SHALL BE PALCED OVER THE CLEARED SUBGRADE AREA PRIOR TO PLACING THE ROCK.
- 2. AGGREGATE FILL SHALL MEET ONE OF THE FOLLOWING IDOT COARSE AGGREGATE GRADATIONS, CA-1, CA-2, CA-3 OR CA-4 AND BE PLACED ACCORDING TO SPECIAL PROVISION "STABILIZED CONSTRCUTION ENTRANCE.
- 3. ANY DRAINAGE FACILTIES REQUIRED BECASUE OF WASHING SHALL BE CONSTRCUTED ACCORDING TO MANUFACTURERS SPECIFICATIONS.
- 4. IF WASH RACKS ARE USED THEY SHALL BE INSTALLED ACCORDING TO MANUFACTURERS SPECIFICATIONS.

STABILIZED CONSTRUCTION ENTRANCE PLAN


WILLS BURKE KELSEY ASSOCIATES LTD.


116 West Main Street, Suite 201
St. Charles, Illinois 60174


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	PLOT DATE = 7/9/2013	DATE -	REVISED -


STATE OF ILLINOIS DEPARTMENT OF TRANSPORTATION


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& SEEDING DETAILS	1542	04-00329-00-BR	KANE	8		
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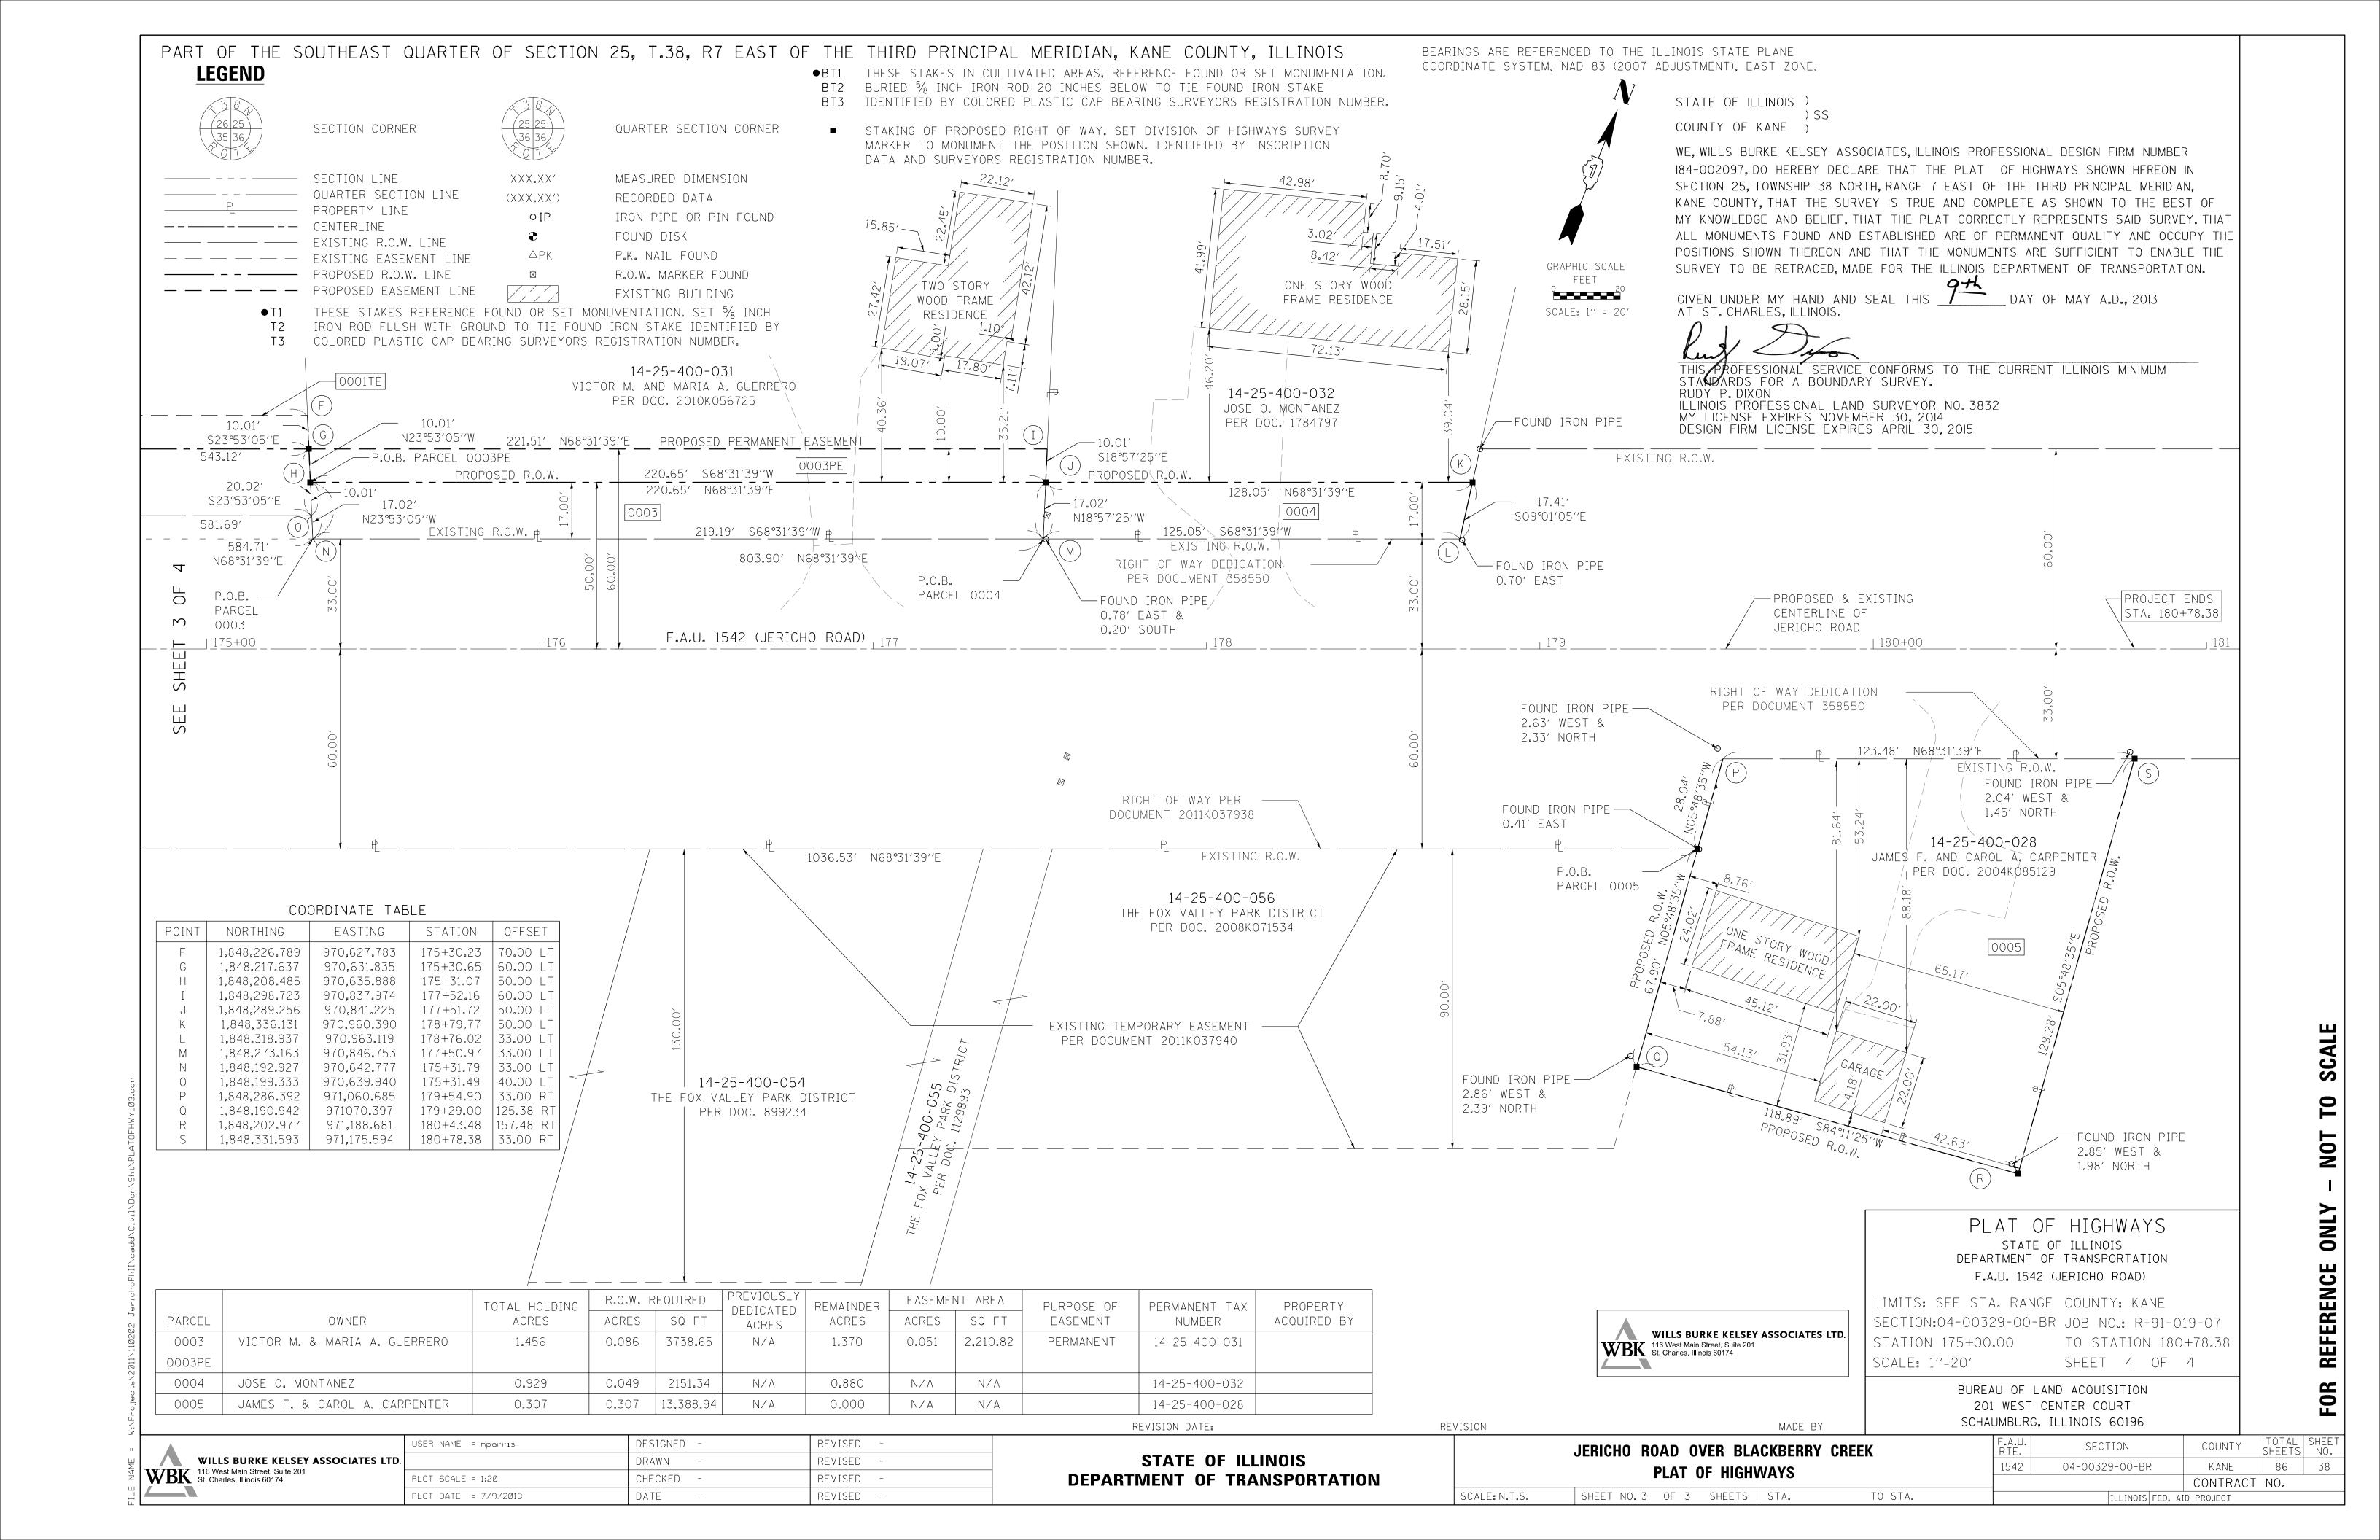


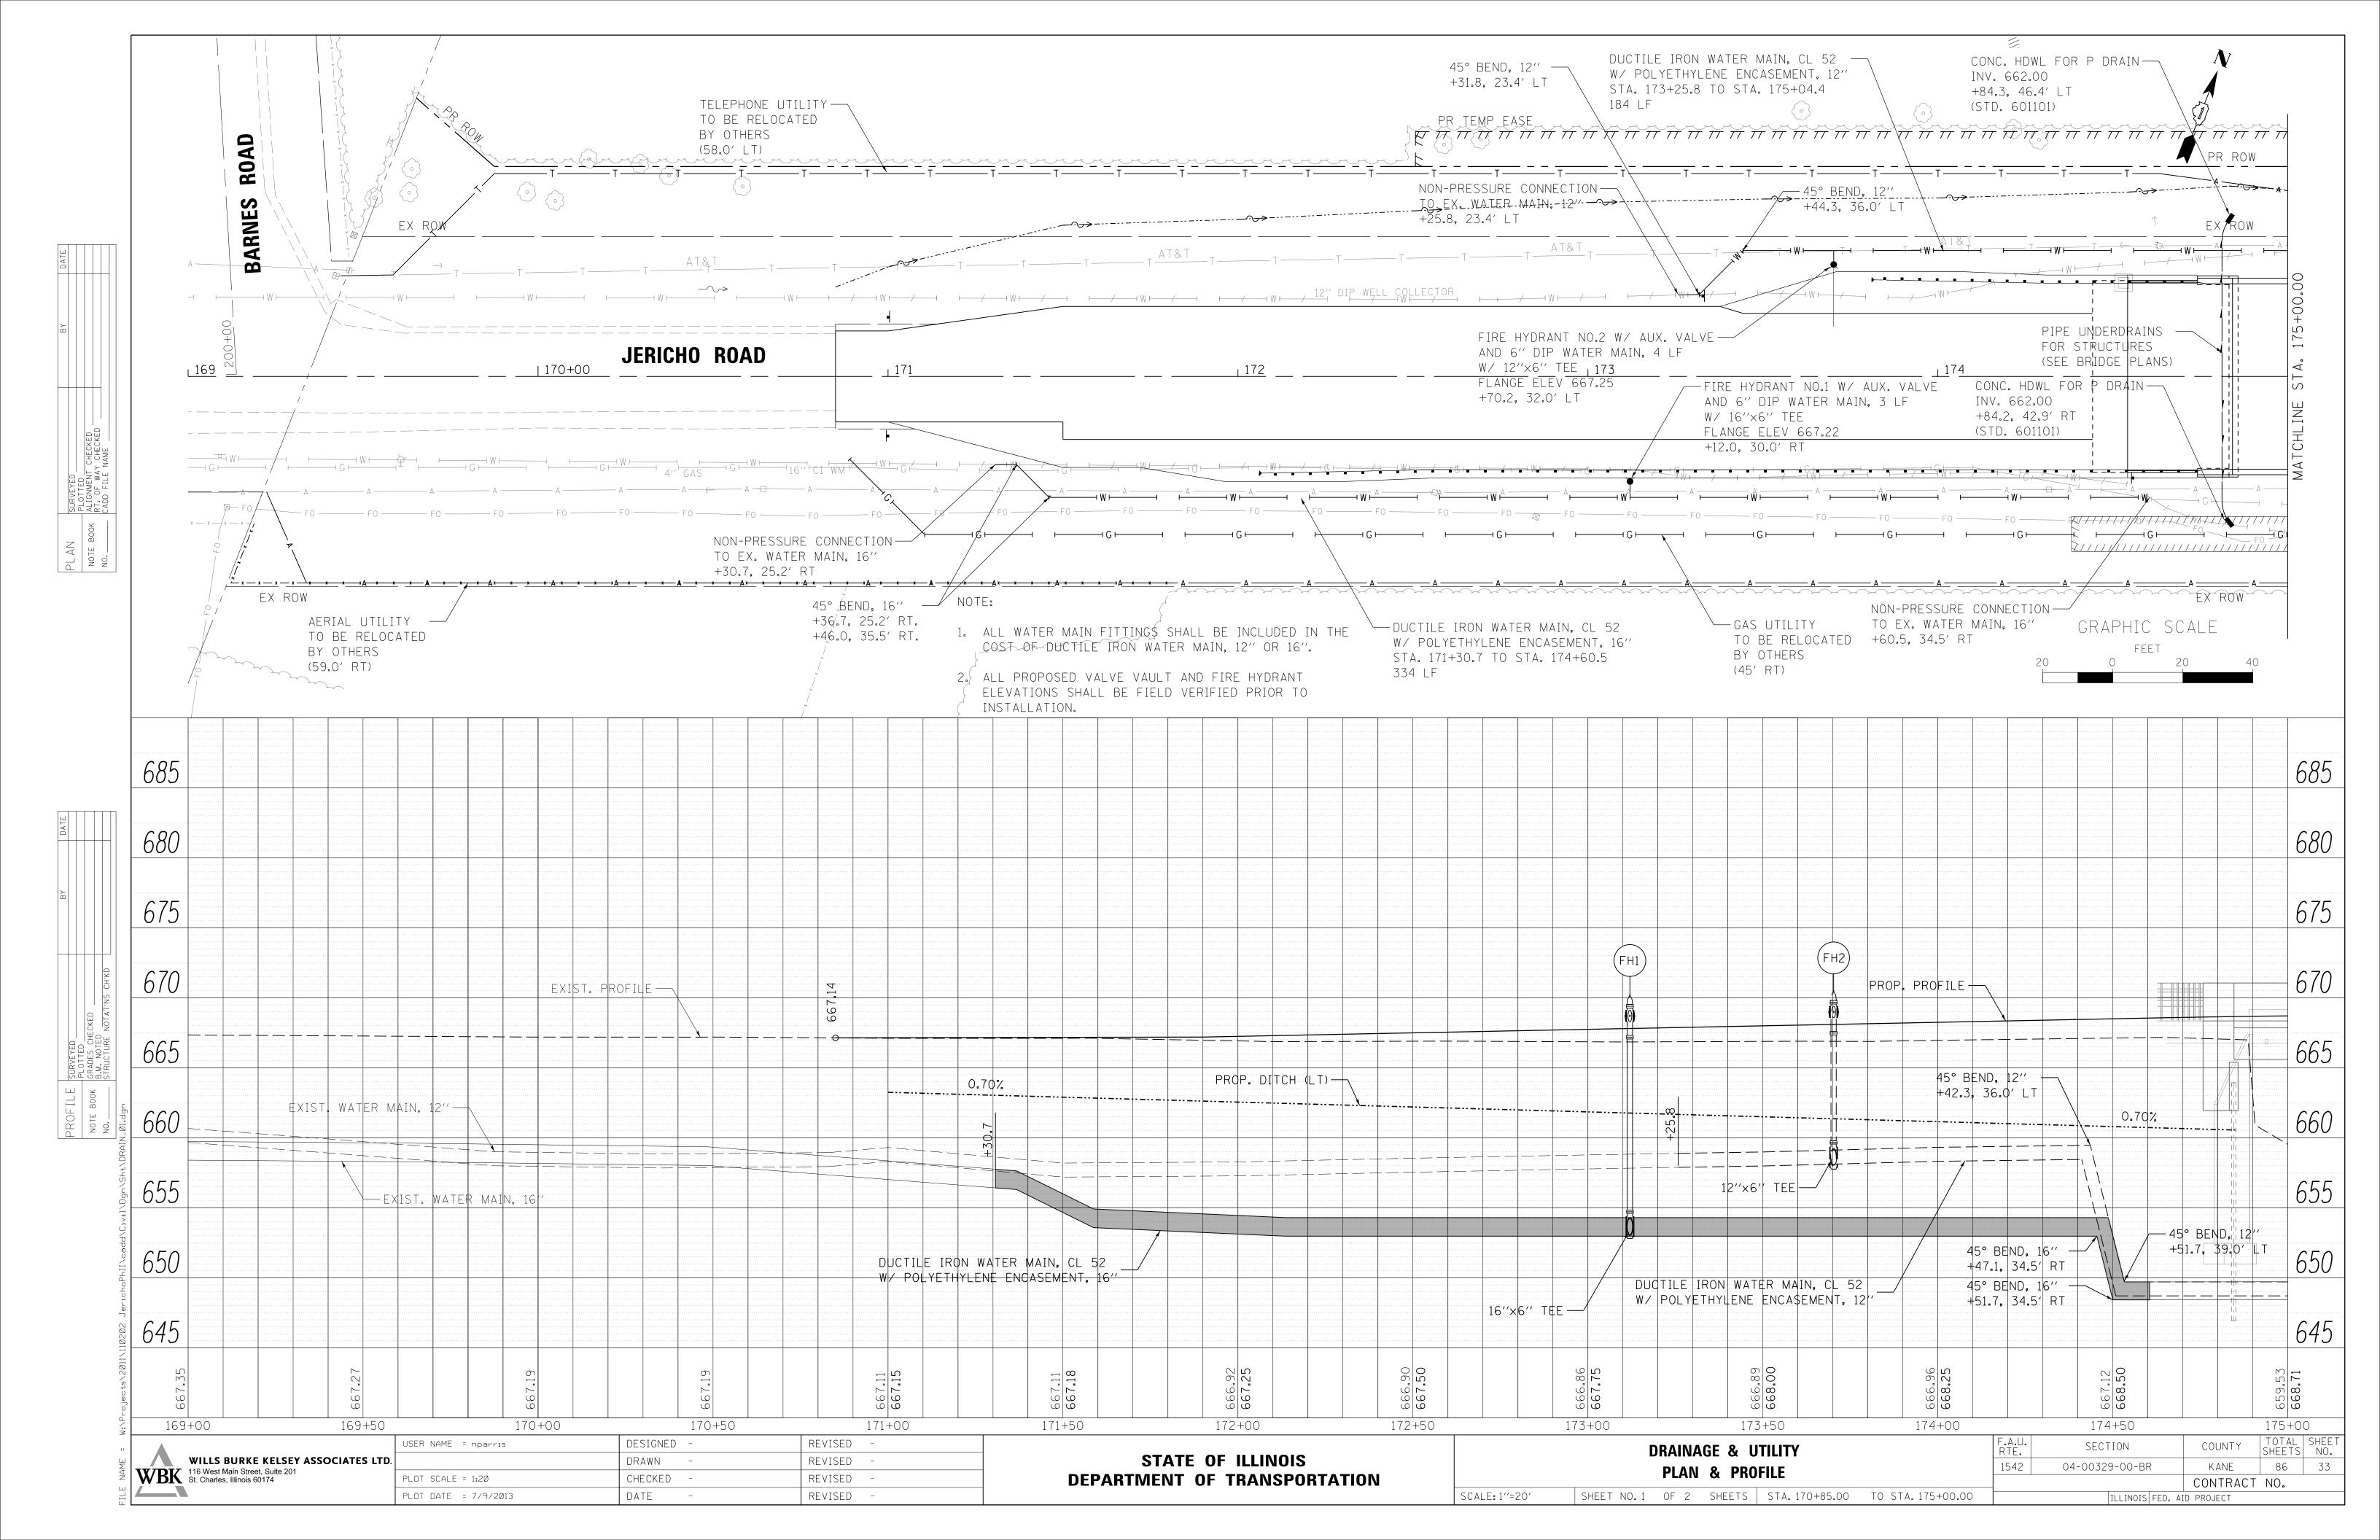


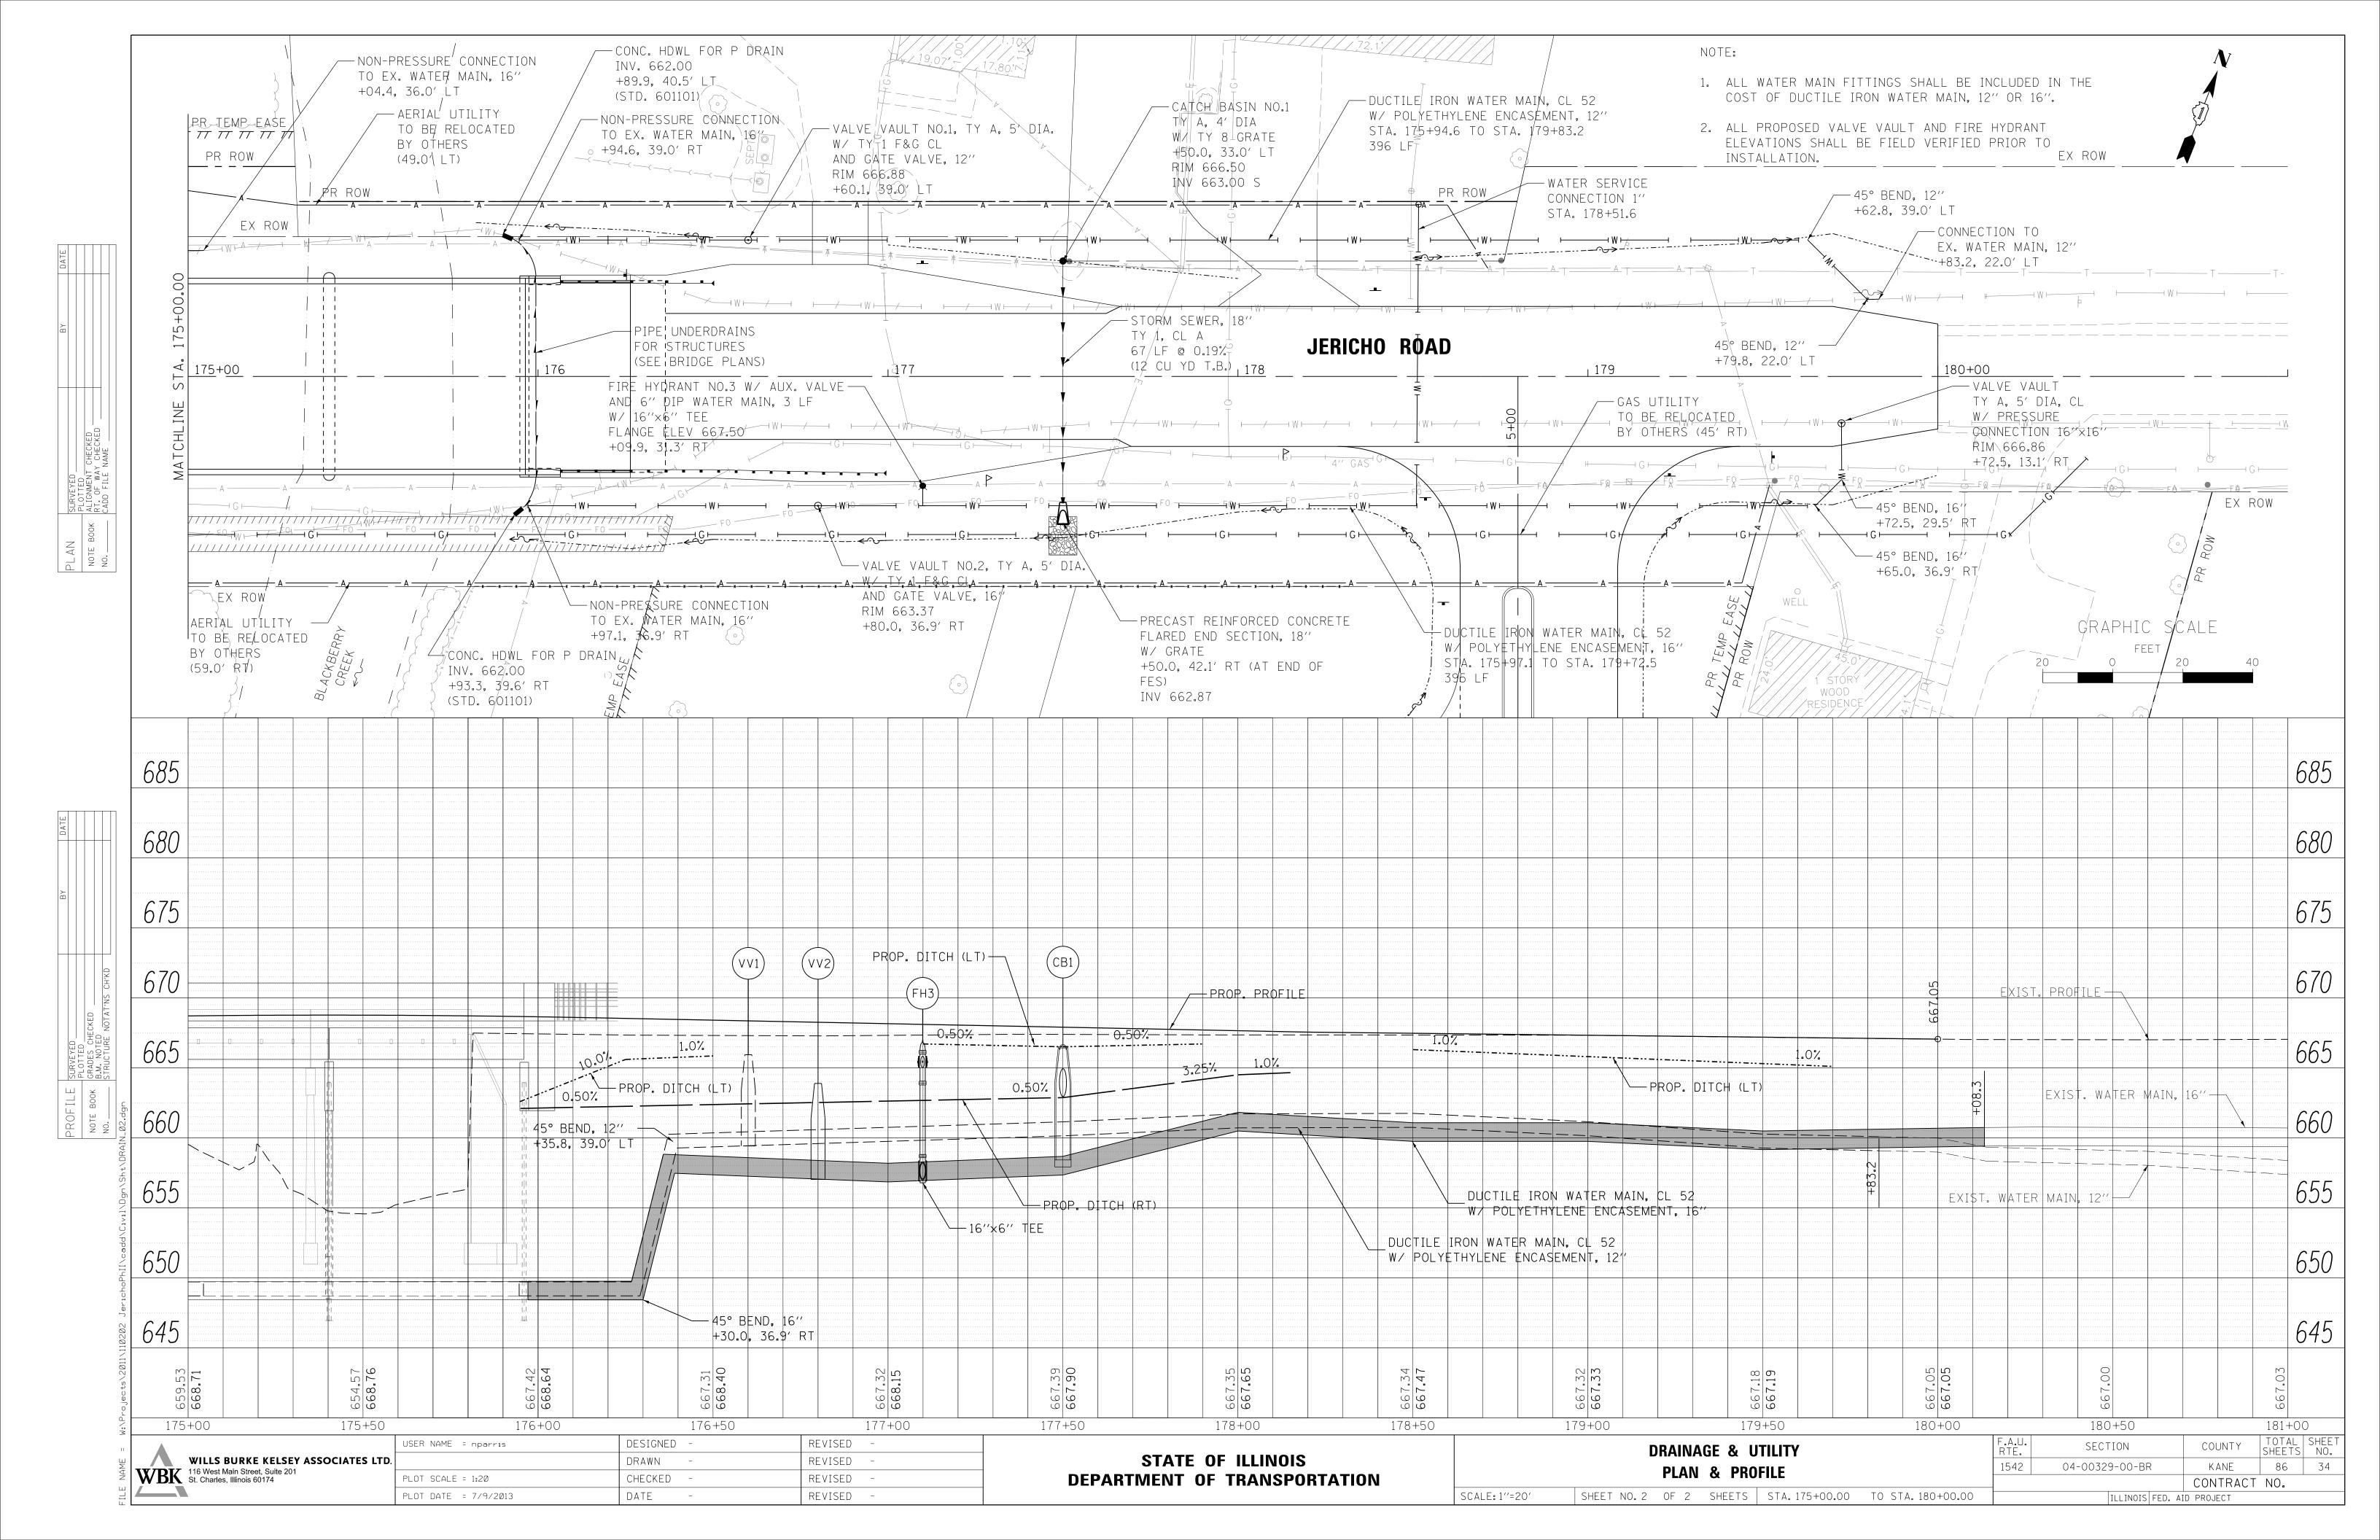


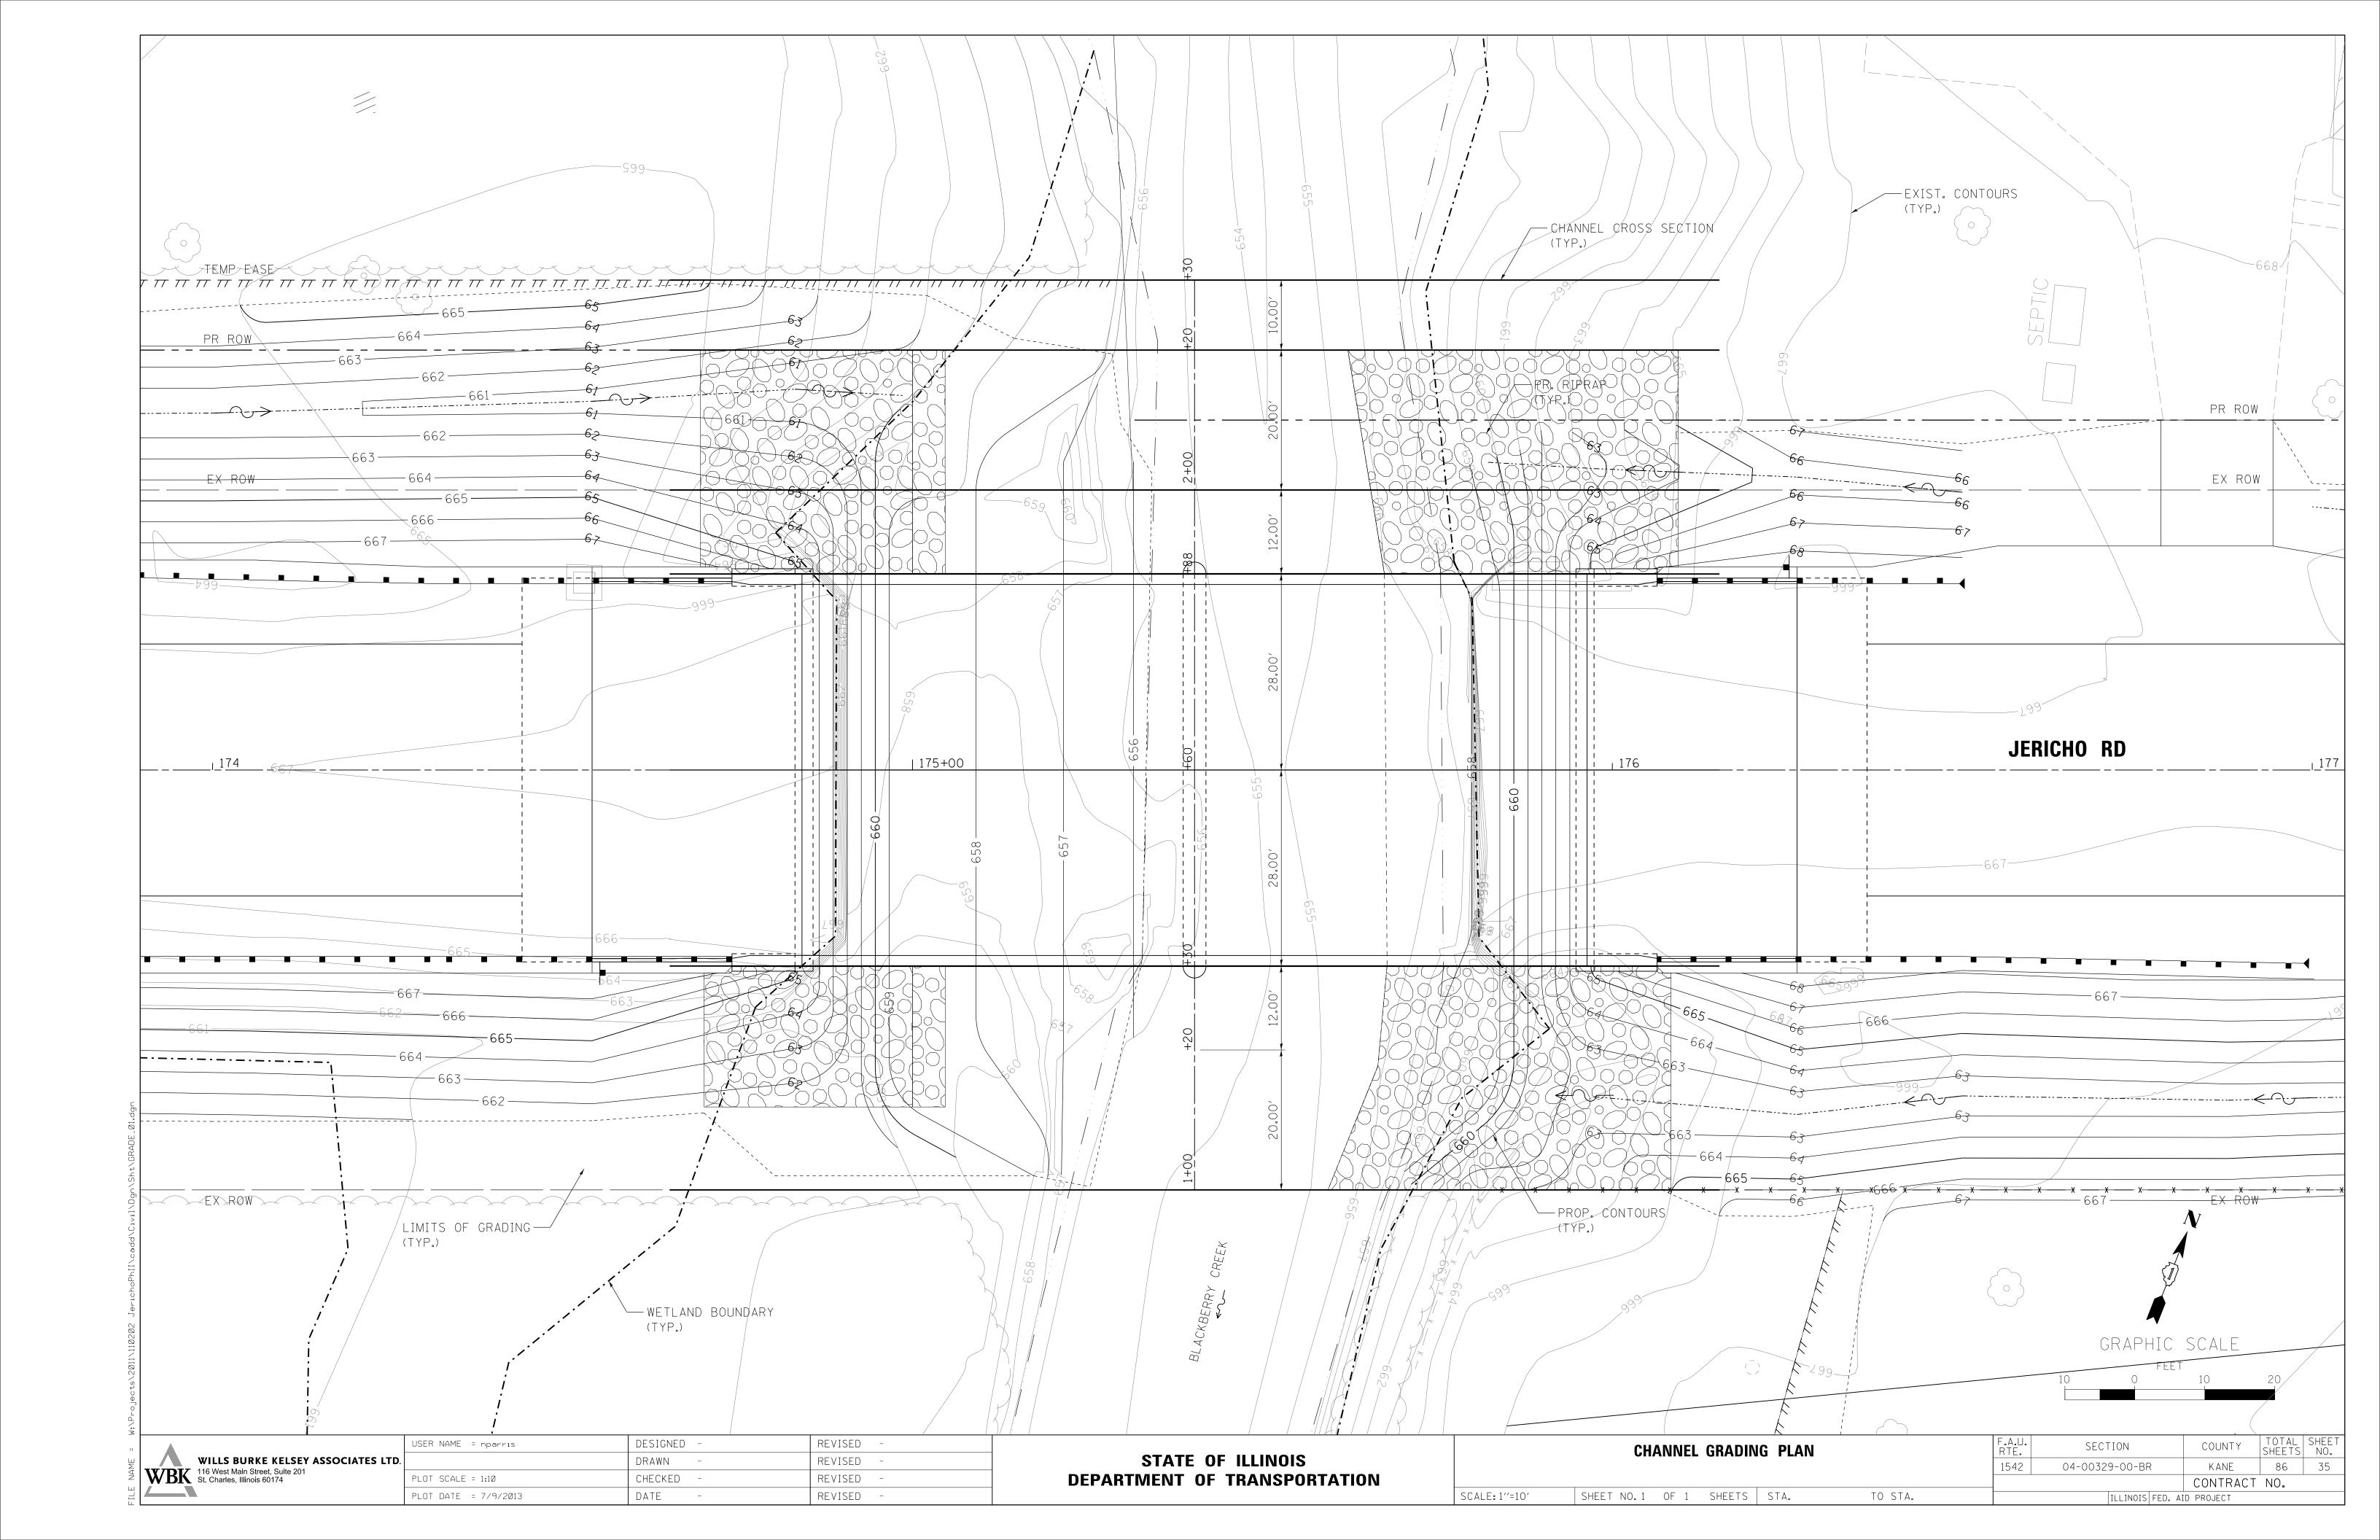

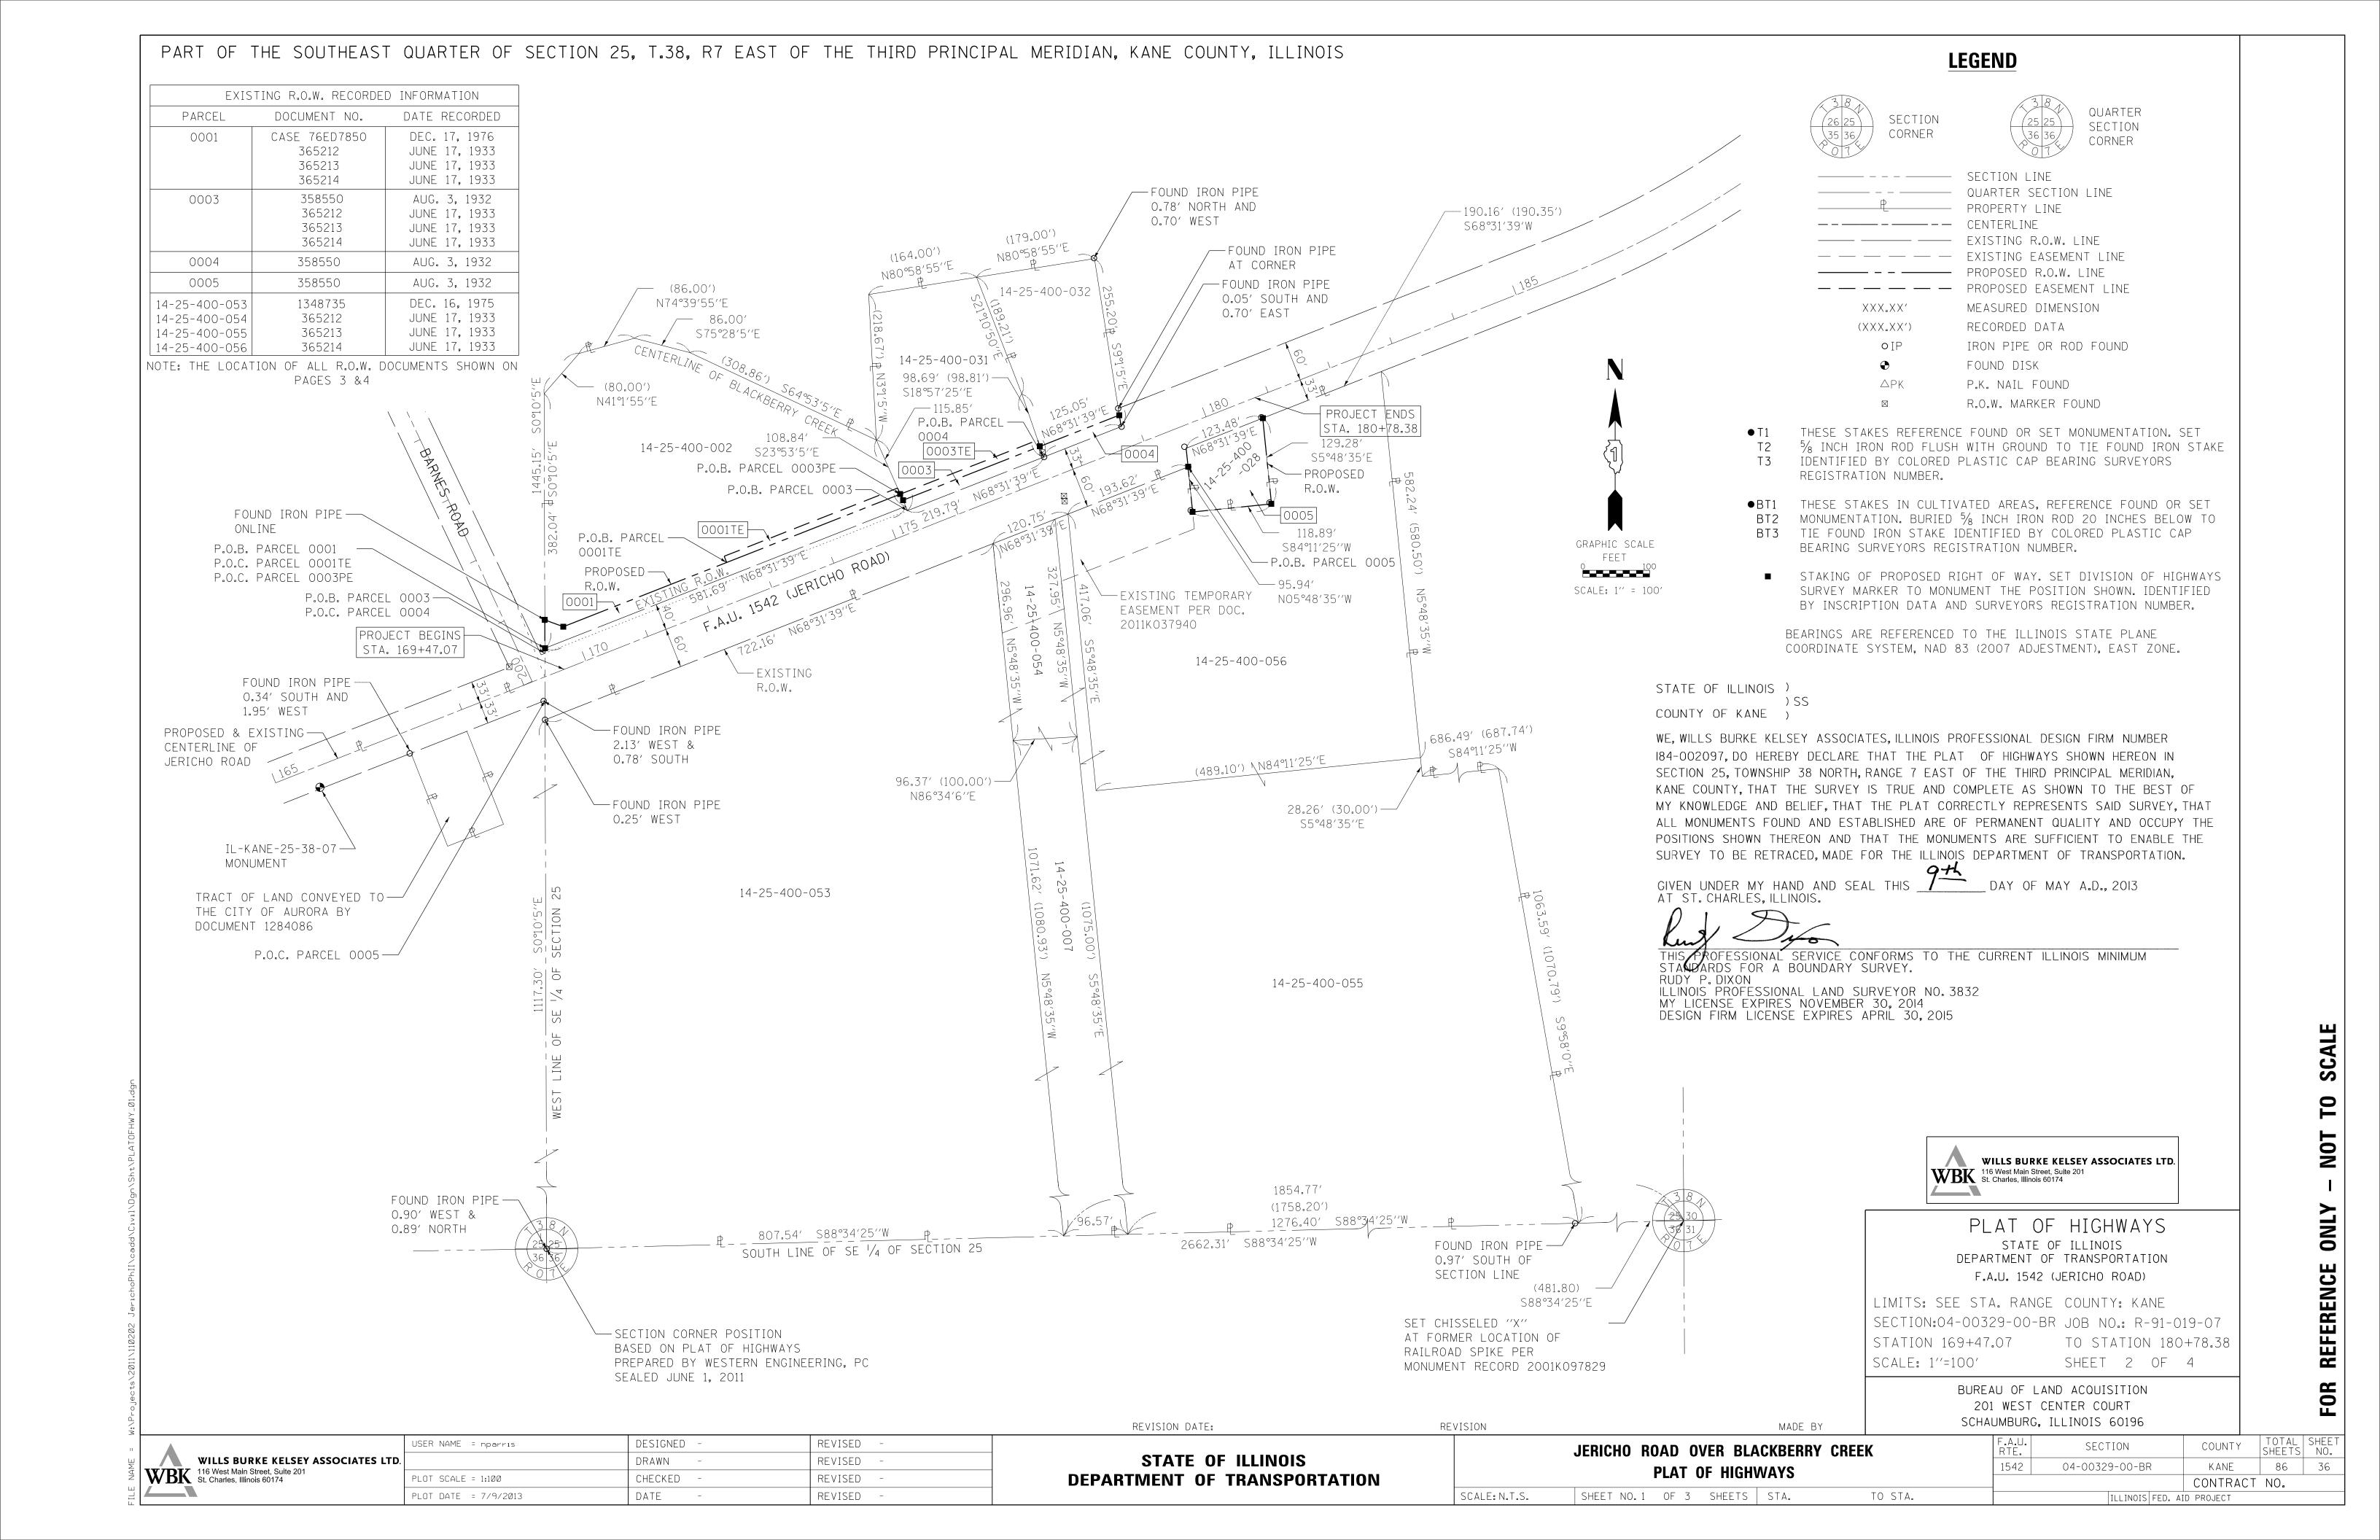

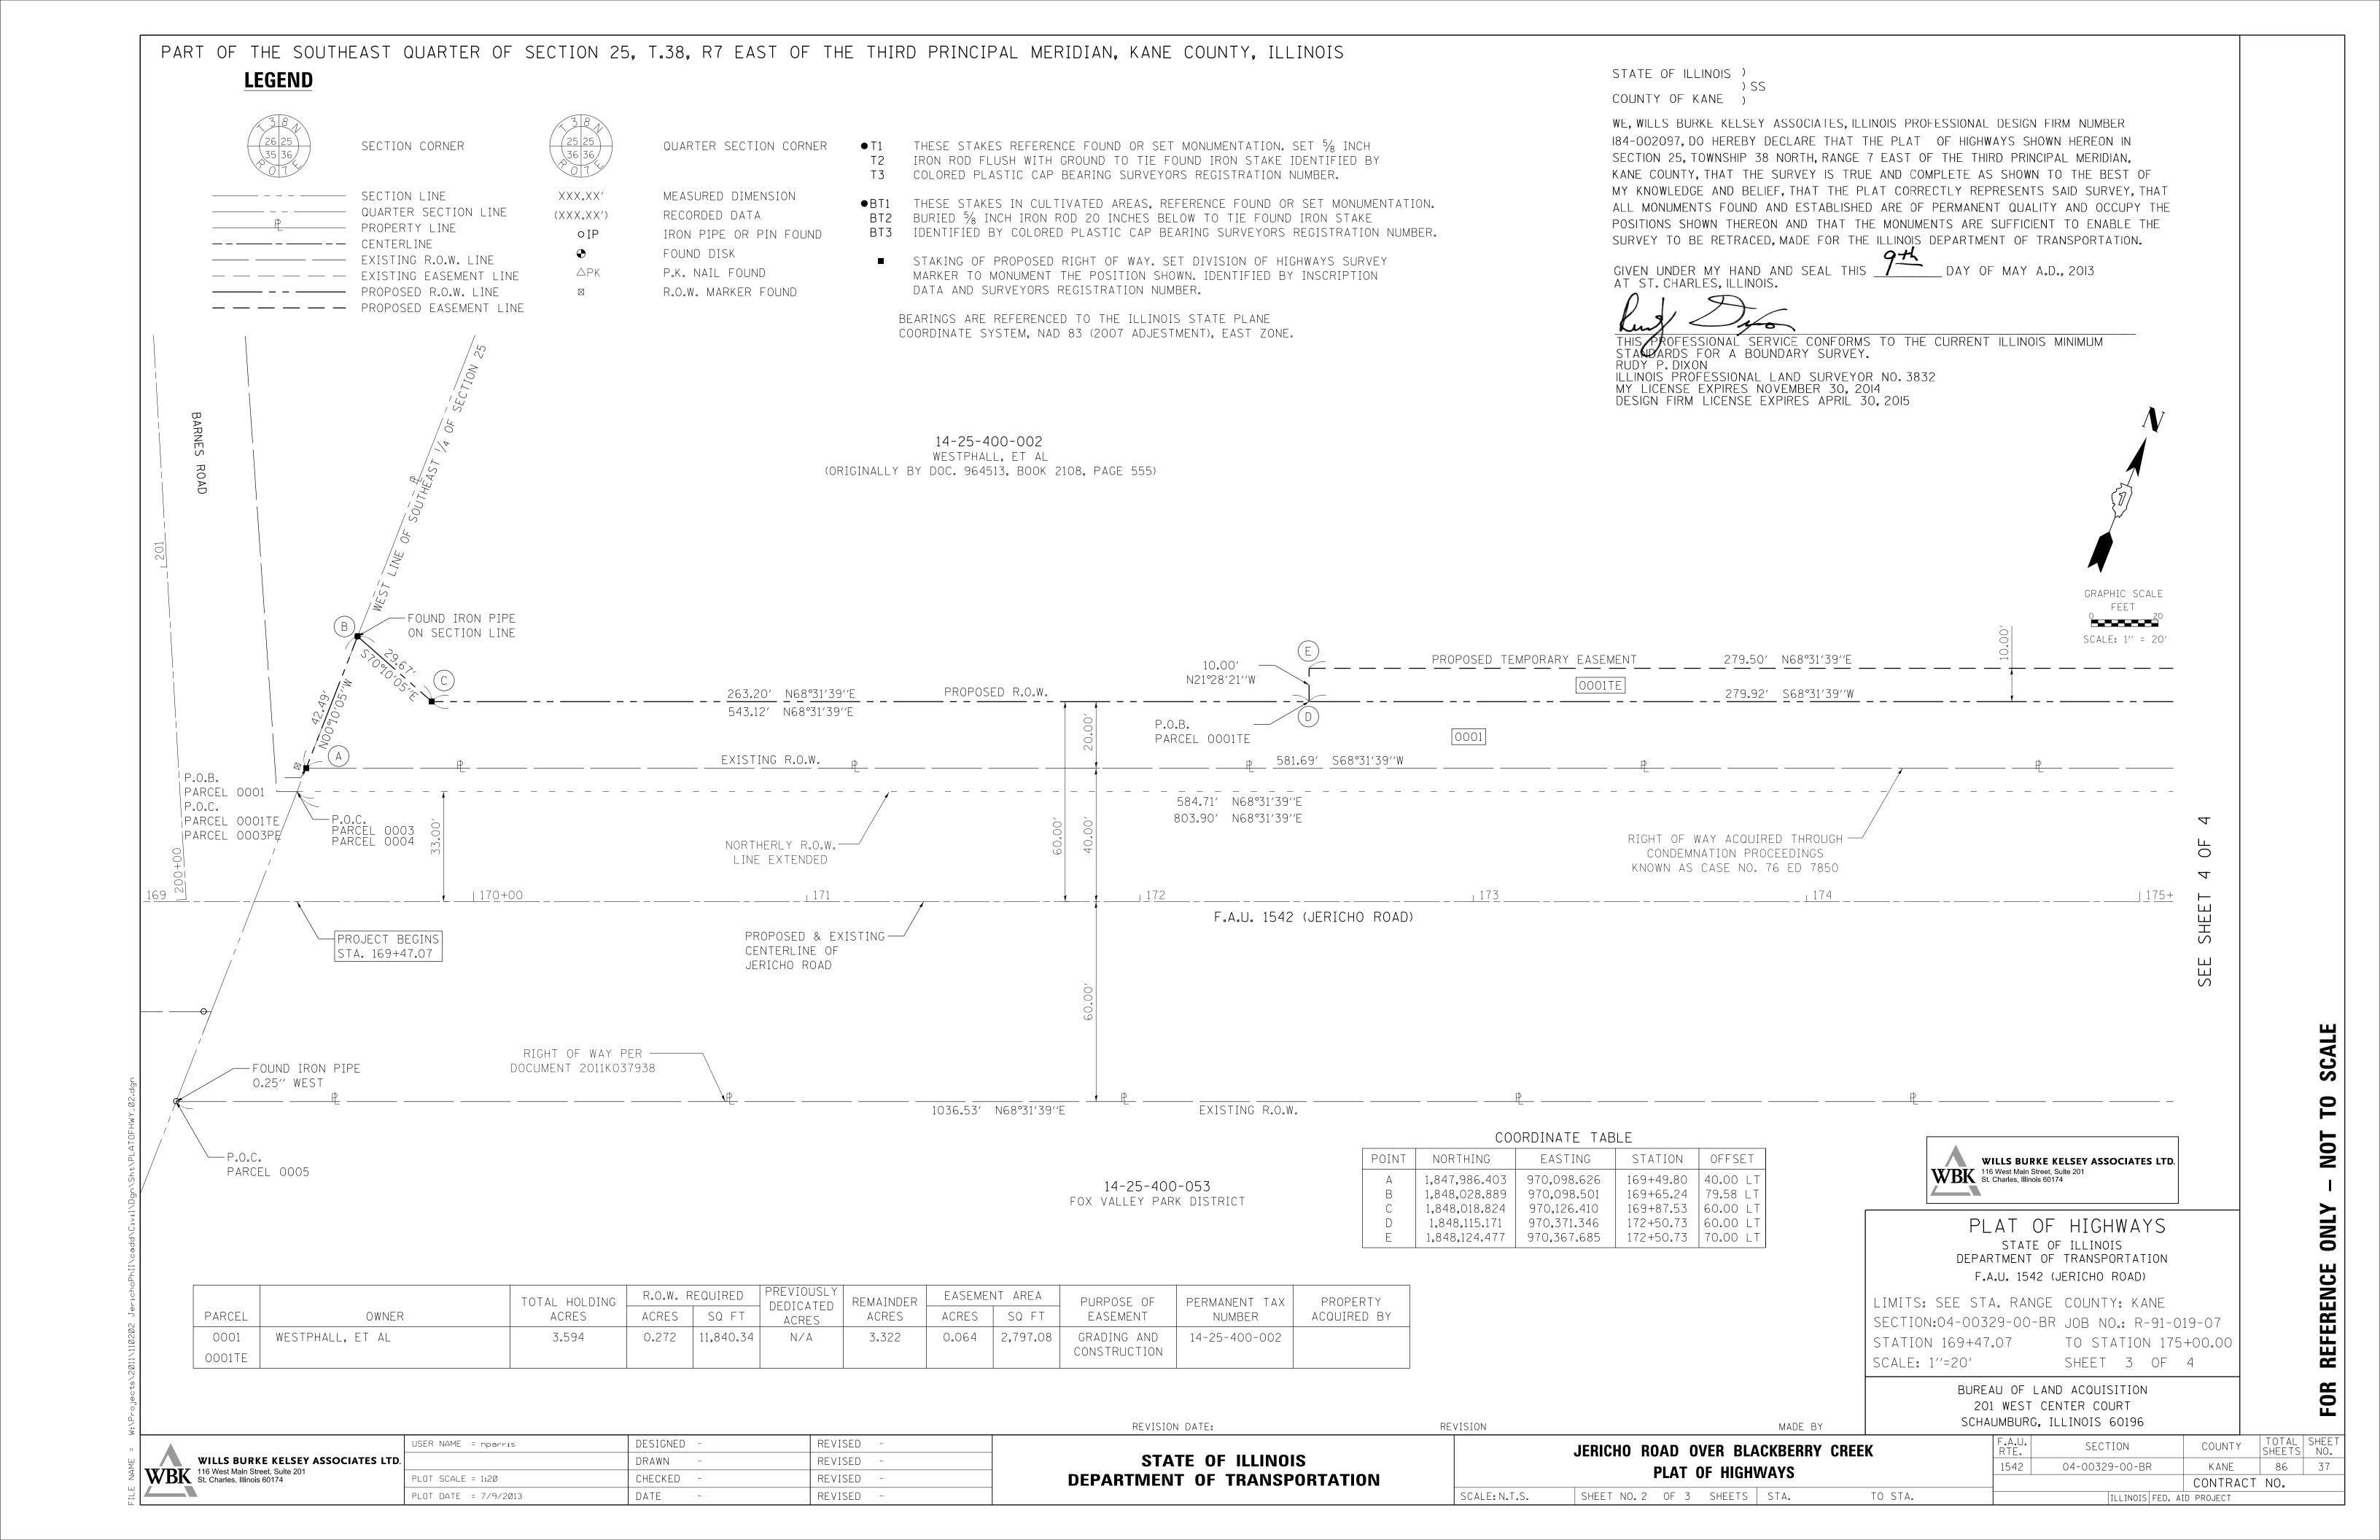


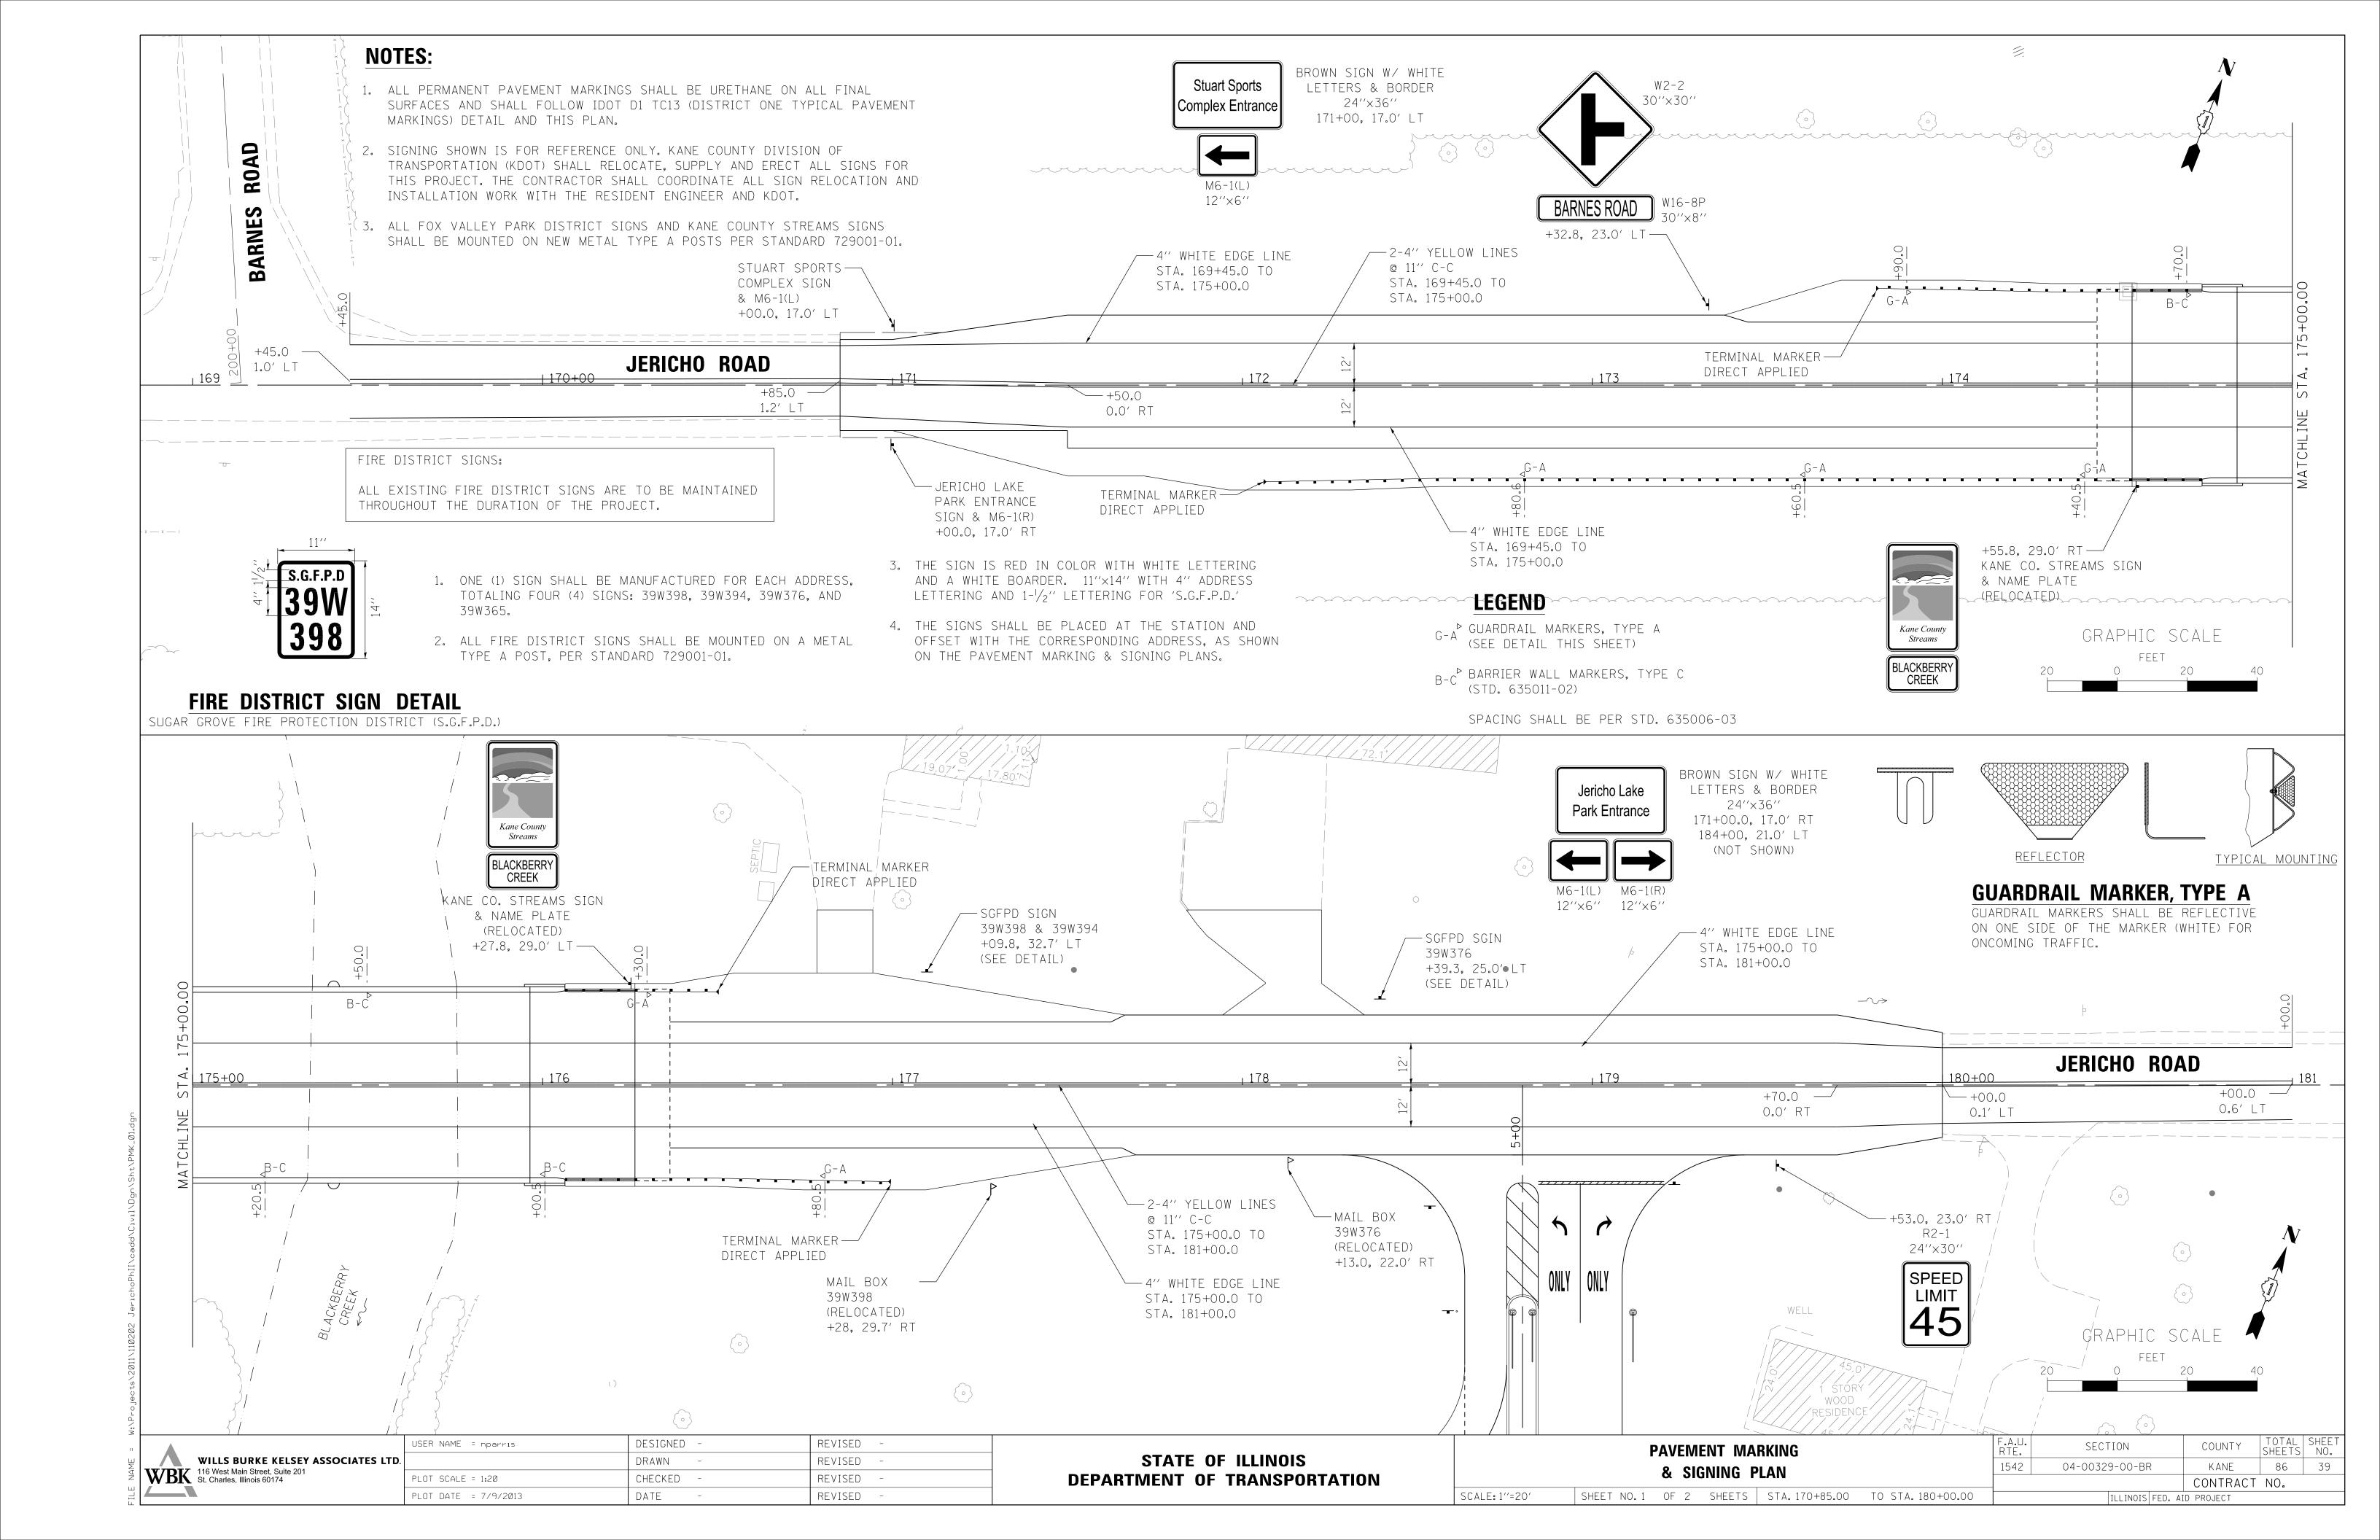

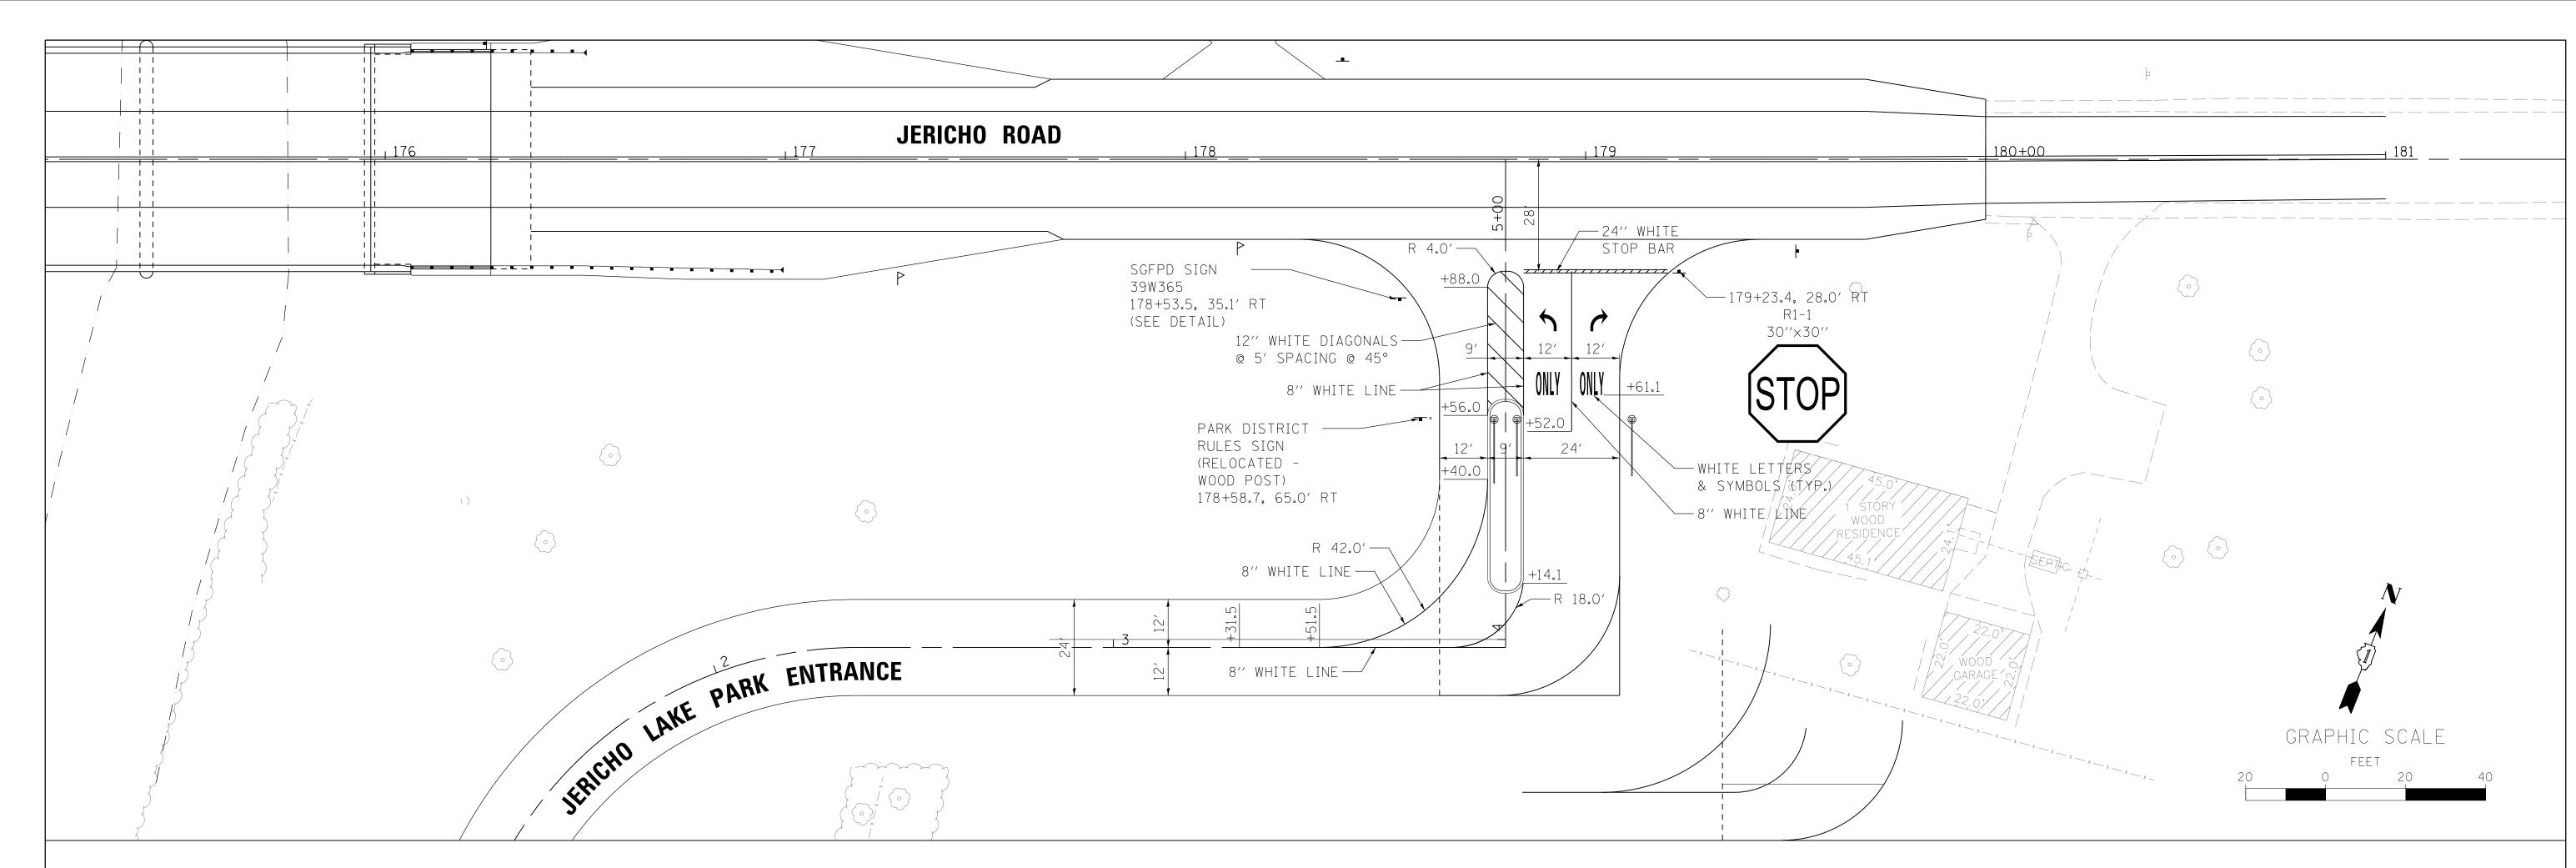

NOTES:

- 1. ALL PERMANENT PAVEMENT MARKINGS SHALL BE URETHANE ON ALL FINAL SURFACES AND SHALL FOLLOW IDOT D1 TC13 (DISTRICT ONE TYPICAL PAVEMENT MARKINGS) DETAIL AND THIS PLAN.
- 2. KANE COUNTY DIVISION OF TRANSPORTATION (KDOT) SHALL SUPPLY AND ERECT ALL REGULATORY AND WARNING SIGNS FOR THIS PROJECT. THE CONTRACTOR SHALL COORDINATE ALL SIGN INSTALLATION WORK WITH THE RESIDENT ENGINEER AND KDOT.
- 3. ALL FOX VALLEY PARK DISTRICT SIGNS AND KANE COUNTY STREAMS SIGNS SHALL BE MOUNTED ON NEW METAL TYPE A POSTS PER STANDARD 729001-01, AND SHALL BE INCLUDED IN THE COST OF RELOCATED SIGN PANEL ASSEMBLY TYPE A.
- 4. ALL SIGNS ARE STATIONED AND OFFSET FROM JERICHO ROAD.
- 5. ALL PAVEMENT MARKING ON THE JERICHO PARK ENTRANCE ROAD ARE COLORED "WHITE" AT THE REQUEST OF THE FVPD.

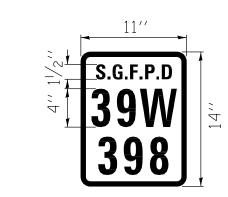

1. ONE (1) SIGN SHALL BE MANUFACTURED FOR EACH ADDRESS, TOTALING FOUR (4) SIGNS: 39W398, 39W394, 39W376, AND 39W365.

SCALE: 1''=20'

- 2. ALL FIRE DISTRICT SIGNS SHALL BE MOUNTED ON A METAL 4. THE SIGNS SHALL BE PLACED AT THE STATION AND TYPE A POST, PER STANDARD 729001-01. THE POST AND SIGN OFFSET WITH THE CORRESPONDING ADDRESS, AS SHOWN SHALL BE PAID FOR AS METAL POST-TYPE A AND SIGN PANEL- ON THE PAVEMENT MARKING & SIGNING PLANS. TYPE 1, RESPECTIVELY.
- 3. THE SIGN IS RED IN COLOR WITH WHITE LETTERING AND A WHITE BOARDER. 11"x14" WITH 4" ADDRESS LETTERING AND $1-\frac{1}{2}$ " LETTERING FOR 'S.G.F.P.D.'

FIRE DISTRICT SIGN DETAIL


SUGAR GROVE FIRE PROTECTION DISTRICT (S.G.F.P.D.)


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	WILLS BURKE KELSEY ASSOCIATES LTD.	l
WBK	116 West Main Street, Suite 201 St. Charles, Illinois 60174	Ī
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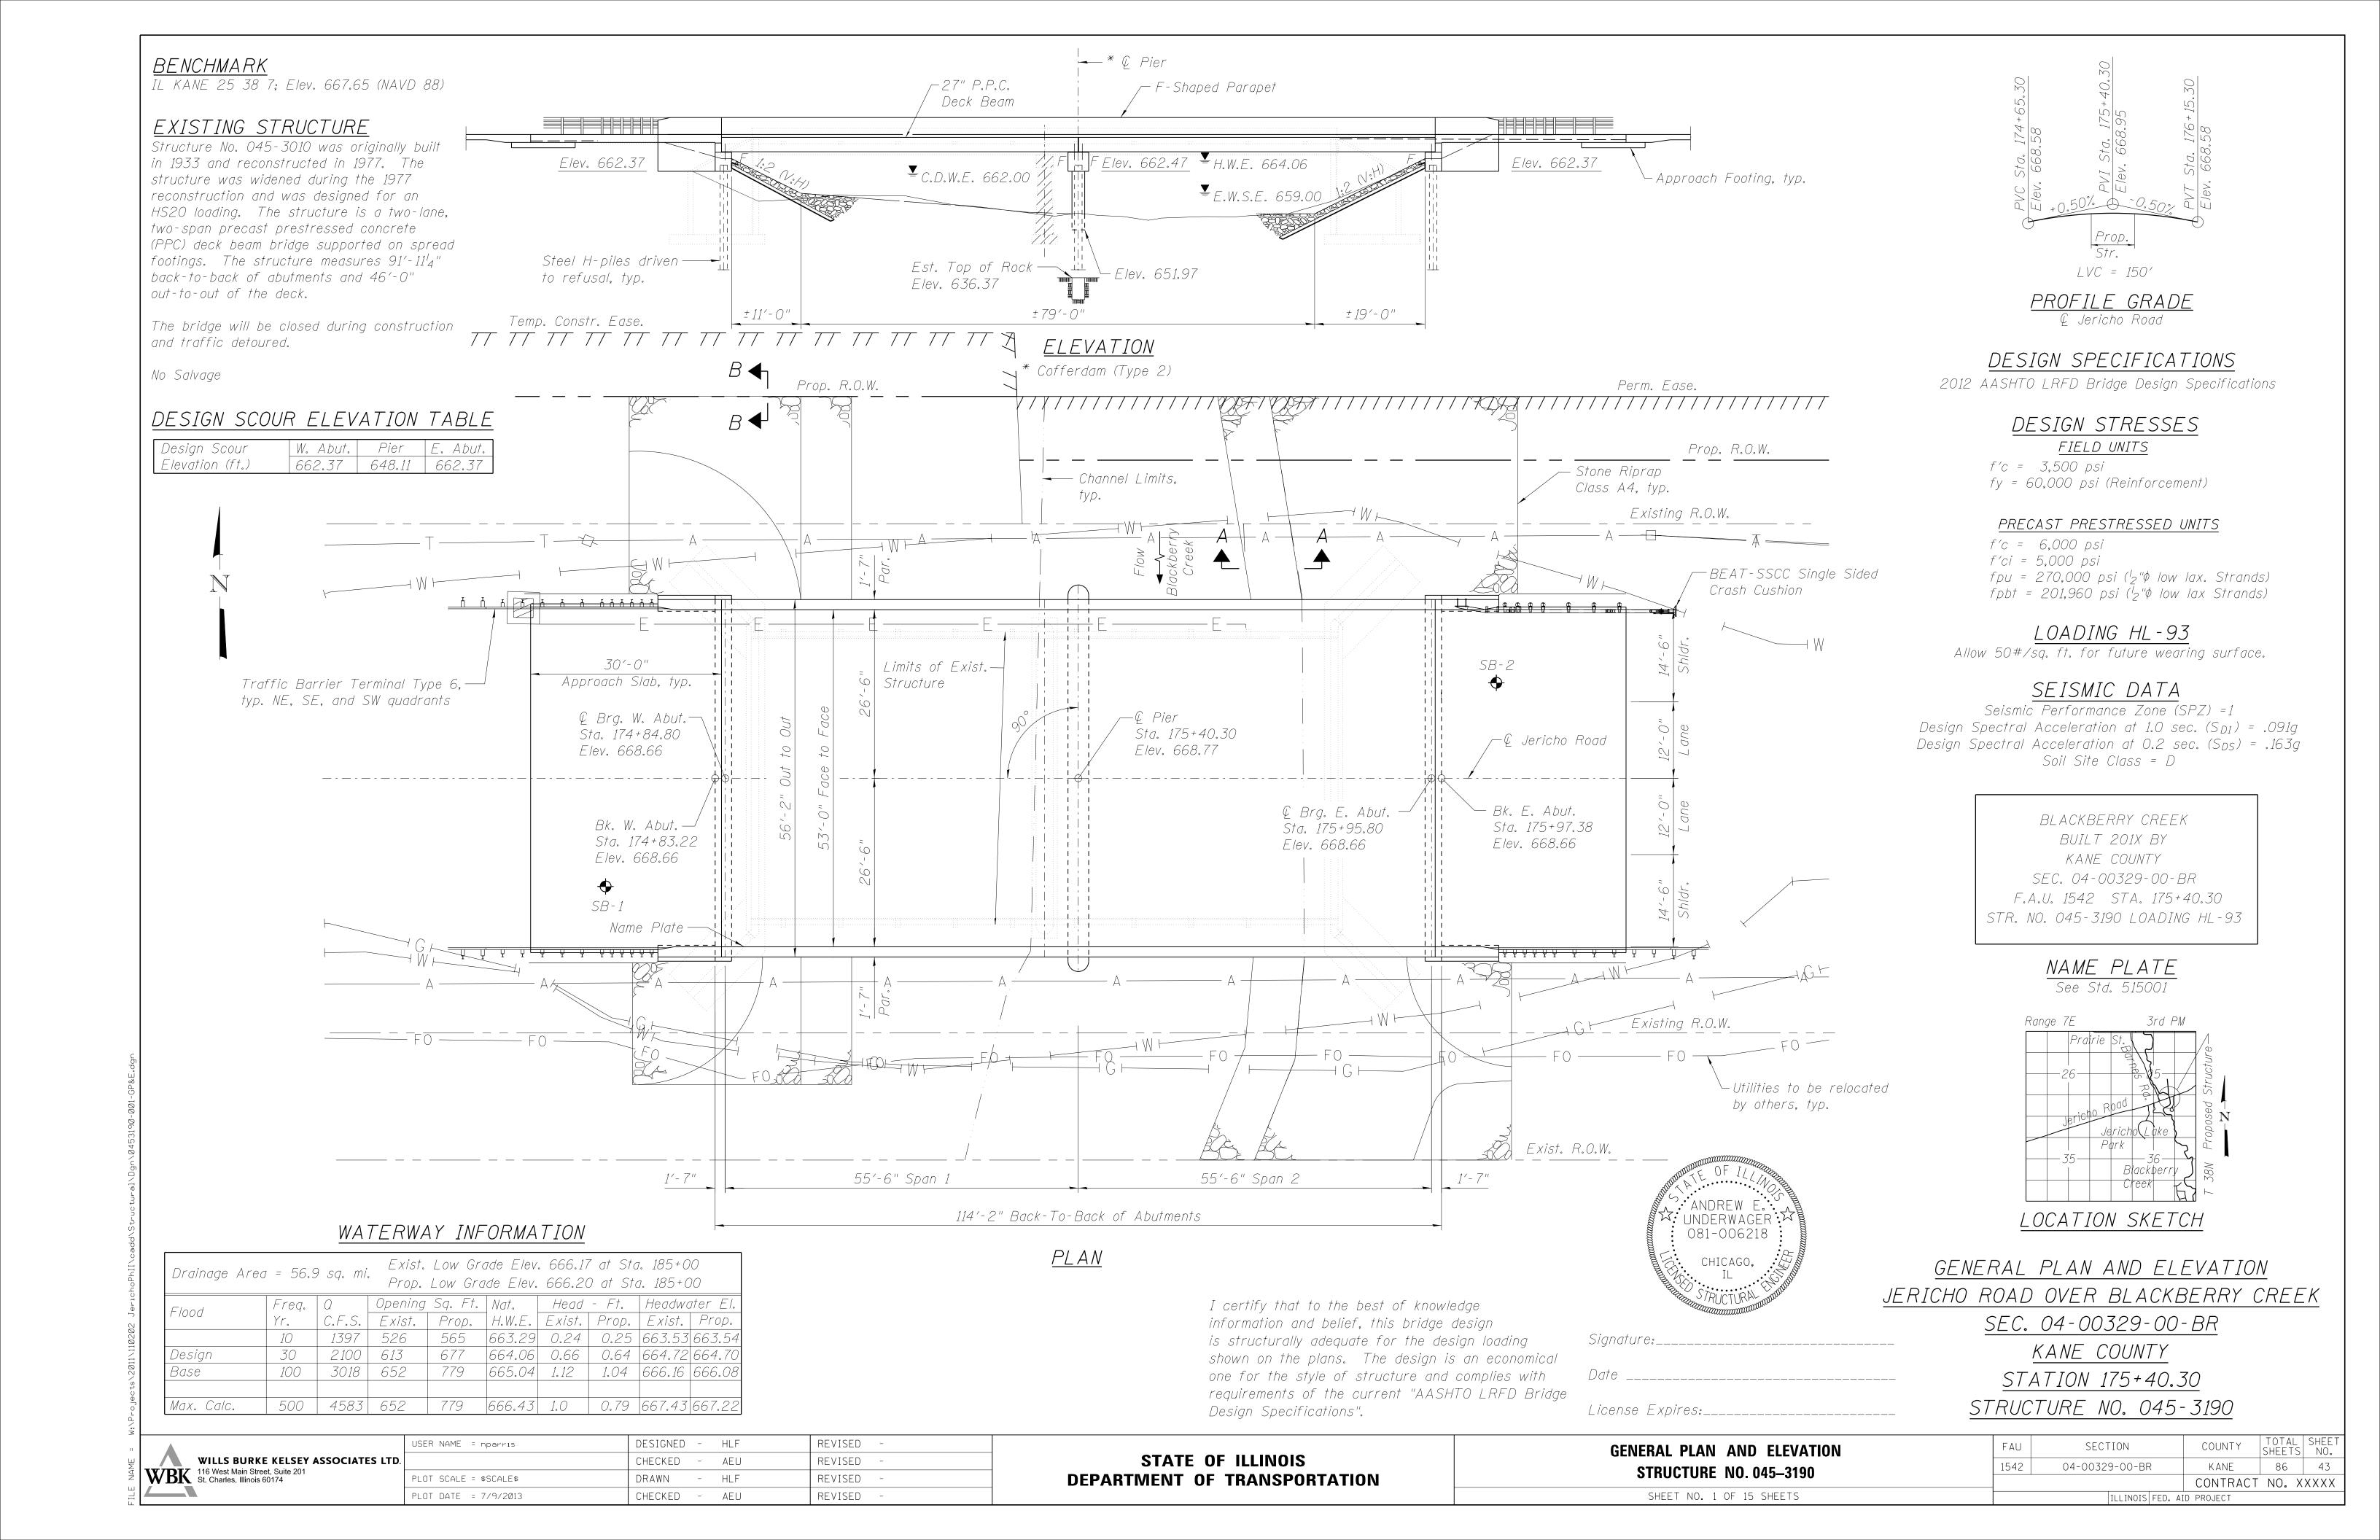
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PLOT SCALE = 1:20	CHECKED -	REVISED -
PLOT DATE = 7/9/2013	DATE -	REVISED -

STATE OF ILLINOIS **DEPARTMENT OF TRANSPORTATION**

PAVEMENT MARKING	F.A.U. RTE.	SECTION	COUNTY	TOTAL SHEETS	SHEET NO.
& SIGNING PLAN	1542	04-00329-00-BR	KANE	86	40
& Sidiville I LAIV			CONTRACT	NO.	
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GENERAL NOTES

Reinforcement bars designated (E) shall be epoxy coated.

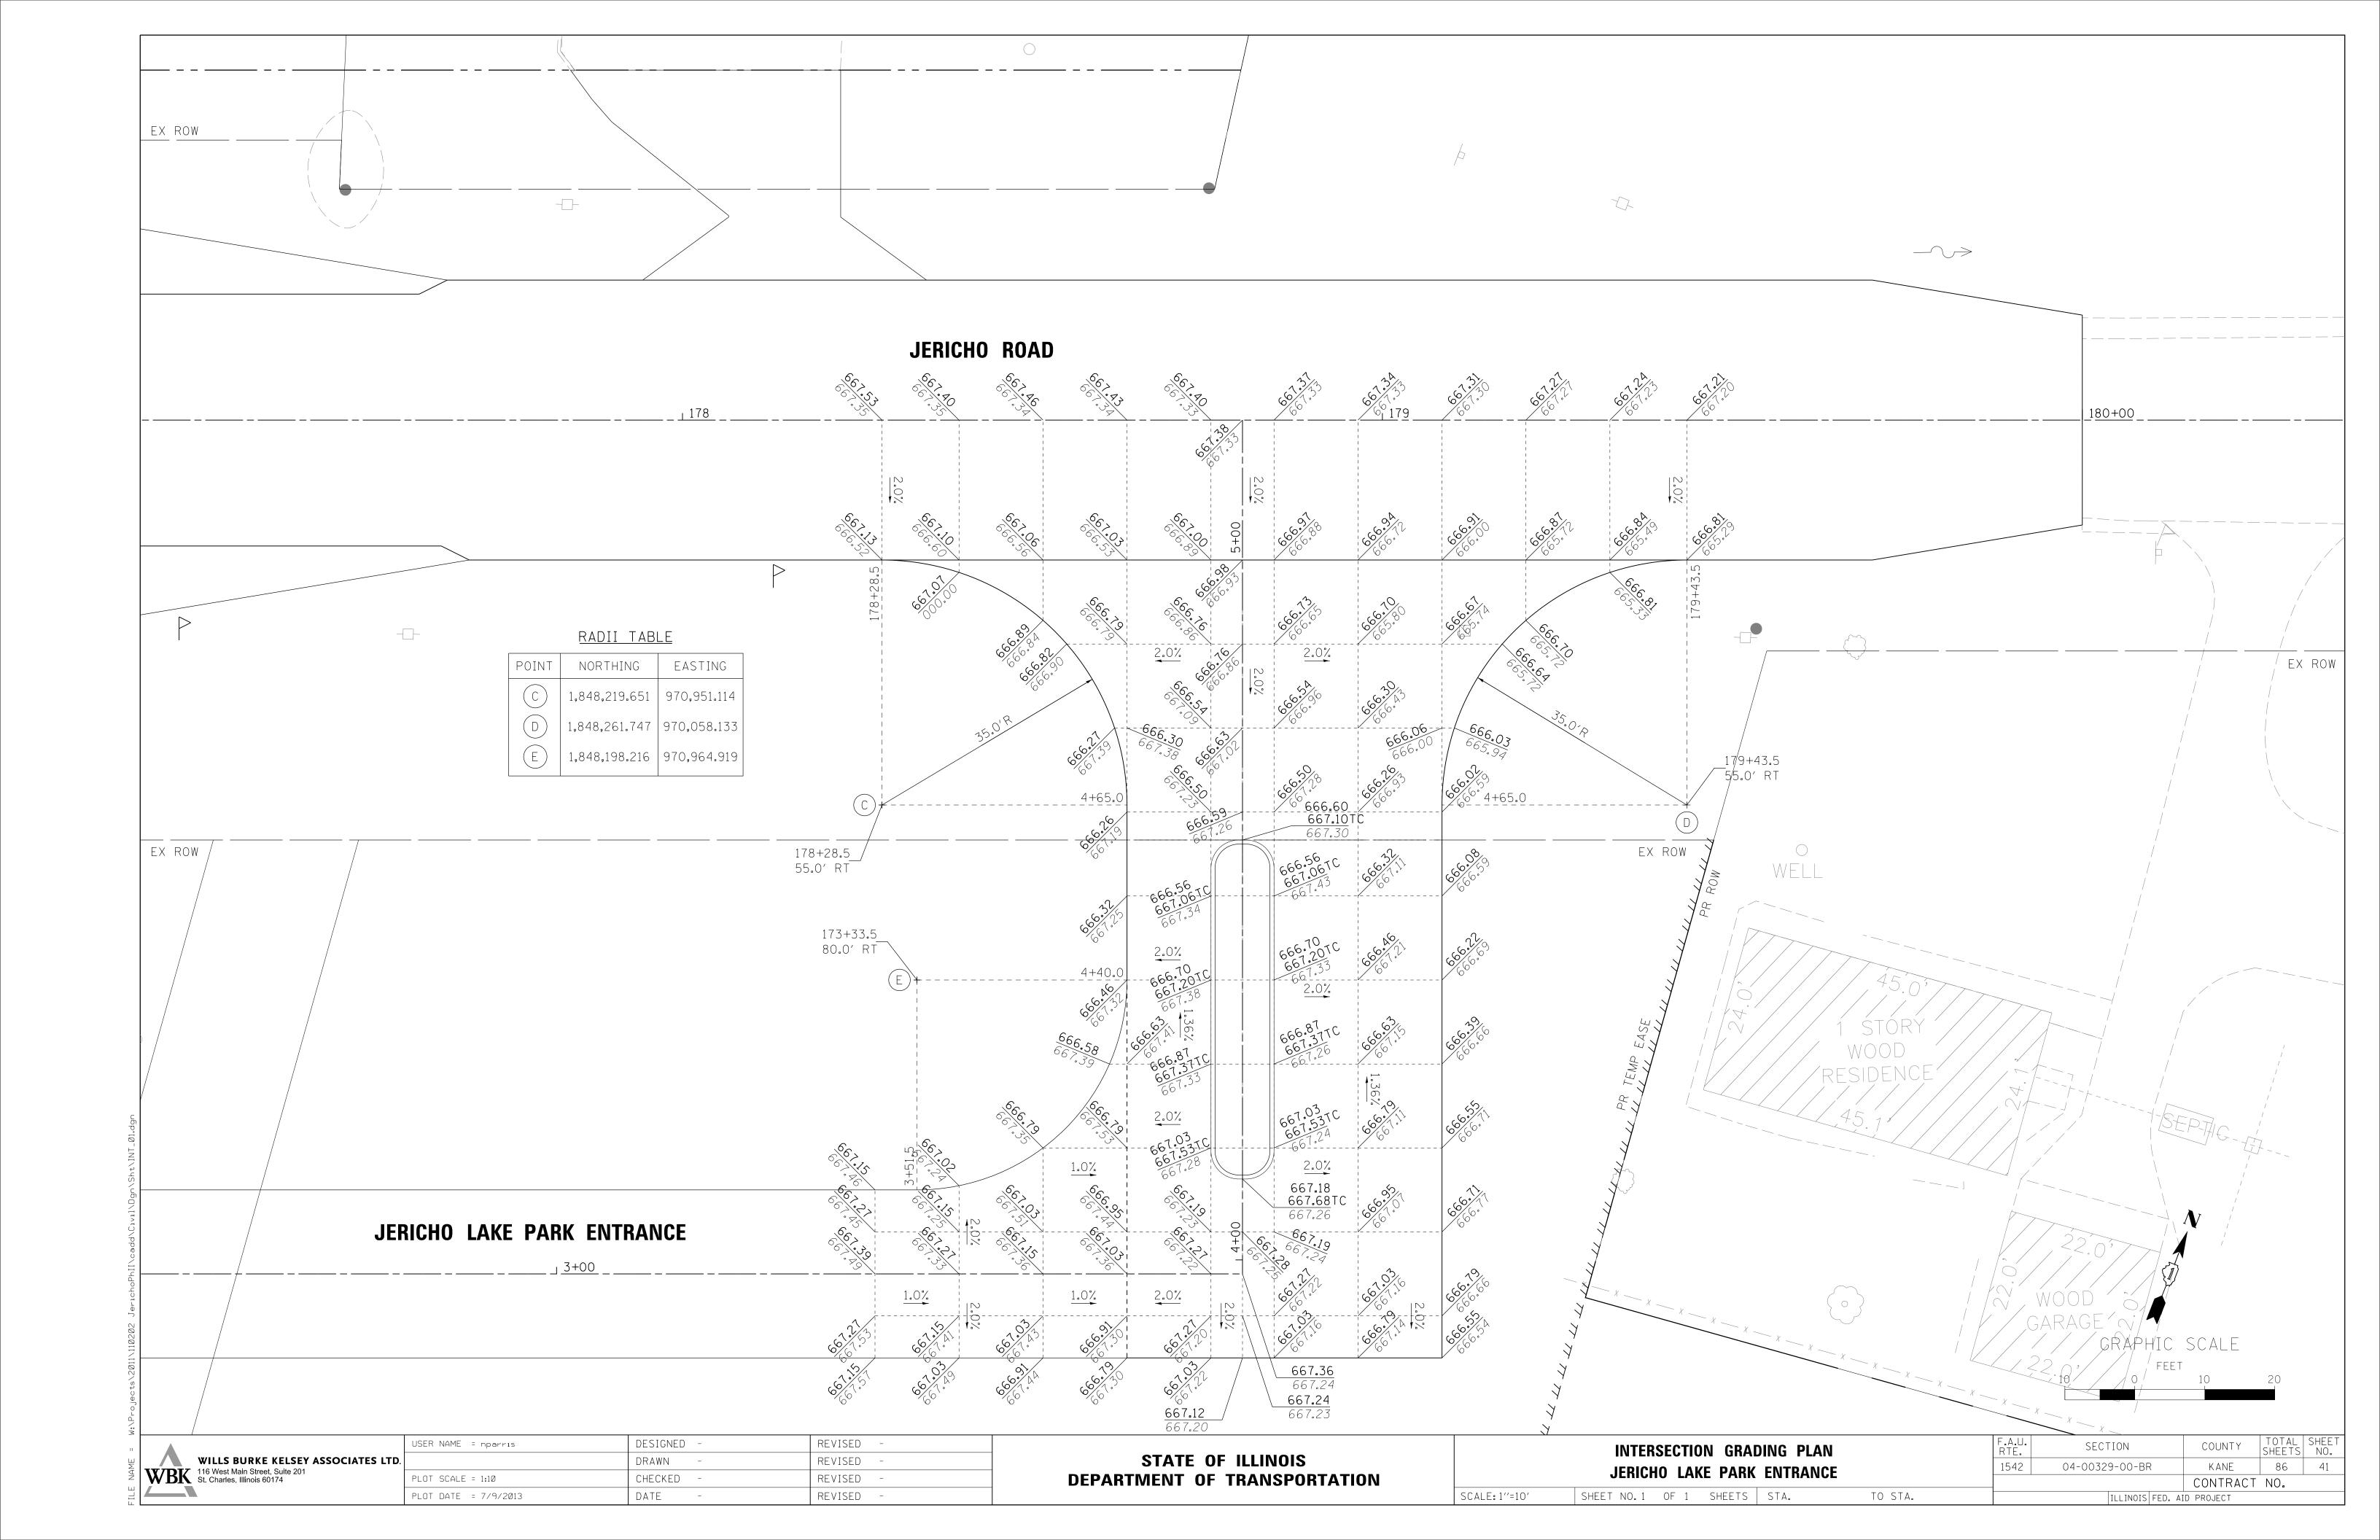Seal coat thickness design is based on the Estimated Water Surface Elevation (EWSE). Cofferdam design details and proposed changes in seal coat thickness shall be submitted to the Engineer for approval with the cofferdam design.

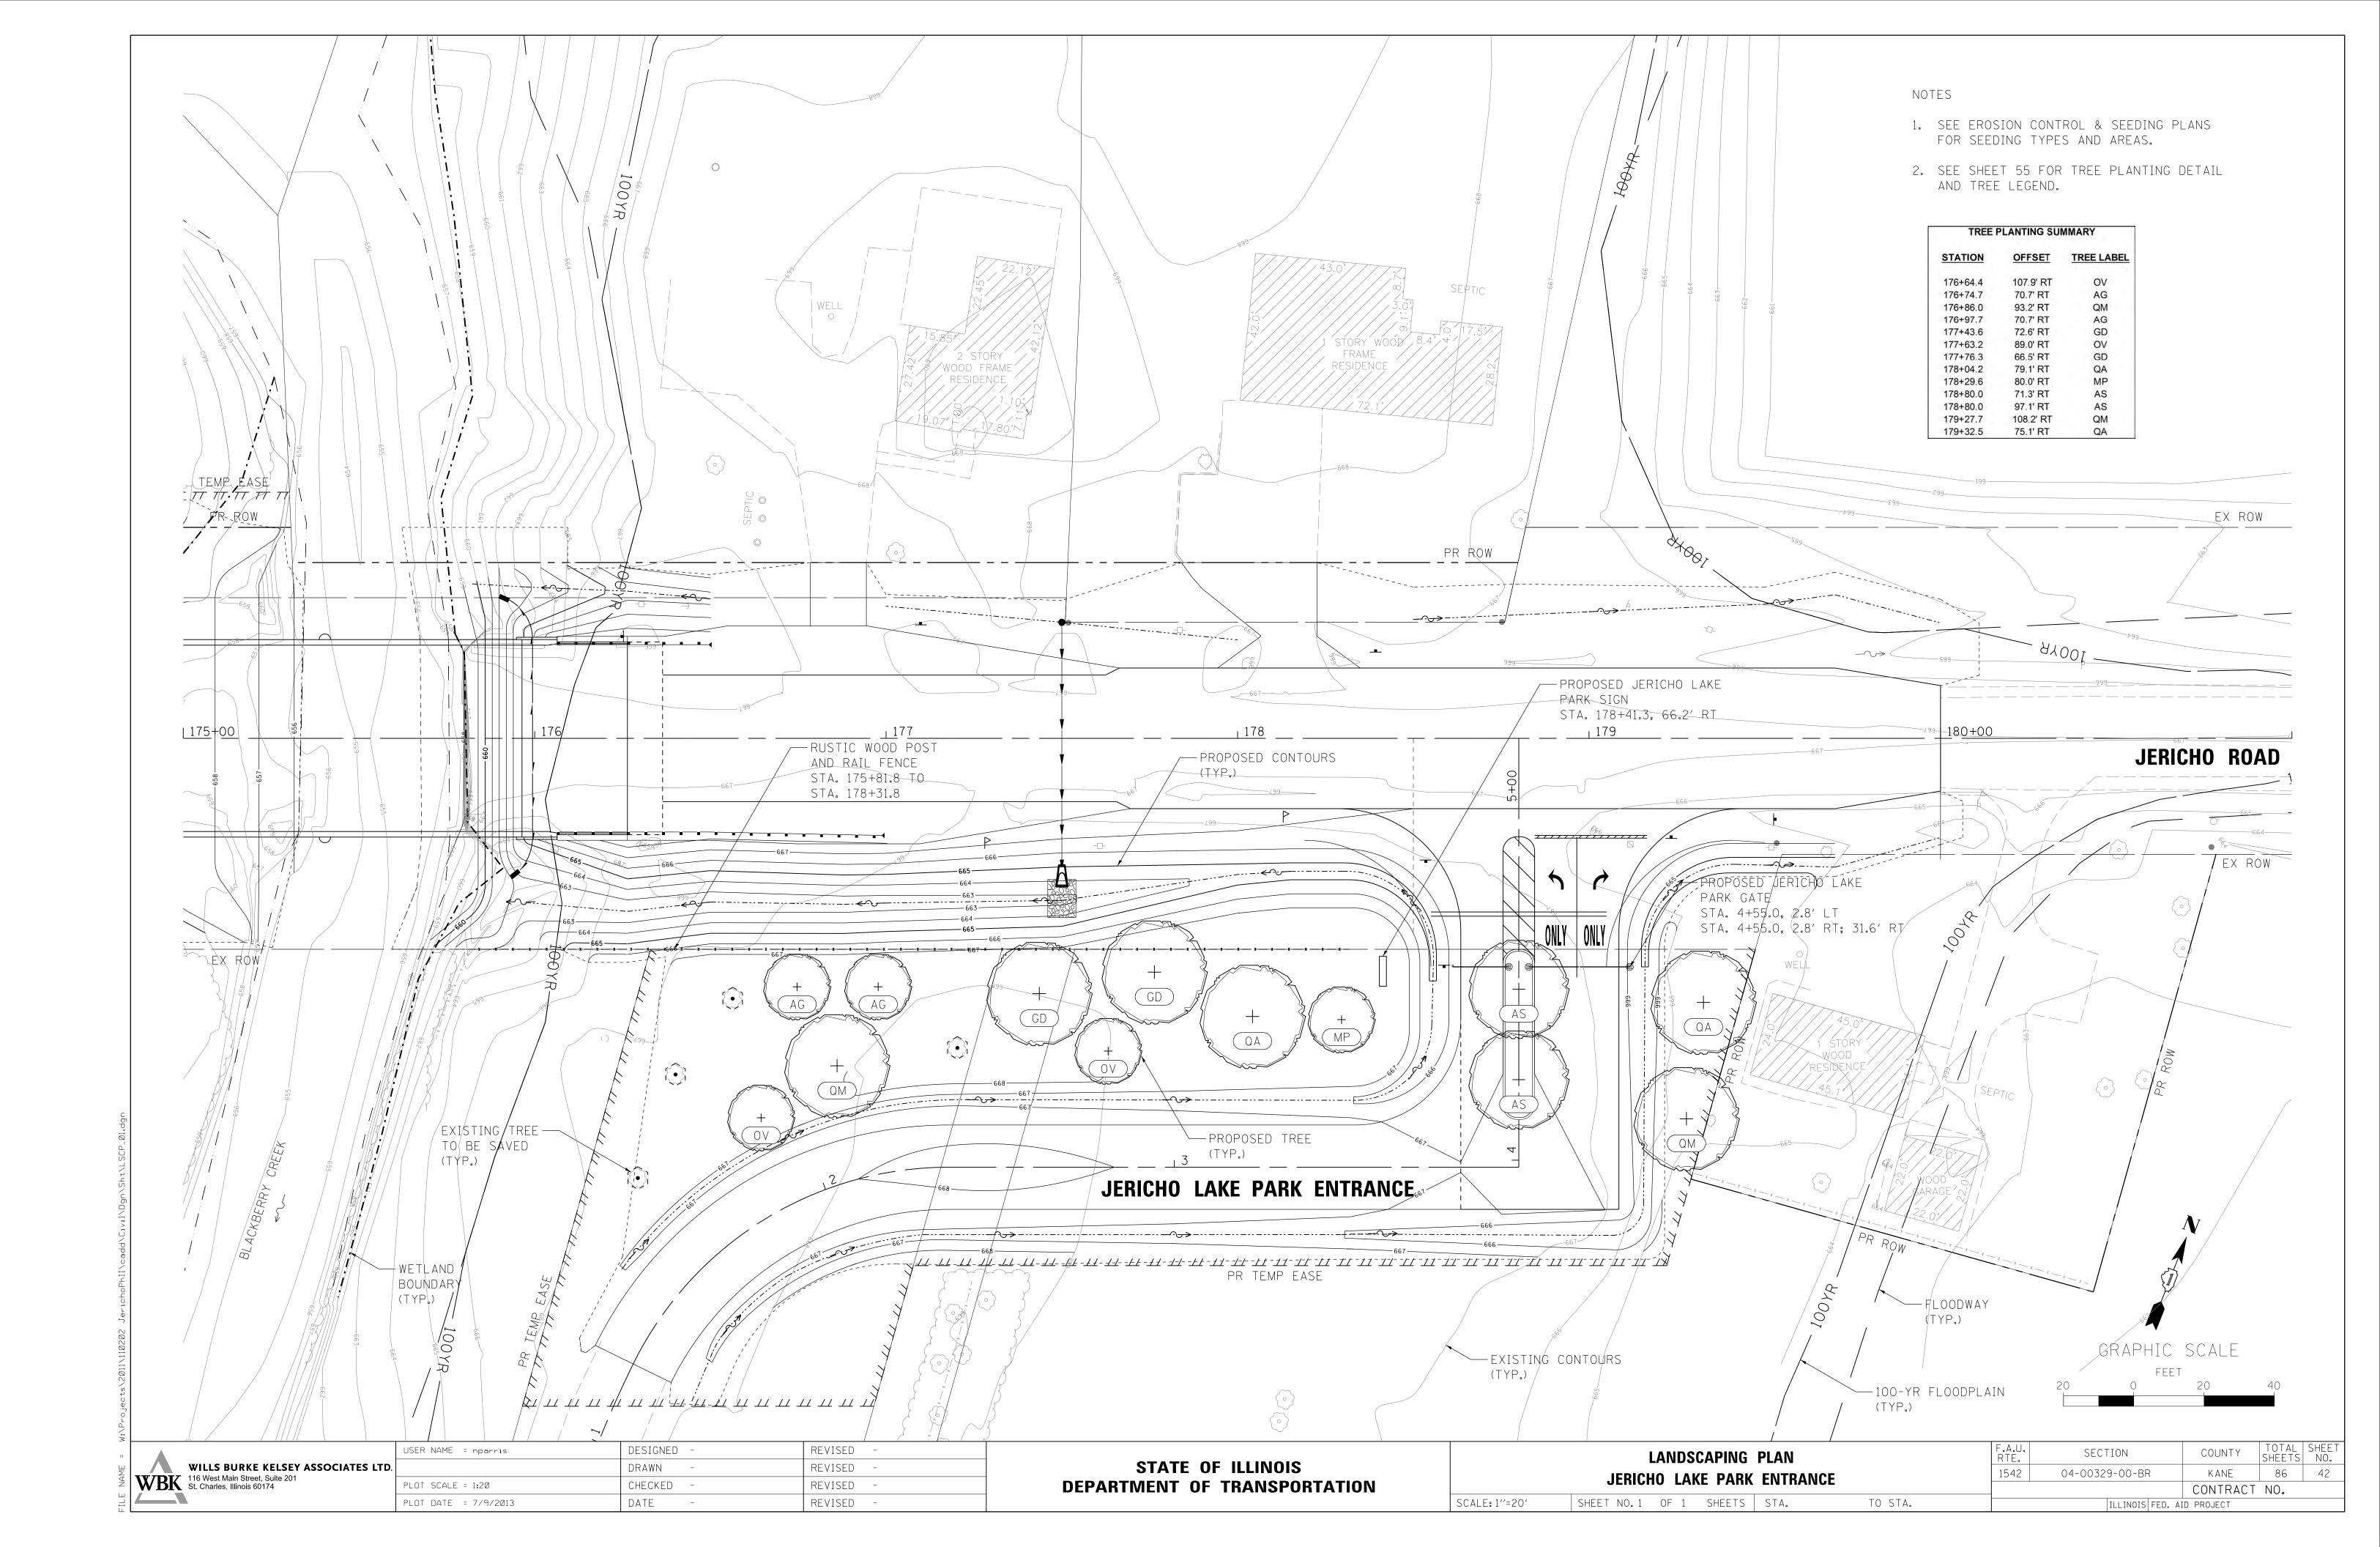Layout of slope protection system may be varied in the field to suit ground conditions as directed by the Engineer.

The Contractor is advised that the existing structure contains memebers that are in a deteriorated condition with reduced load carrying capacity. It is the Contractor's responsibility to account for the condition of the existing structure when developing construction procedures for the complete or partial removal or replacement of the structure.

If the Contractor's procedures for existing deck beam removal involves placement of heavy equipment on the existing deck beams, a detailed procedure shall be submitted to the Engineer for approval. The procedure shall include calculations, sealed by an Illinois Licensed Structural Engineer, verifying the structural adequacy of the beams for the proposed loads. Cost included with Removal of Existing Structures.

Slipforming of the parapets is not allowed.

Granular Backfill (See Special Provisions) Concrete Wearing Surface, 5" min. Approach slab Fabric ₄ $^\prime$ bearing pad . Wall Drain $\frac{1'' \times 2 \frac{1}{2}''}{(full\ width)}$ Excavation is paid for as , Structure Excavation *Geotechnical Fabric for French Drains *Drainage Aggregate *4'' \phi Perforated \rangle pipe underdrain 2'-0'' Bk. of Abut.

SECTION THRU ABUTMENT


*Included in the cost of Pipe Underdrains for Structures. (See Special Provisions)

Note:

All drainage system components shall extend parallel to the abutment back wall until they intersect the wingwalls or 2'-0" from the end of the wingwalls when the wings are parallel to the abutment. The pipe shall extend under the wingwall, if necessary, until intersecting the side slopes. The pipes shall drain into concrete headwalls. (See Article 601.05 of the Standard Specifications and Highway Standard 601101).

INDEX OF SHEETS

- 1. General Plan and Elevation
- 2. General Data
- 3. Top of West Approach Slab Elevations
- 4. Top of East Approach Slab Elevations
- 5. Superstructure
- 6. Superstructure Details
- 7. Bridge Approach Slab Details (1 of 2)
- 8. Bridge Approach Slab Details (2 of 2)
- 9. 27"x48" PPC Deck Beam
- 10. 27"x48" PPC Deck Beam Details
- 11. Abutments
- 12. Abutment Details
- 13. Pier
- 14. HP Pile Details
- 15. Soil Boring Logs

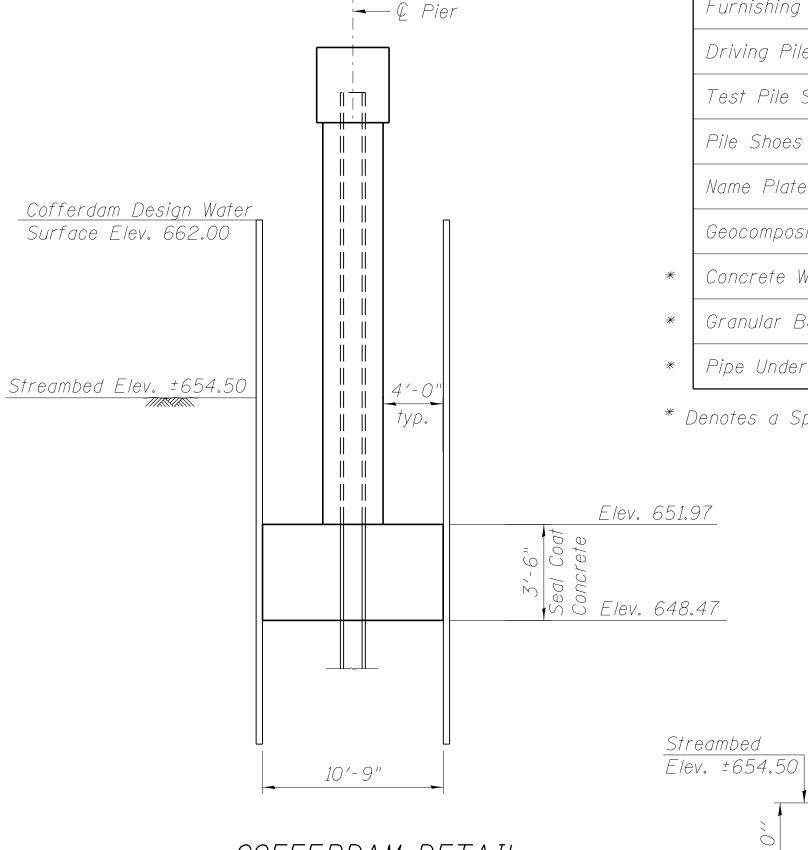

COFFERDAM DETAIL


Note:

A water surface elevation of 662.00 will be the basis of the cofferdam design. It is the Contractors responsibility to provide a design for the cofferdam, verification of seal coat thickness shown and all other required appurtenances, subject to approval of the Engineer. Plan dimensions of cofferdam are 10'-9" x 68'-2".


TOTAL BILL OF MATERIAL

ITEM	UNIT	SUPER	SUB	TOTAL
Stone Riprap, Class A4	Sq. Yd.		869	869
Filter Fabric	Sq. Yd.		869	869
Removal of Existing Structures	Each			1
Structure Excavation	Cu. Yd.		186	186
Cofferdam Excavation	Cu. Yd.		163	163
Cofferdam (Type 2) (Location-1)	Each		1	1
Concrete Structures	Cu. Yd.		187.4	187.3
Concrete Superstructure	Cu. Yd.	175.0		175.0
Bridge Deck Grooving	Sq. Yd.	994		994
Seal Coat Concrete	Cu. Yd.		95	95
Concrete Encasement	Cu. Yd.		8.4	8.4
Protective Coat	Sq. Yd.	1,793		1,793
Precast Prestressed Concrete Deck Beams 27"	Sq. Ft.	6,277		6,277
Reinforcement Bars, Epoxy Coated	Pound	58,860	15,300	74,160
Furnishing Steel Piles HP 12X53	Foot		996	996
Driving Piles	Foot		996	996
Test Pile Steel HP 12X53	Each		2	2
Pile Shoes	Each		36	36
Name Plate	Each		1	1
Geocomposite Wall Drain	Sq. Yd.		78	78
Concrete Wearing Surface, 5"	Sq. Yd.	698		698
Granular Backfill for Structures	Cu. Yd.		95	95
Pipe Underdrain for Structures 4"	Foot		178	178

* Denotes a Special Provision

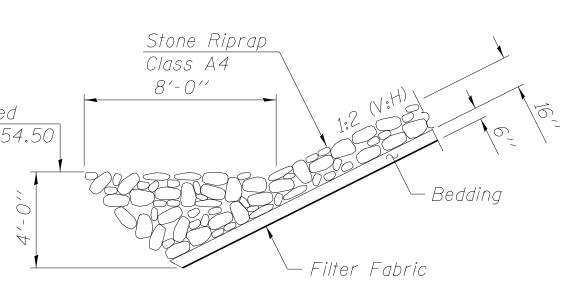

SECTION A-A

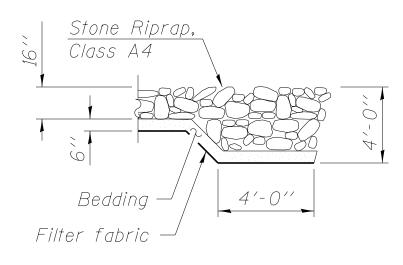

SECTION B-B


WILLS BURKE KELSEY ASSOCIATES LTD. WBK 116 West Main Street, Suite 201 St. Charles, Illinois 60174

	USER NAME = nparris	DESIGNED	-	HLF	REVISED	-
•		CHECKED	-	AEU	REVISED	-
	PLOT SCALE = \$SCALE\$	DRAWN	-	HLF	REVISED	-
	PLOT DATE = 7/9/2013	CHECKED	-	AEU	REVISED	-

STATE OF ILLINOIS DEPARTMENT OF TRANSPORTATION

S		ENE TUR				NTA 045–3190	
	SHEET	NO.	2	OF	15	SHEETS	

AU	SECTION		COUNTY	TOTAL SHEETS	SHE
542	04-00329-00-BR		KANE	86	4
			CONTRACT	NO. X	XXX
	ILLINOIS FED.	AID) PROJECT		

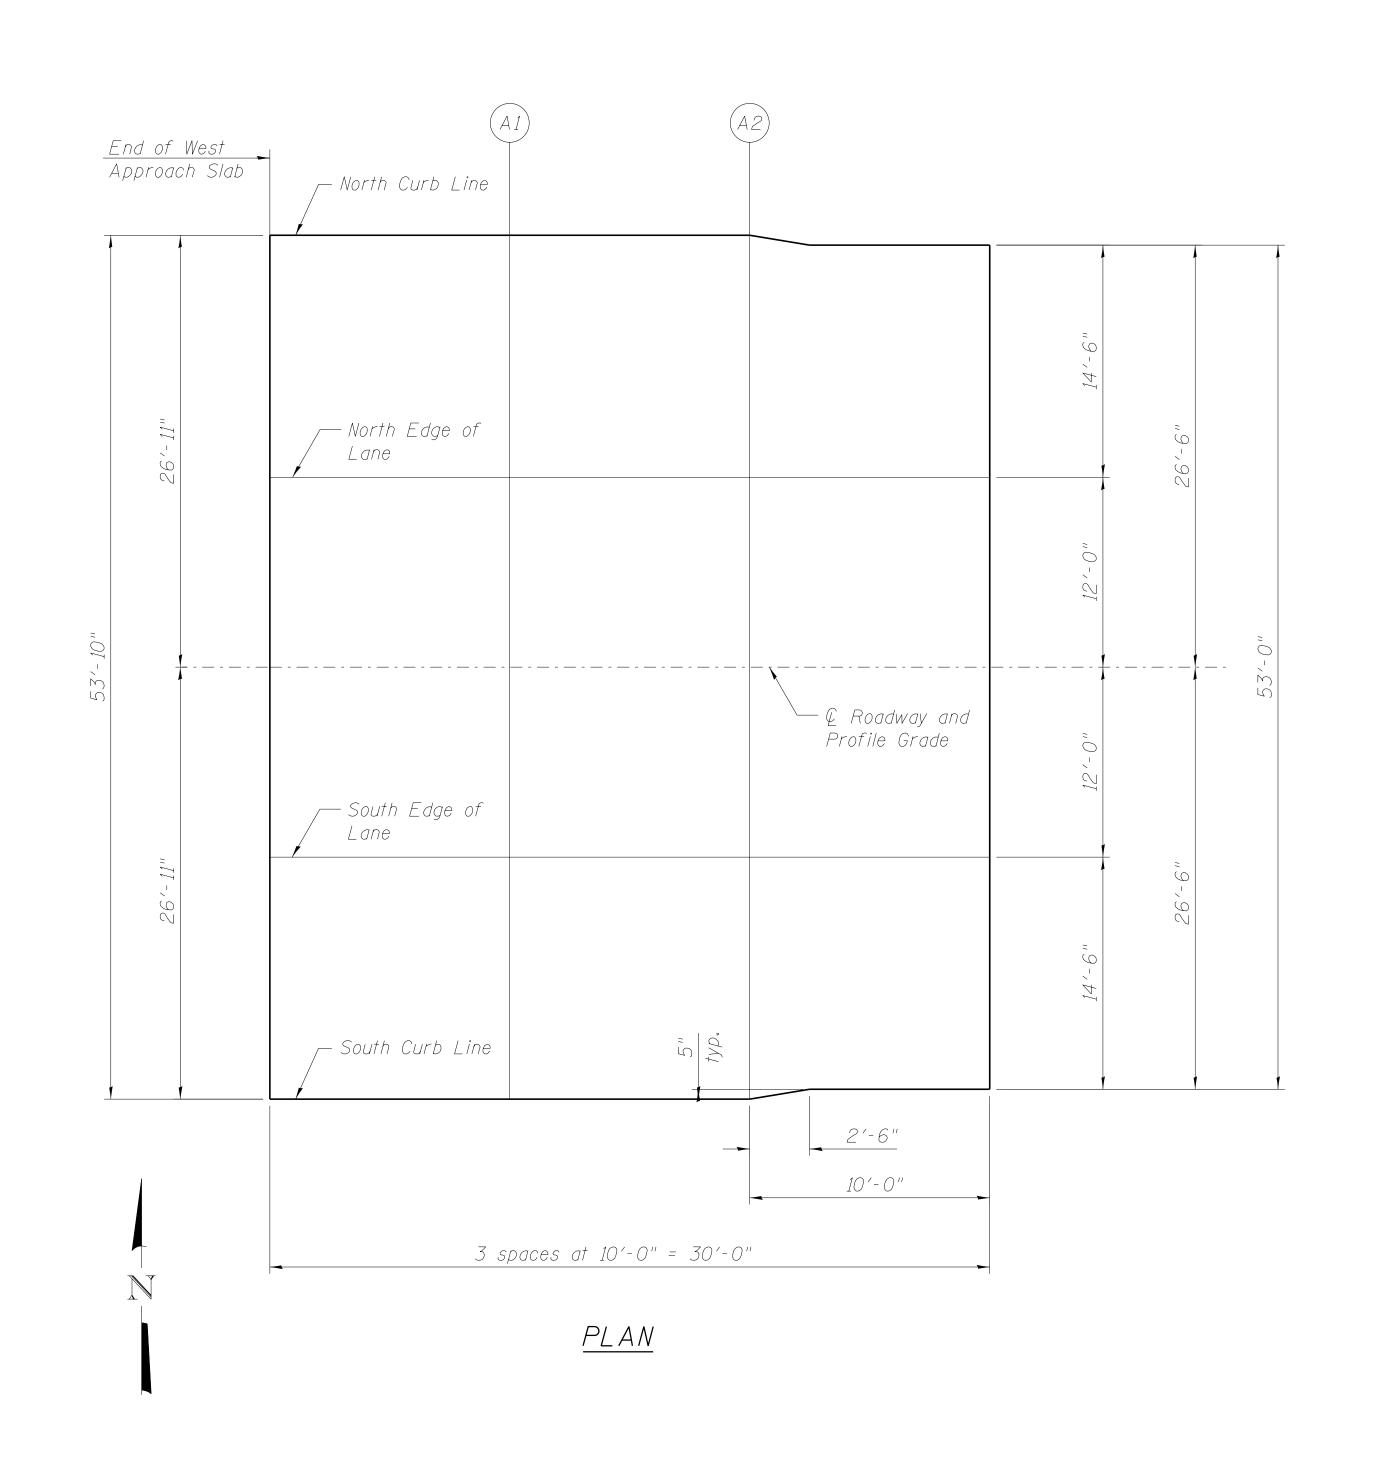

© ROADWAY & P.G.

		•	
Location	Station	Offset	Theoretical Grade Elevations
End W. Appr. Slab	174+54.22	0.00	668.52
A 1 A 2	174+64.22 174+74.22	0.00	668.57 668.62
Begin W. Appr. Slab	174+84.22	0.00	668.66

NORTH CURB LINE

Location	Station	Offset	Theoretical Grade Elevations
End W. Appr. Slab	174+54.22	-26.92	668.10
A 1 A 2	174+64.22 174+74.22	-26.92 -26.92	668.15 668.20
Begin W. Appr. Slab	174+84.22	-26.50	668.25

NORTH EDGE OF LANE

Location	Station	Offset	Theoretical Grade Elevations
End W. Appr. Slab	174+54.22	-12.00	668.34
A 1 A 2	174+64.22 174+74.22	-12.00 -12.00	668.39 668.43
Begin W. Appr. Slab	174+84.22	-12.00	668.48

SOUTH EDGE OF LANE

Location	Station	Offset	Theoretical Grade Elevations
End W. Appr. Slab	174+54.22	12.00	668.34
A 1 A 2	174+64.22 174+74.22	12.00 12.00	668.39 668.43
Begin W. Appr. Slab	174+84.22	12.00	668.48


SOUTH CURB LINE

Location	Station	Offset	Theoretical Grade Elevations
End W. Appr. Slab	174+54.22	26.92	668.10
A 1 A 2	174+64.22 174+74.22	26.92 26.92	668.15 668.20
Begin W. Appr. Slab	174+84.22	26.50	668.25

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ļ		WILLS BURKE KELSEY ASSOCIATES LTD.	
	WBK	116 West Main Street, Suite 201 St. Charles, Illinois 60174	
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	USER NAME = nparris	DESIGNED -	HLF	REVISED -	
D.		CHECKED -	AEU	REVISED -	
	PLOT SCALE = \$SCALE\$	DRAWN -	HLF	REVISED -	
	PLOT DATE = 7/9/2013	CHECKED -	AEU	REVISED -	

Ų	SECTION	COUNTY	TOTAL SHEETS	SHEET NO.
42	04-00329-00-BR	KANE	86	45
		CONTRACT	NO. X	XXXX
	ILLINOIS FED. AI	ID PROJECT		

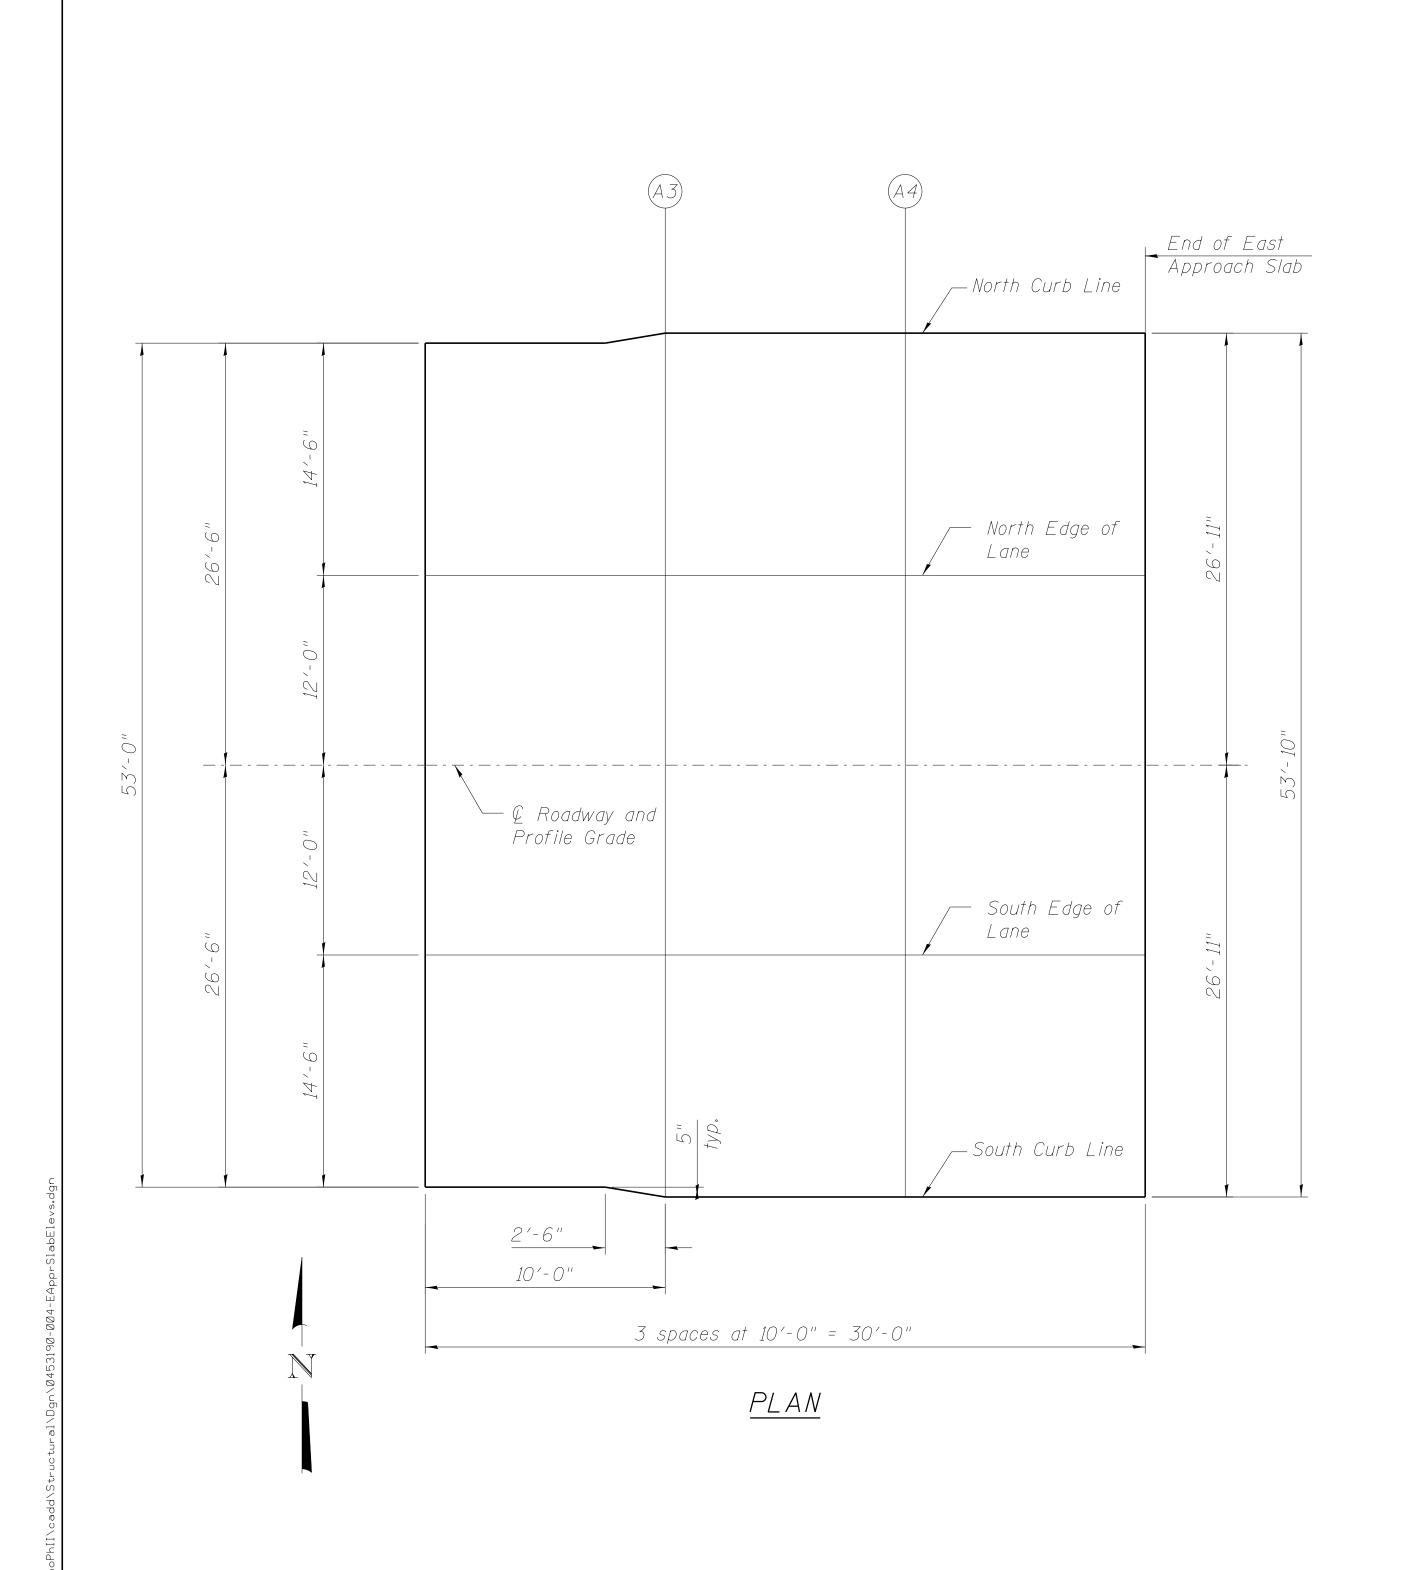

© ROADWAY & P.G.

Location	Station	Offset	Theoretical Grade Elevations
Begin E. Appr. Slab	175+96.38	0.00	668.66
A3 A4	176+06.38 176+16.38	0.00	668.62 668.57
End E. Appr. Slab	176+26.38	0.00	668.52

NORTH CURB LINE

Location	Station	Offset	Theoretical Grade Elevations
Begin E. Appr. Slab	175+96.38	-26.50	668.25
A 3 A 4	176+06.38 176+16.38	-26.92 -26.92	668.20 668.15
End E. Appr. Slab	176+26.38	-26.92	668.10

NORTH EDGE OF LANE

Location	Station	Offset	Theoretical Grade Elevations
Begin E. Appr. Slab	175+96.38	-12.00	668.48
A3 A4	176+06.38 176+16.38	-12.00 -12.00	668.43 668.39
End E. Appr. Slab	176+26.38	-12.00	668.34

SOUTH EDGE OF LANE

Location	Station	Offset	Theoretical Grade Elevations
Begin E. Appr. Slab	175+96.38	12.00	668.48
A 3 A 4	176+06.38 176+16.38	12.00 12.00	668.43 668.39
End E. Appr. Slab	176+26.38	12.00	668.34

SOUTH CURB LINE

Location	Station	Offset	Theoretical Grade Elevations
Begin E. Appr. Slab	175+96.38	26.50	668.25
A 3 A 4	176+06.38 176+16.38	26.92 26.92	668.20 668.15
End E. Appr. Slab	176+26.38	26.92	668.10


WILLS BURKE KELSEY ASSOCIATES LTD.


116 West Main Street, Suite 201
St. Charles, Illinois 60174


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D.		CHECKED -	AEU	REVISED -	
	PLOT SCALE = \$SCALE\$	DRAWN -	HLF	REVISED -	
	PLOT DATE = 7/9/2013	CHECKED -	AEU	REVISED -	

TOP	0F	EAST	APPI	ROA	\CF	1 ;	SLAB	ELEVATIONS	
		STRU	JCTUI	RE	NO). (45–3 1	190	
		SHE	ET NO.	4	OF	15	SHEETS	S	

- AU	SECTION	COUNTY
542	04-00329-00-BR	KANE
		CONTRAC
	ILLINOIS FED. A	ID PROJECT

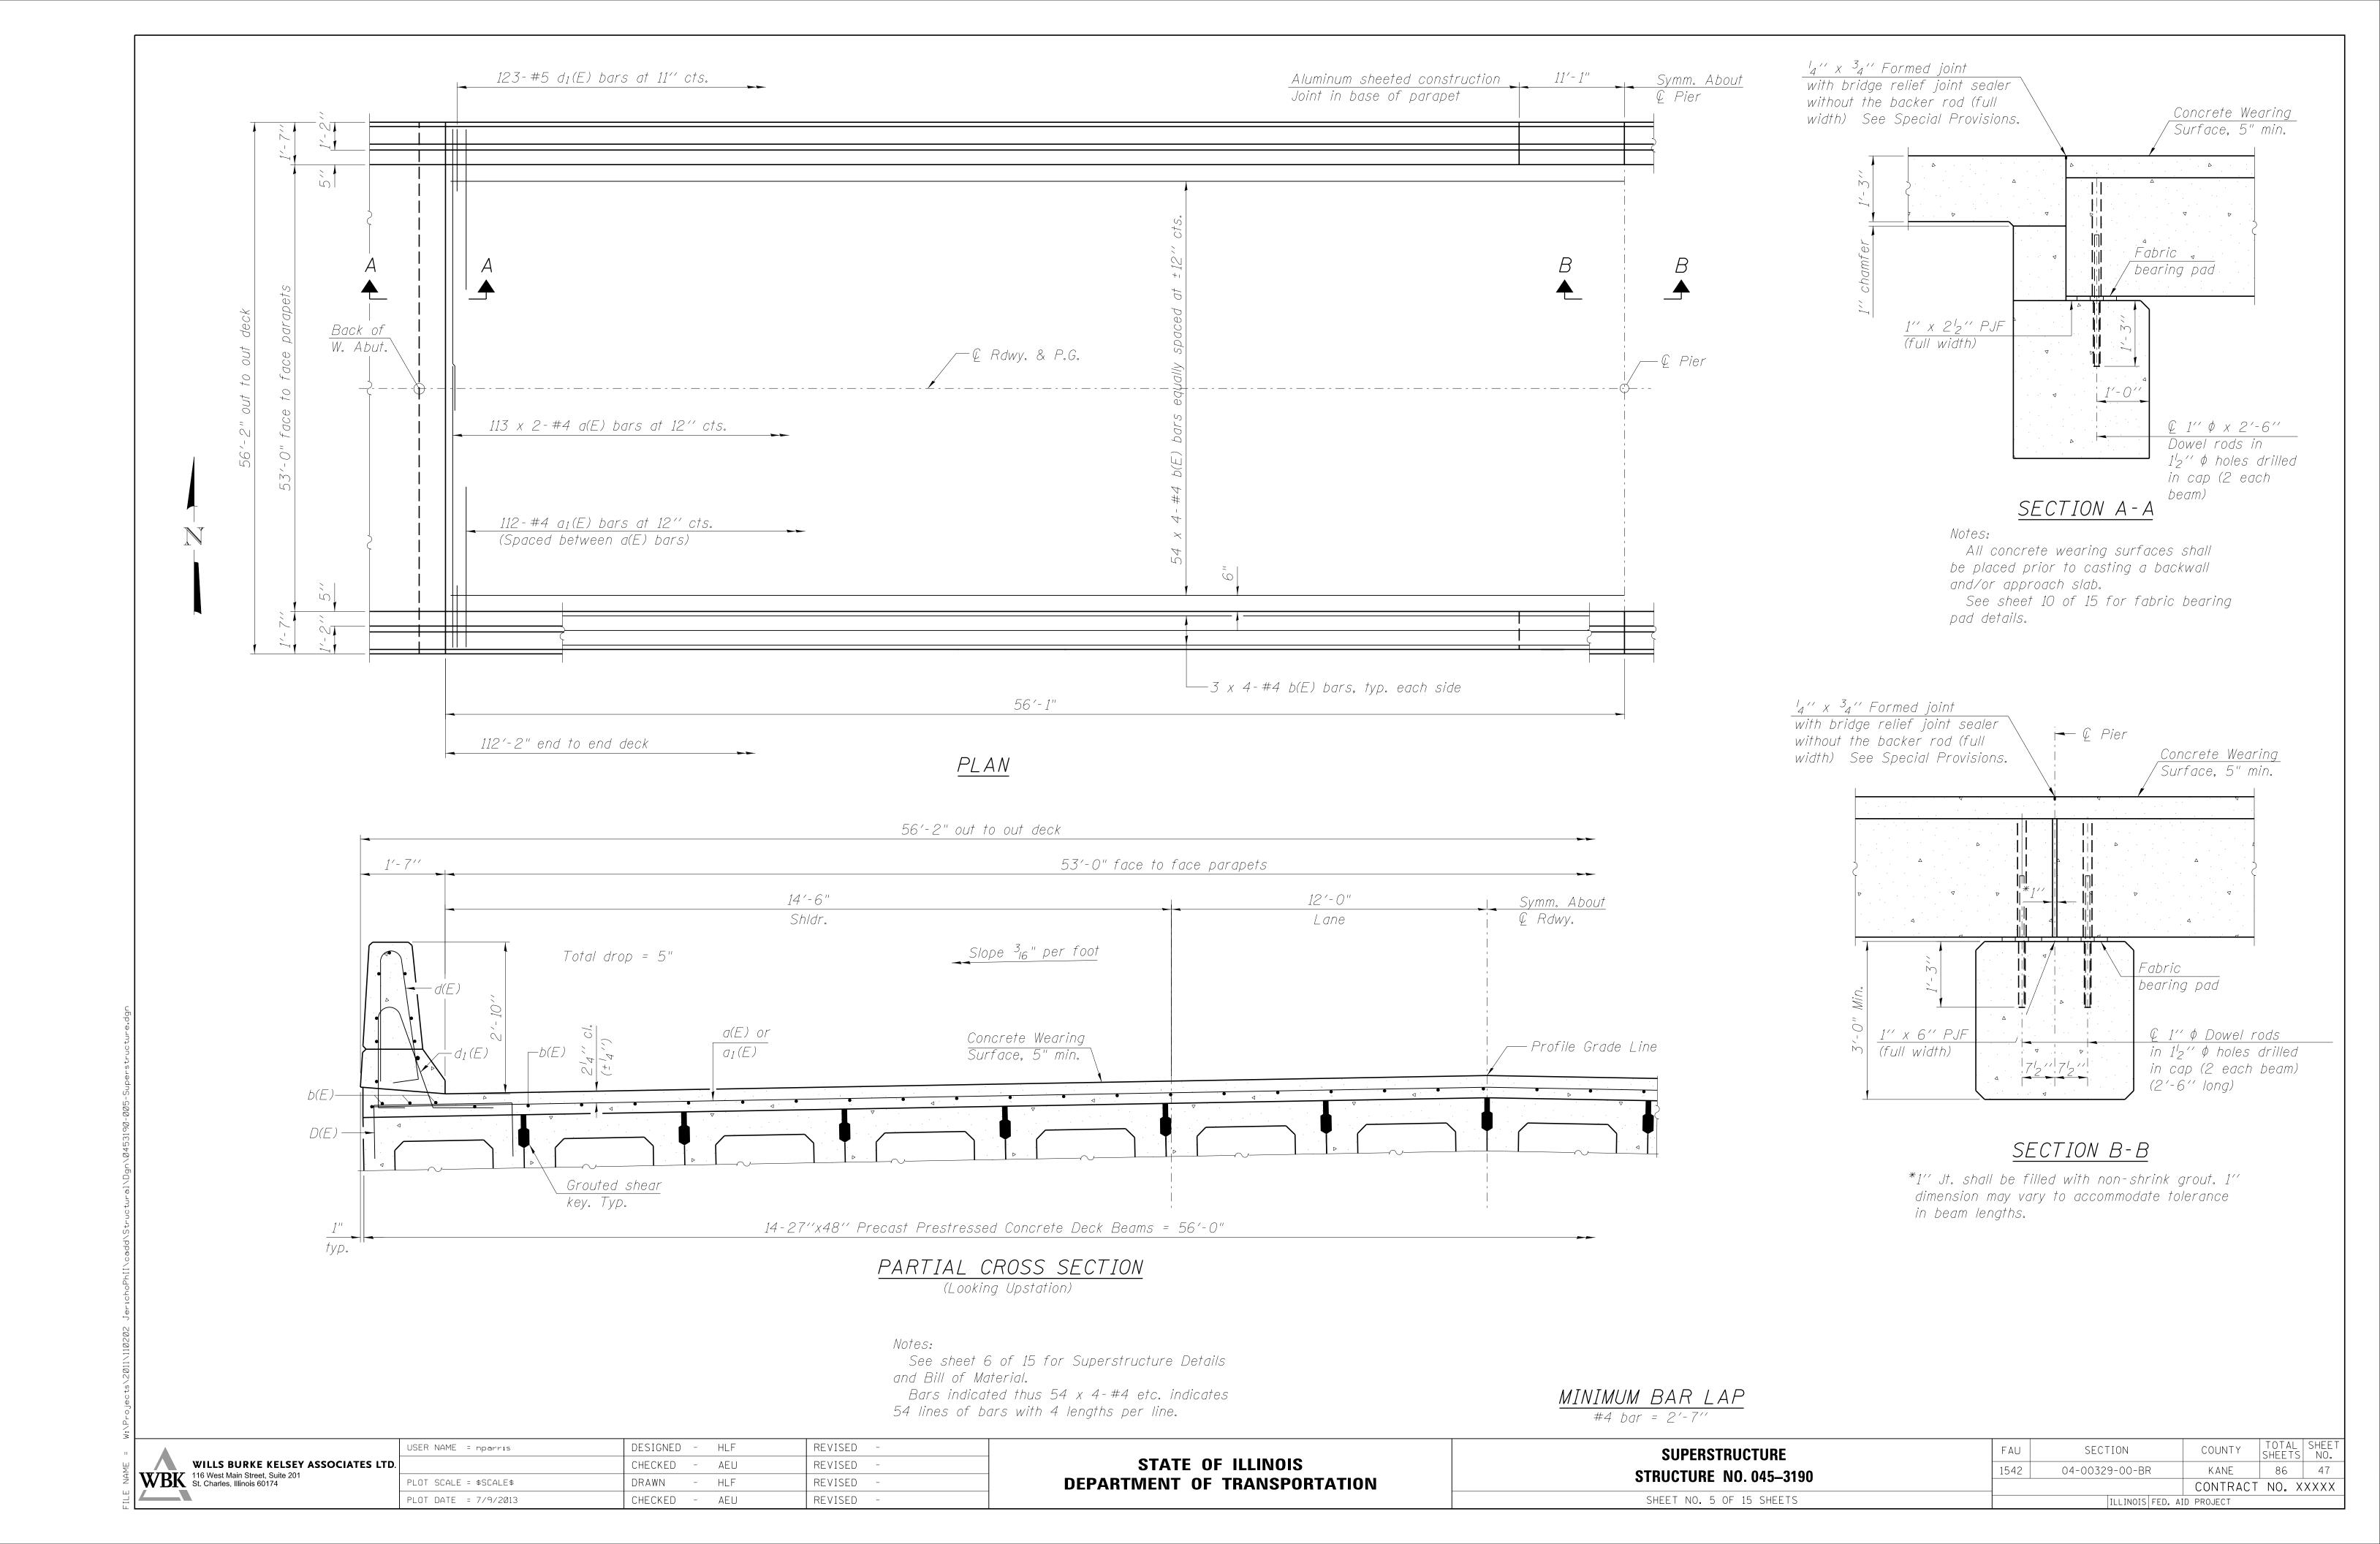


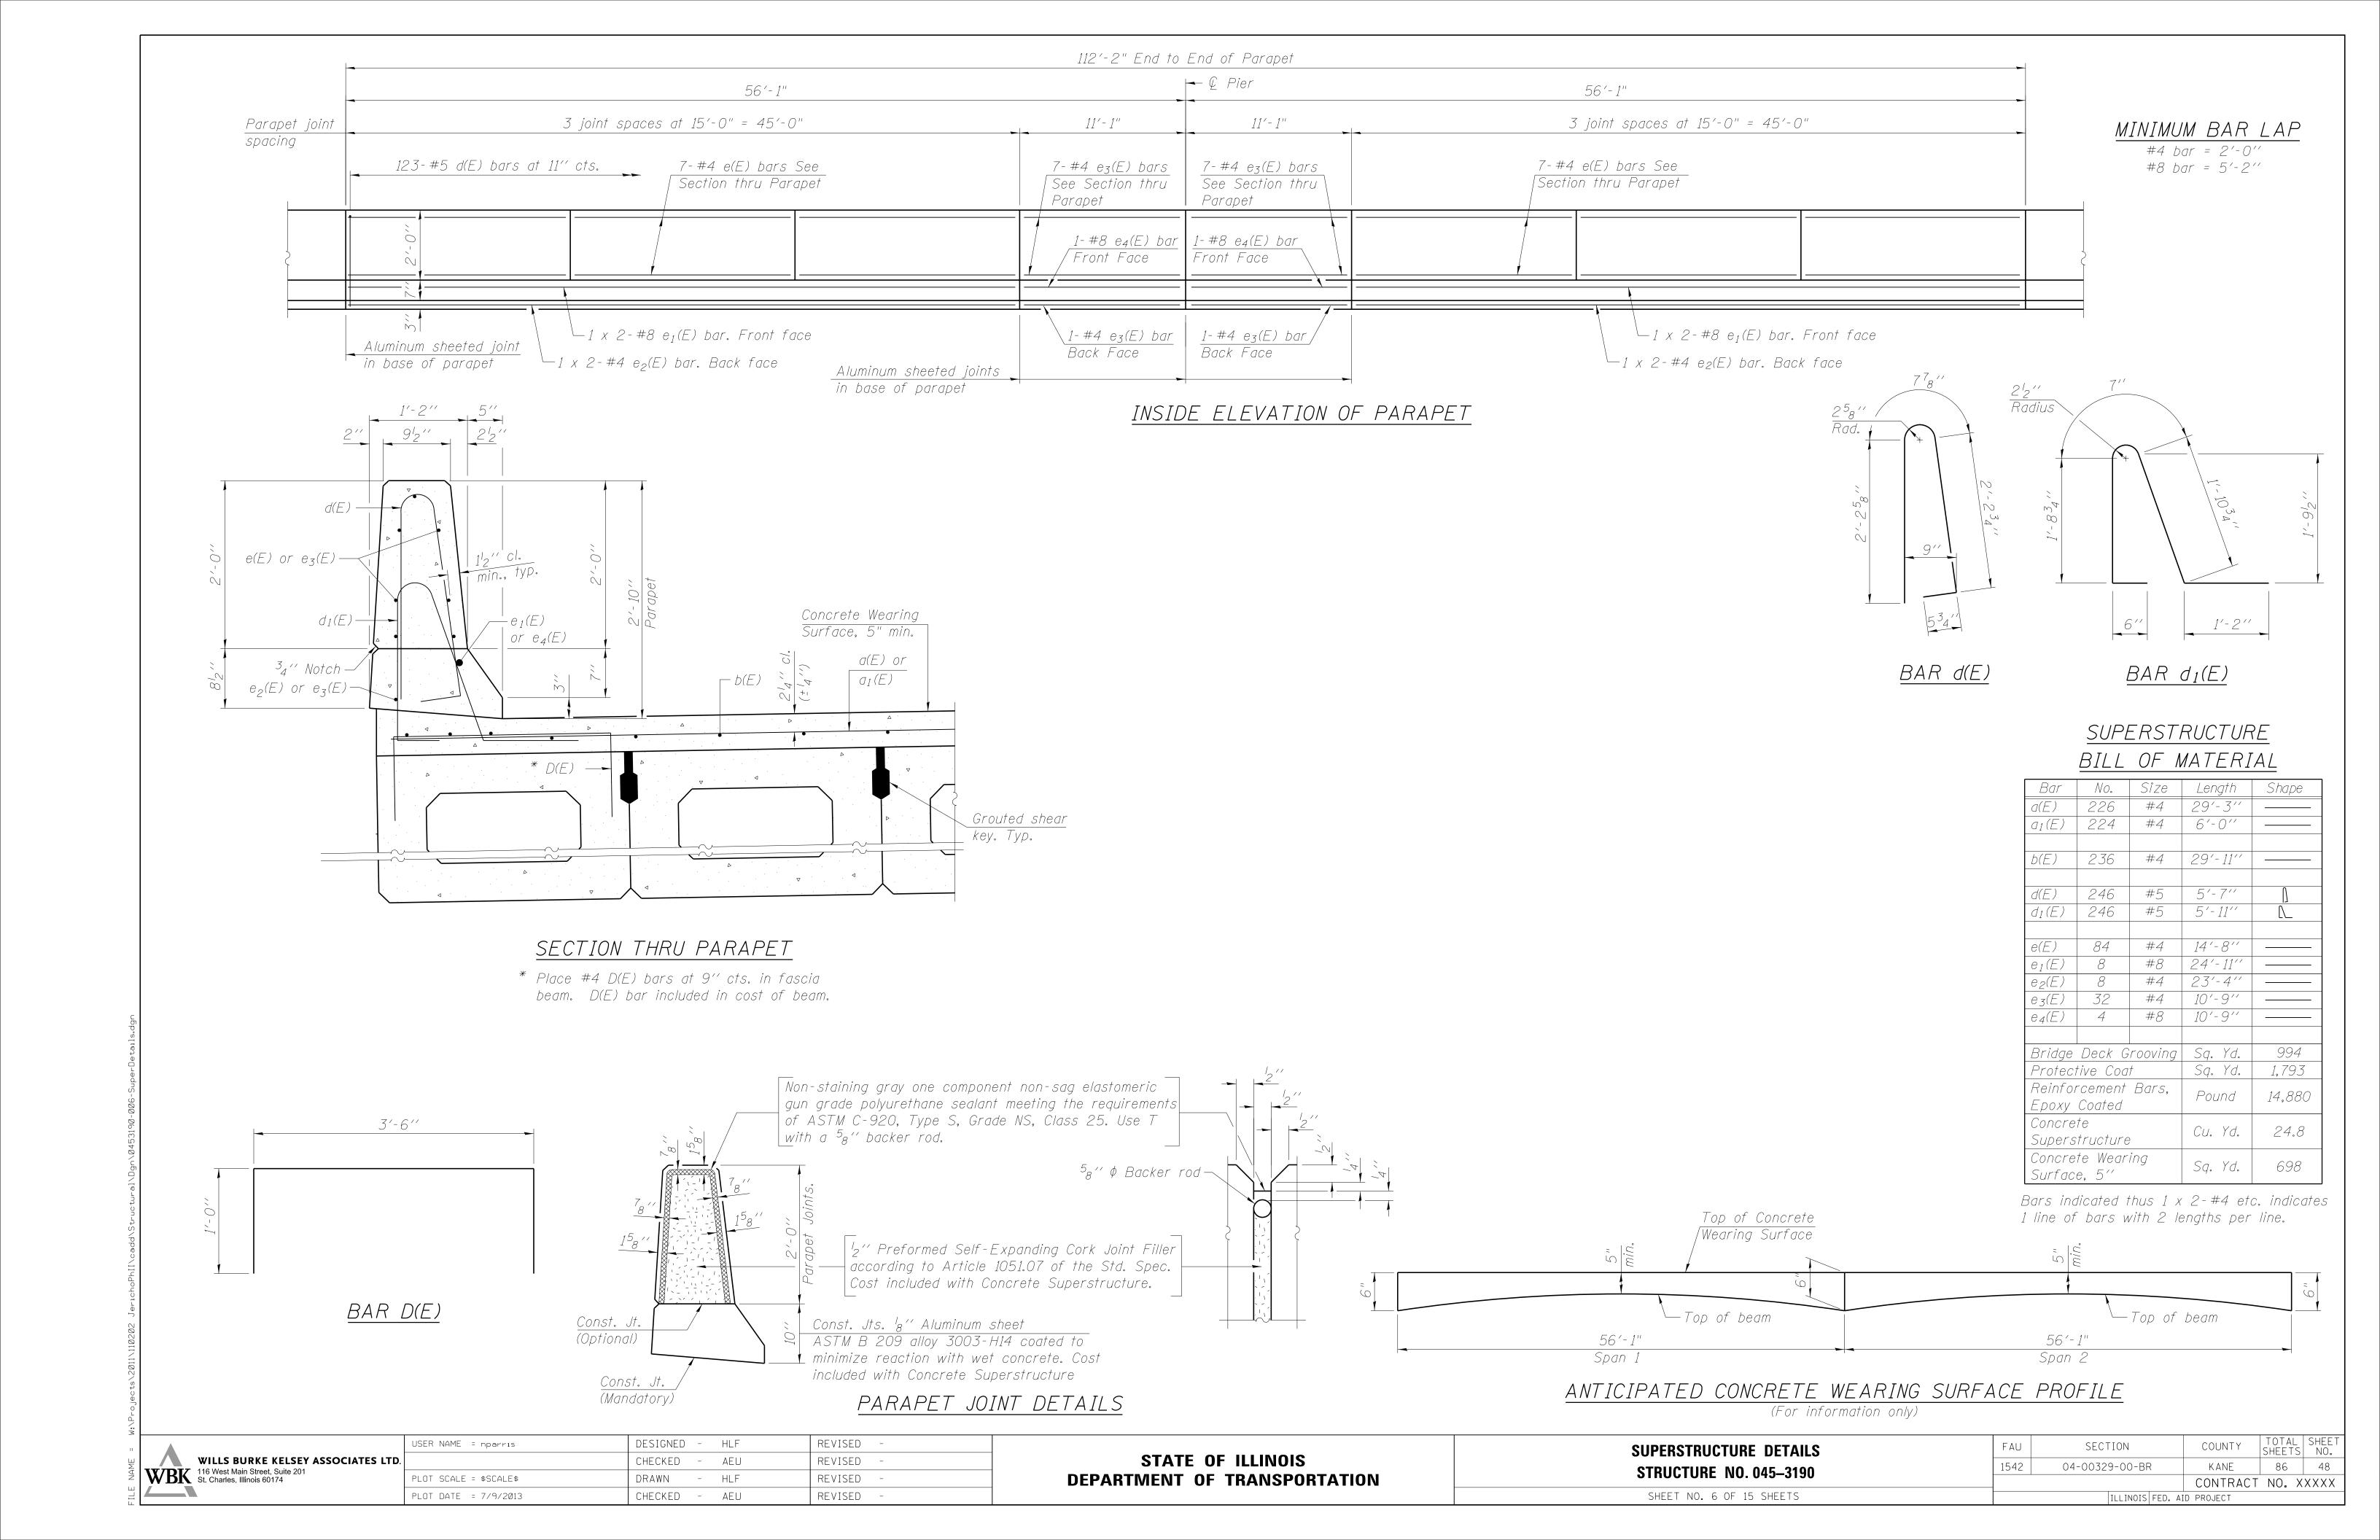

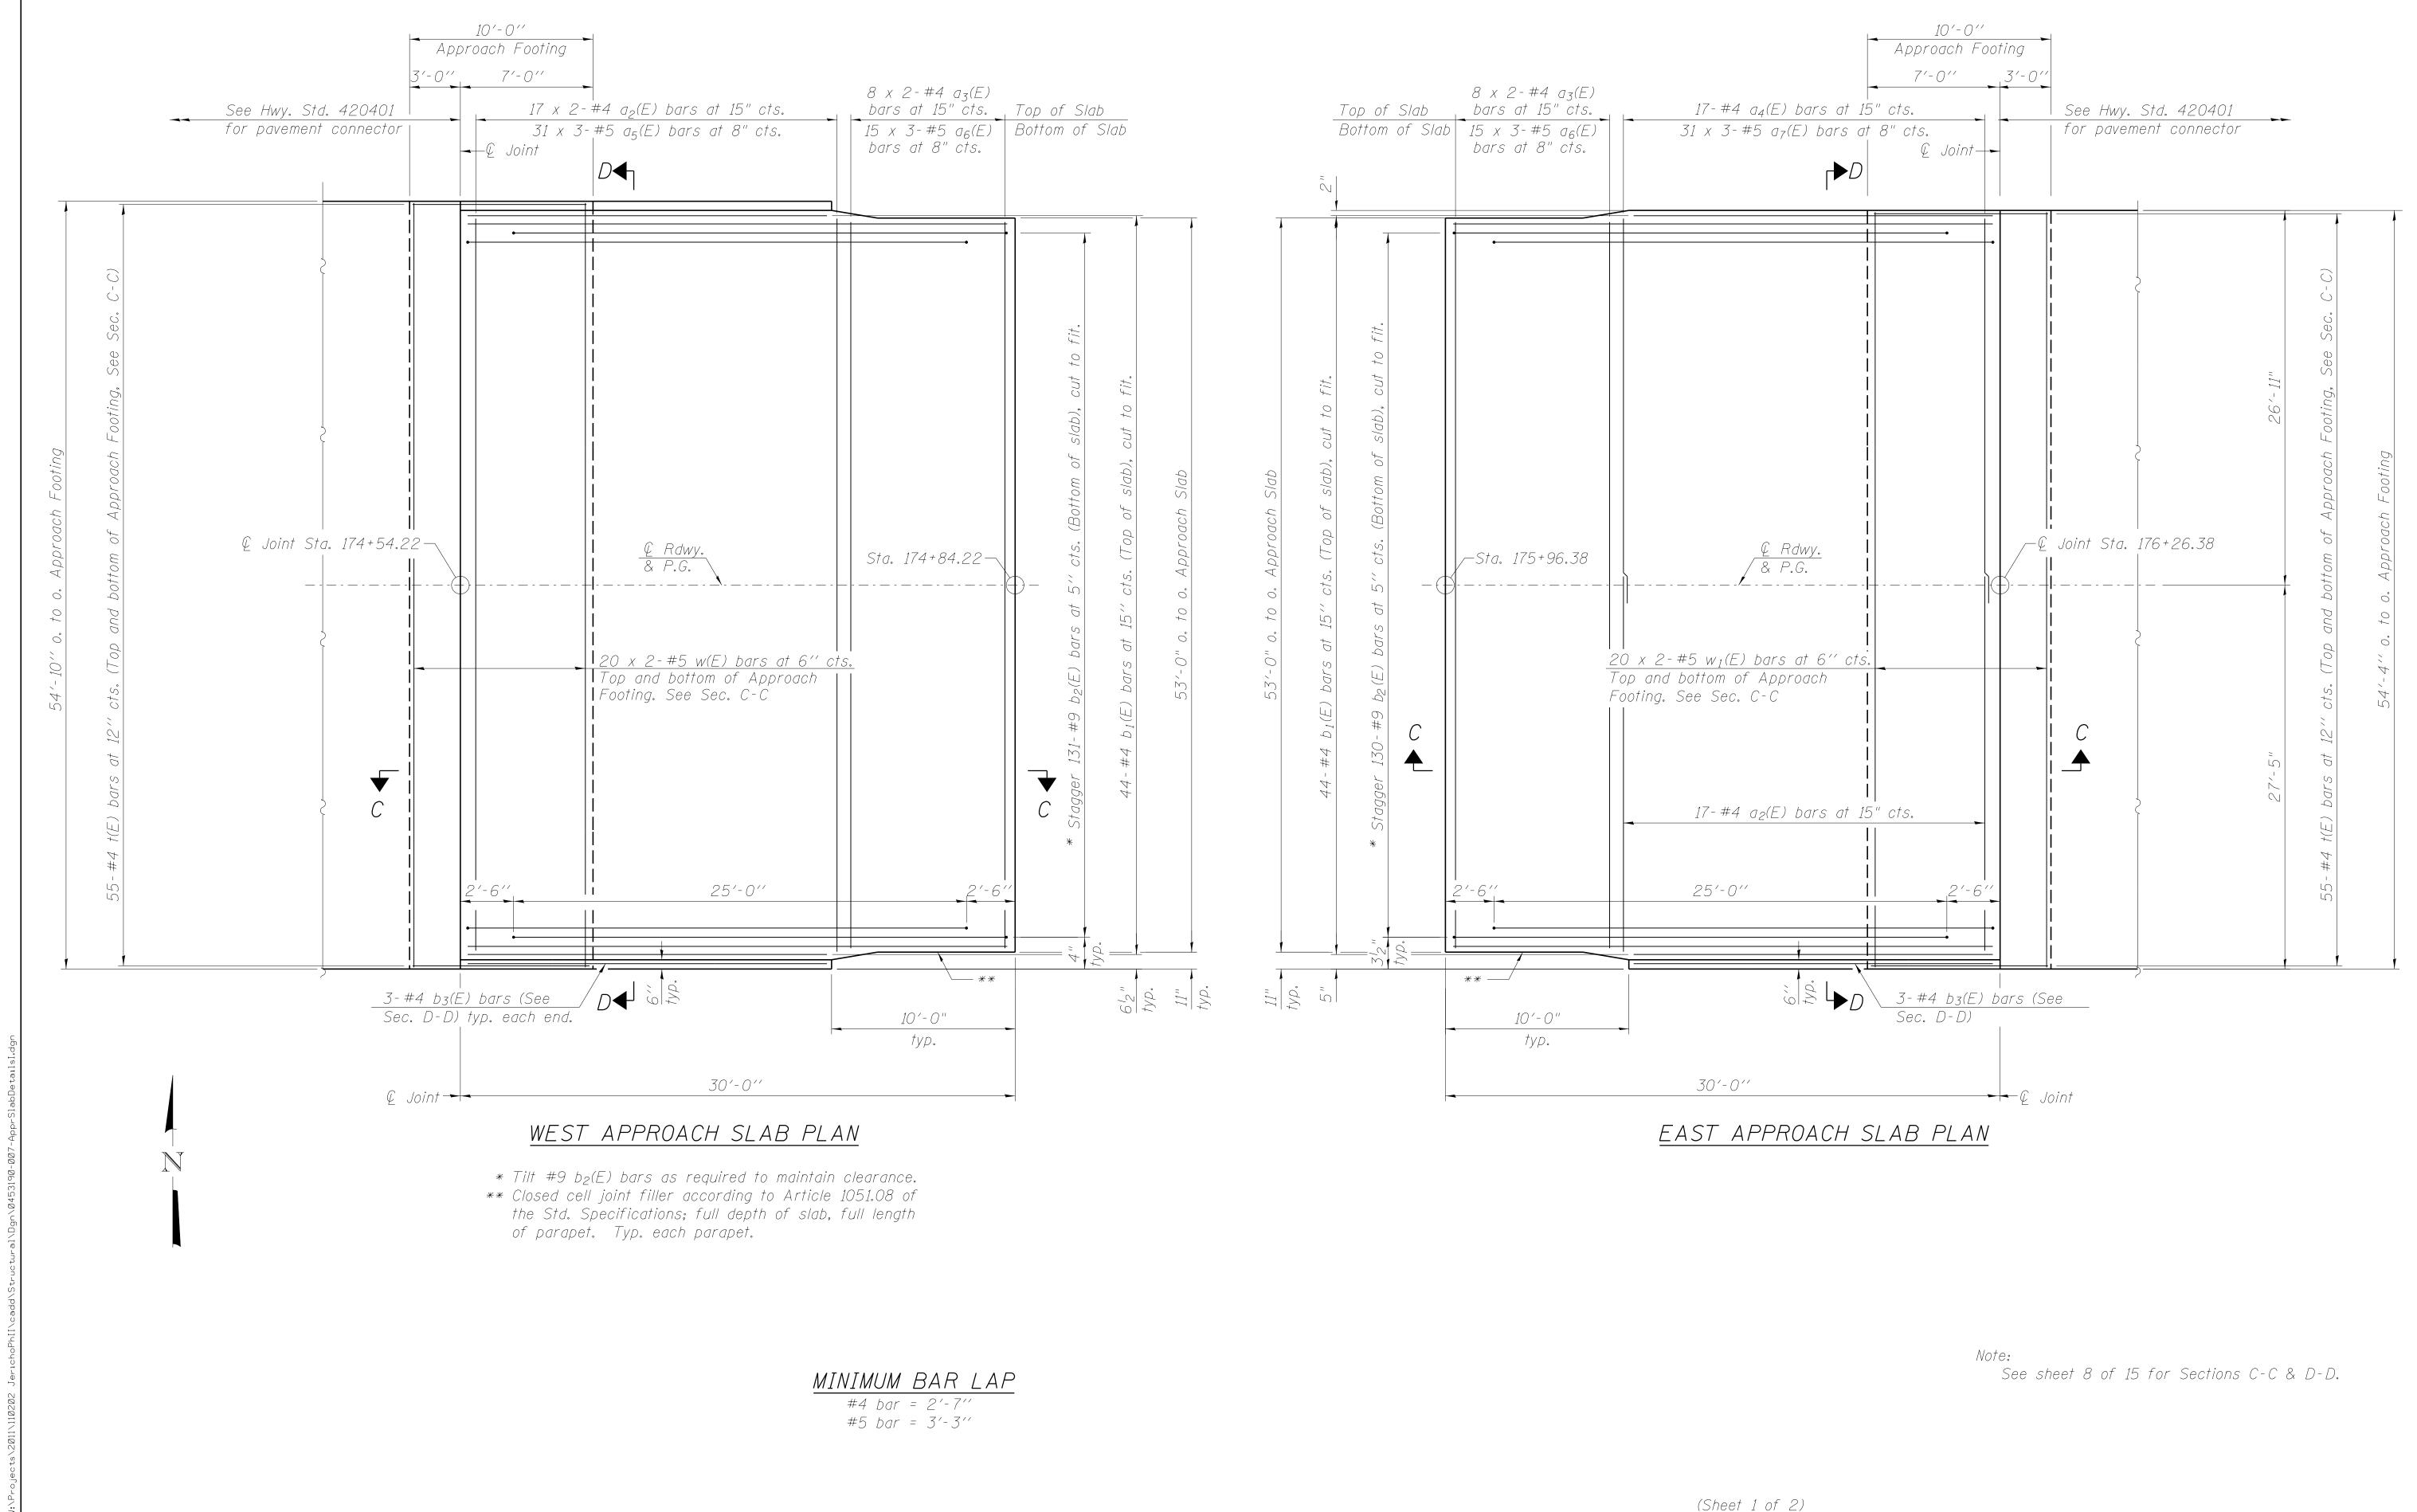

USER NAME = nparris DESIGNED - HLF REVISED SECTION COUNTY BRIDGE APPROACH SLAB DETAILS **STATE OF ILLINOIS** CHECKED - AEU REVISED 86 49 1542 04-00329-00-BR KANE **STRUCTURE NO. 045–3190** REVISED **DEPARTMENT OF TRANSPORTATION** PLOT SCALE = \$SCALE\$ DRAWN - HLF CONTRACT NO. XXXXX SHEET NO. 7 OF 15 SHEETS CHECKED - AEU REVISED PLOT DATE = 7/9/2013 ILLINOIS FED. AID PROJECT


WILLS BURKE KELSEY ASSOCIATES LTD.
116 West Main Street, Suite 201
St. Charles, Illinois 60174

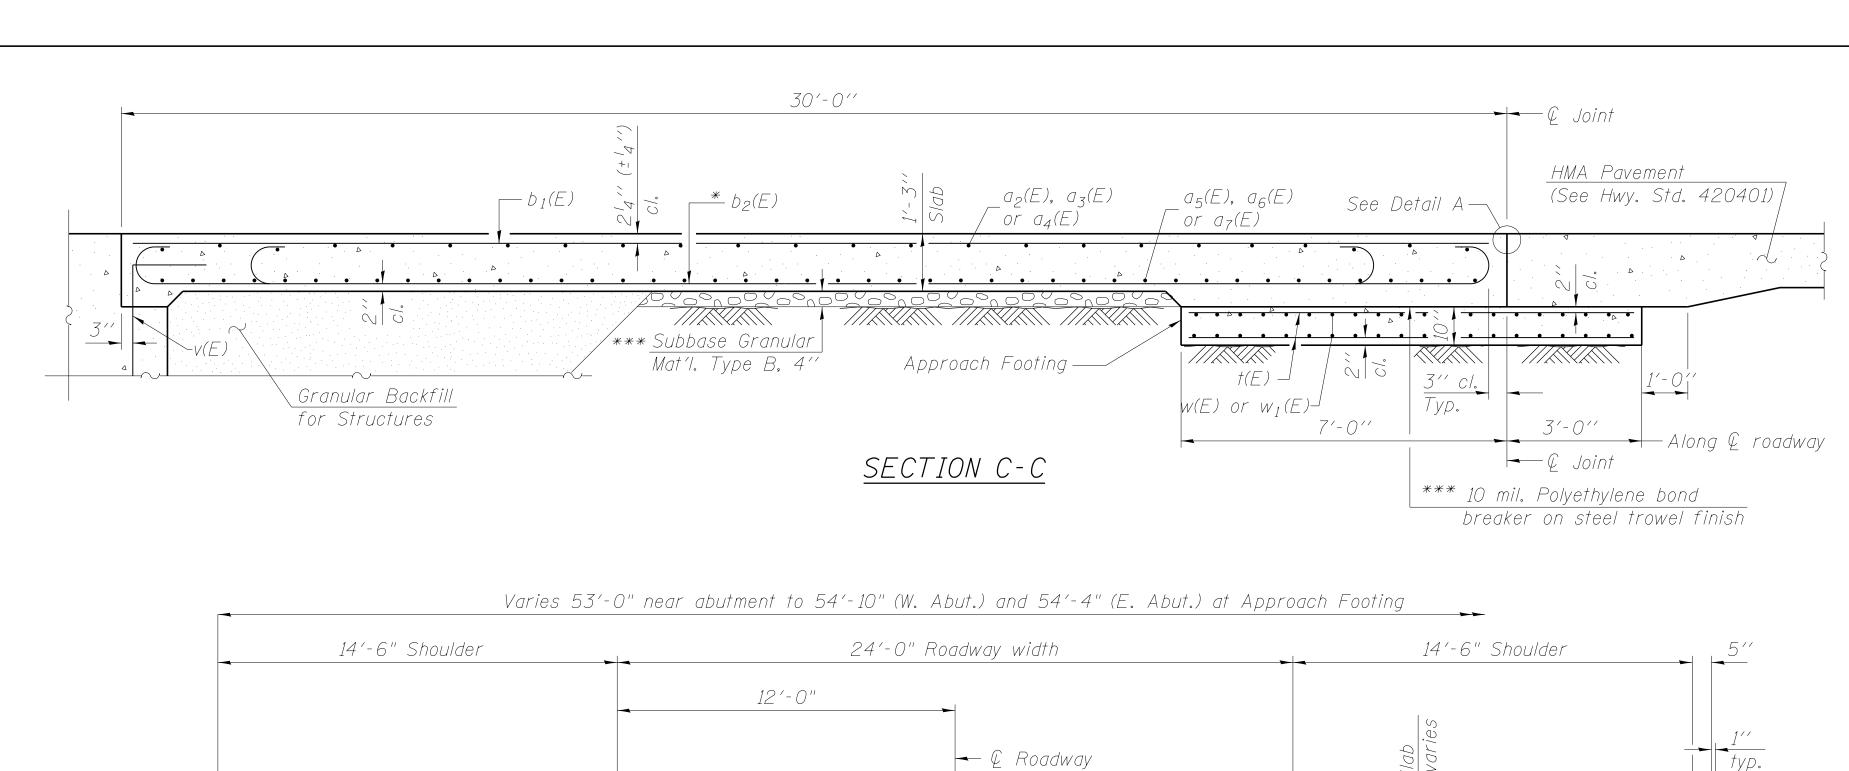

Varies 53'-0" near abutment to 54'-10" (W. Abut.) and 54'-4" (E. Abut.) at Approach Footing 14'-6' Shoulder 12'-0' 12'

(See Plan for dimensions not shown)

Note: No curb on north side of east approach slab.

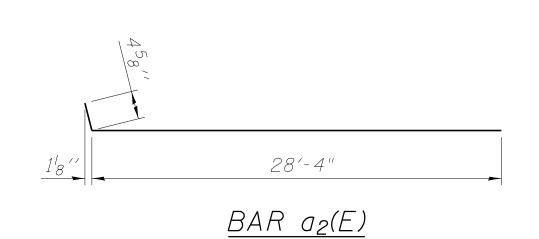




Not

Approach slab shall be paid for as Concrete Superstructure.
Approach footing concrete shall be paid for as Concrete Structures.
Reinforcement shall be paid for as Reinforcement Bars, Epoxy Coated.
For v(E) bar details, see sheet 11 of 15.

The approach footing maximum applied service bearing pressure (Qmax) = 2.0 ksf. Cost of excavation for approach footing included with Concrete Structures. For Granular Backfill for Structures and drainage treatment details, see sheet 2 of 15.

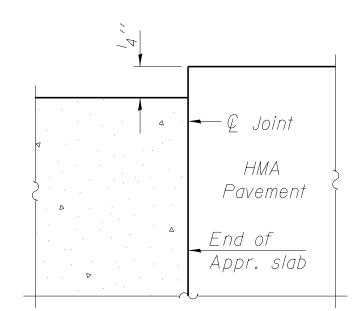

FLEXIBLE PAVEMENT

DETAIL A

- * Tilt #9 $b_2(E)$ bars as required to maintain clearance.
- *** Cost included with Concrete Superstructure.

TWO APPROACHES BILL OF MATERIAL

Bar	No.	Size	Length	Shape
a ₂ (E)	51	#4	28'-9"	\
a3(E)	32	#4	27'-8"	
04(E)	17	#4	28'-3"	
a5(E)	93	#5	20'-4"	
a6(E)	90	#5	28'-0"	
a7(E)	93	#5	20'-2"	
b1 (E)	88	#4	29'-8''	
b ₂ (E)	262	#9	29'-9''	
b3(E)	9	#4	19'-8"	
†(E)	220	#4	9'-8''	
w(E)	80	#5	28'-11"	
w1(E)	80	#5	28'-8"	
Concrete	Superstru	ıcture	Cu. Yd.	150.2
Concrete	Structure	S	Cu. Yd.	33.8
Reinforce Epoxy Co		<i>S</i> ,	Pound	43,990

Bars indicated thus 20 x 2-#5 etc. indicates 20 lines of bars with 2 lengths per line.


(Sheet 2 of 2)


<u> </u>	WILLS BURKE KELSEY ASSOCIATES LTD.	
WBK	116 West Main Street, Suite 201 St. Charles, Illinois 60174	
	<u> </u>	-


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	CHECKED -	AEU	REVISED -	
PLOT SCALE = \$SCALE\$	DRAWN -	HLF	REVISED -	
PLOT DATE = 7/9/2013	CHECKED -	AEU	REVISED -	

BRIDGE APPROACH SLAB DETAILS
STRUCTURE NO. 045-3190
SHEET NO 8 OF 15 SHEETS


FAU	SECTION	COUNTY	SHEETS	NO.
1542 04-00329-00-BR		KANE	86	50
		CONTRACT	NO. X	XXXX
	ILLINOIS FED. AI	ID PROJECT		

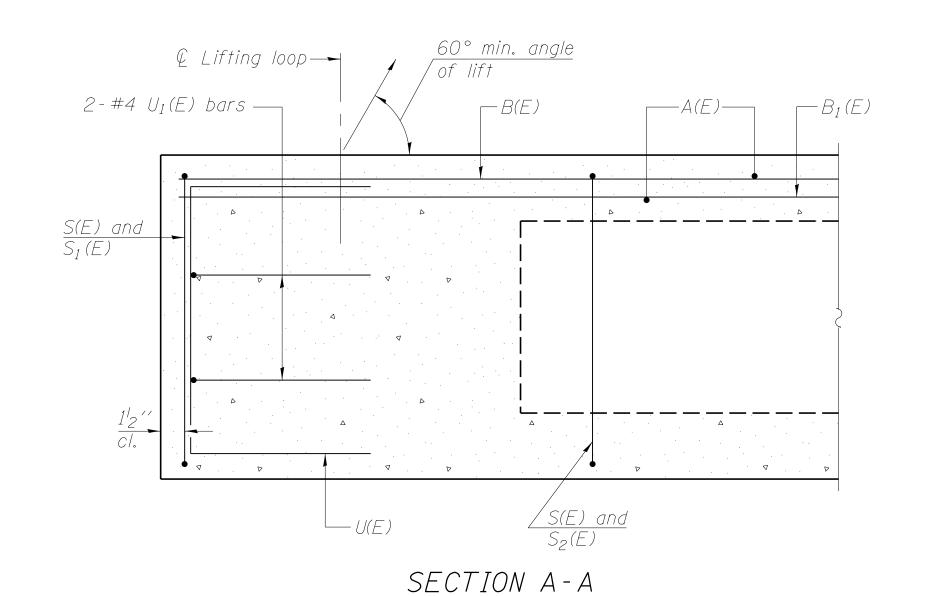

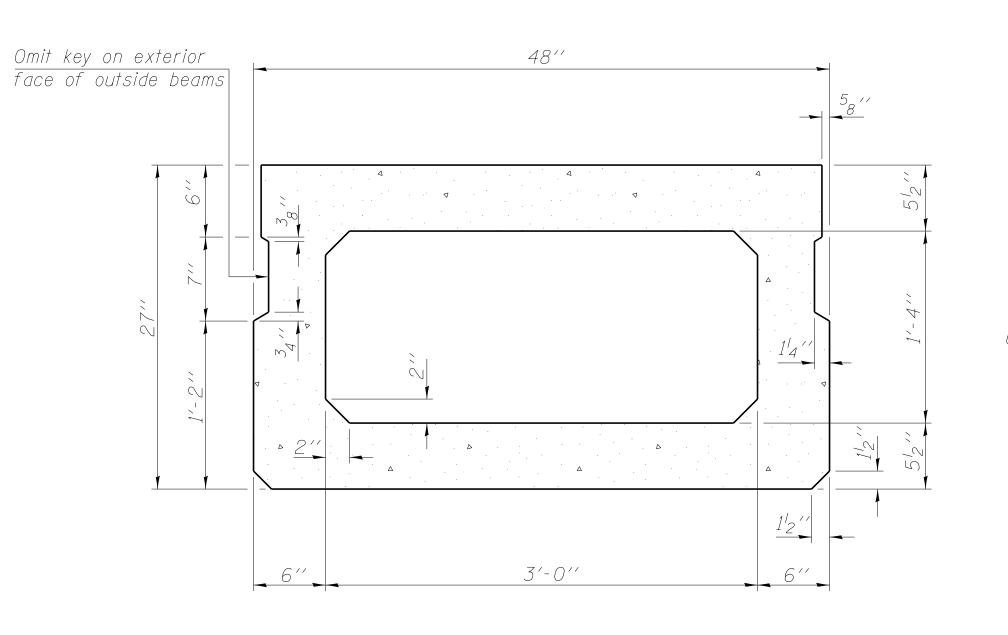

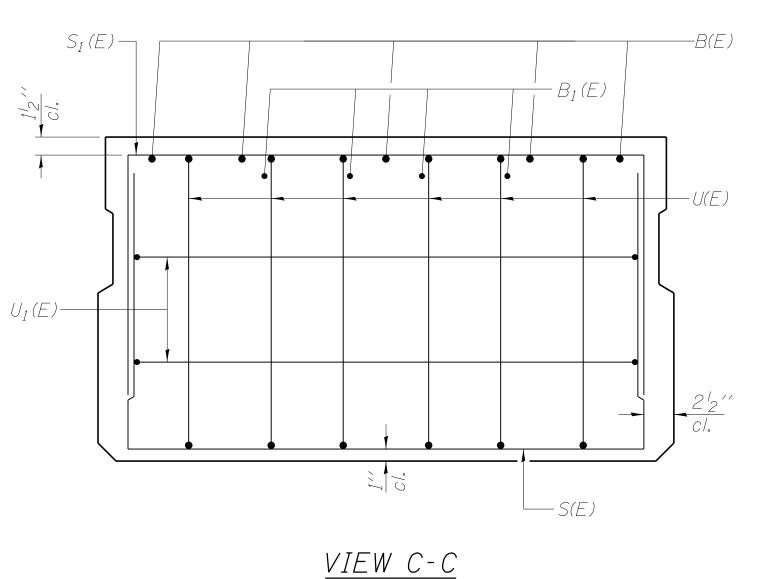


SECTION B-B (Showing dimensions)

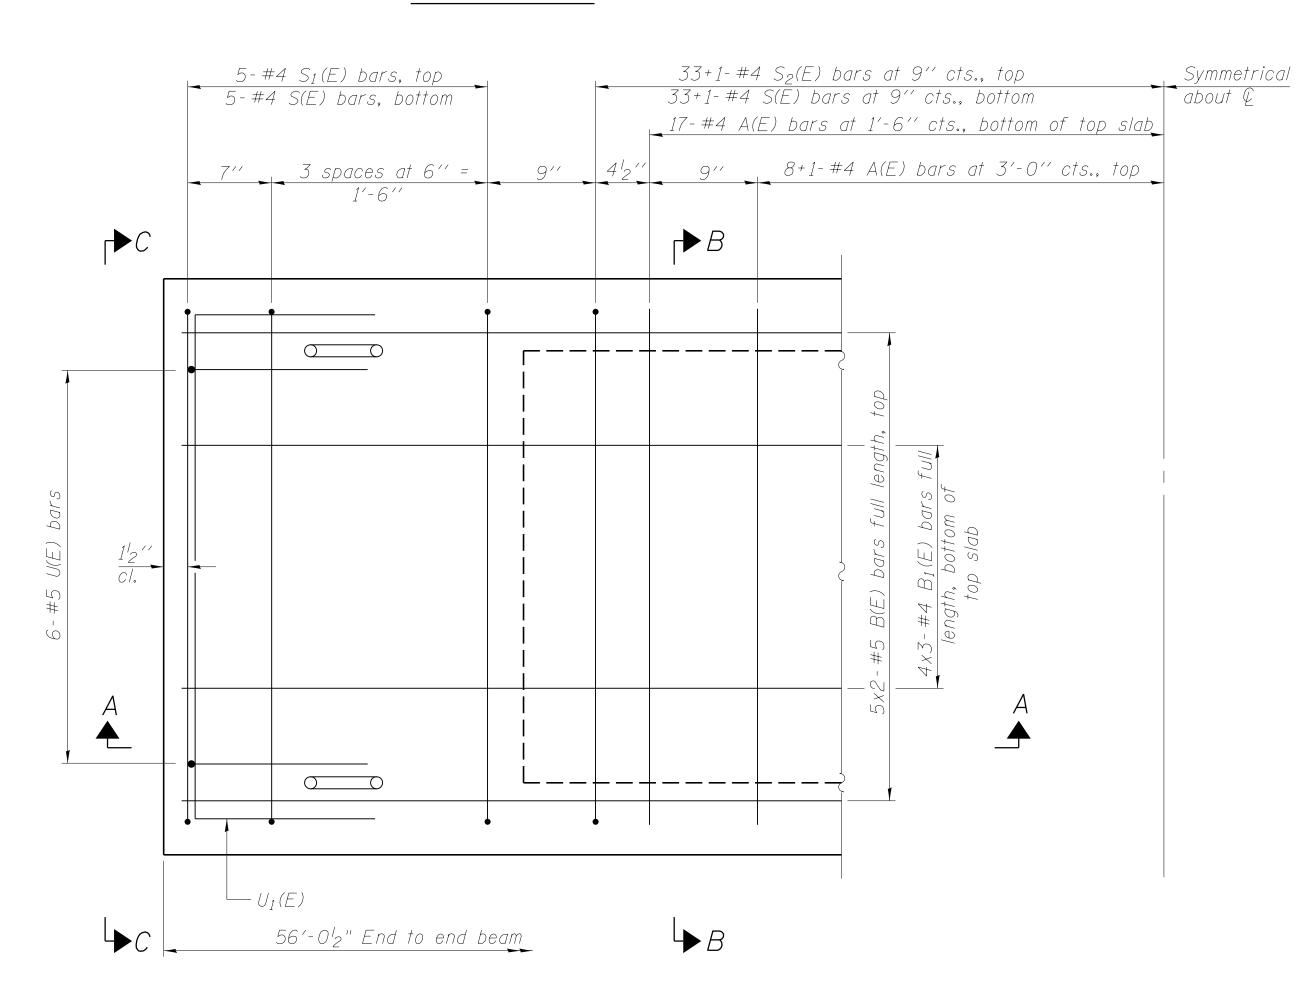

PLAN VIEW

Note: Spacing of S(E) and $S_2(E)$ bars may be adjusted up to 4" in the immediate area of the transverse tie diaphragms to miss the block outs for the transverse ties.

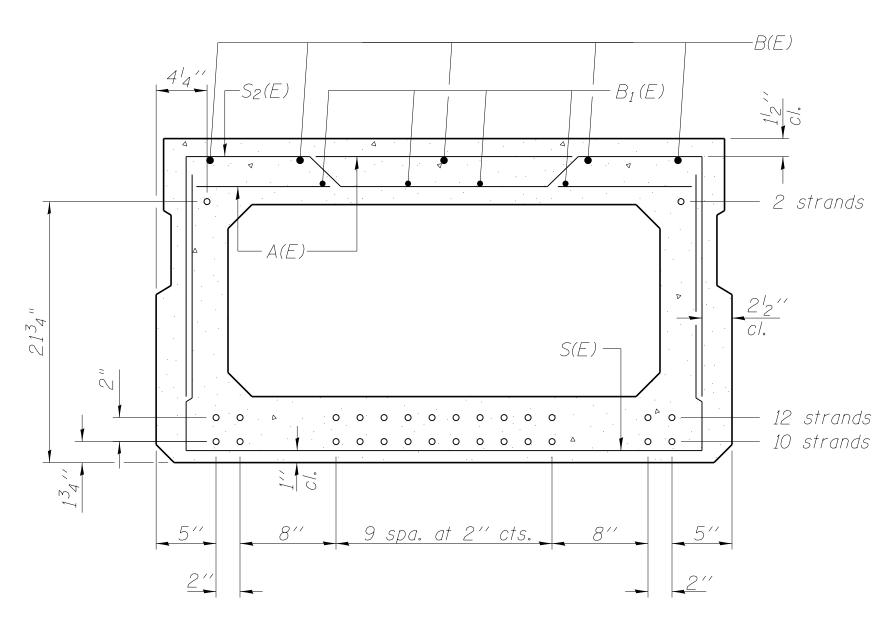

SECTION B-B

(Showing reinforcement and permissible strand locations) (10 strands 1^{3}_{4} " up, 12 strands 3^{3}_{4} " up, 2 strands 21^{3}_{4} " up)

Note: Place the number of strands specified in each row symmetrically about the centerline of beam in the permissible strand locations shown.

MINIMUM BAR LAP #4 bar = 2'-0'' #5 bar = 2'-6''

BAR LIST ONE REAM ONLY

ONE DEAM ONLI							
(For information only)							
Bar	No.	Size	Length	Shape			
A(E)	51	#4	3'-7''				
B(E)	10	#5	29'-2"				
$B_1(E)$	12	#4	20'-0"				
S(E)	77	#4	7'-5''				
$S_1(E)$	10	#4	6'-11''				
$S_2(E)$	67	#4	7'-2''				
U(E)	12	#5	4'-6''				
$U_1(E)$	4	#4	6'-0''				

Note: See sheet 10 of 15 for additional details and Bill of Material.

Bars indicated thus 5x2-#5 etc. indicates 5 lines of bars with 2 lengths per line.

PD-2748-0

7-1-10


	WILLS BURKE KELSEY ASSOCIATES LTD.
WBK	116 West Main Street, Suite 201 St. Charles, Illinois 60174

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	CHECKED	-	AEU	REVISED -
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27" x 48" PPC DECK BEAM	
STRUCTURE NO. 045-3190	
SHEET NO 9 OF 15 SHEETS	

FAU	SECTION	COUNTY	TOTAL SHEETS	SHEET NO.
1542	04-00329-00-BR	KANE	86	51
		CONTRACT	NO. X	XXXX
	ILLINOIS FED. AI	ID PROJECT		



WILLS BURKE KELSEY ASSOCIATES LTD.

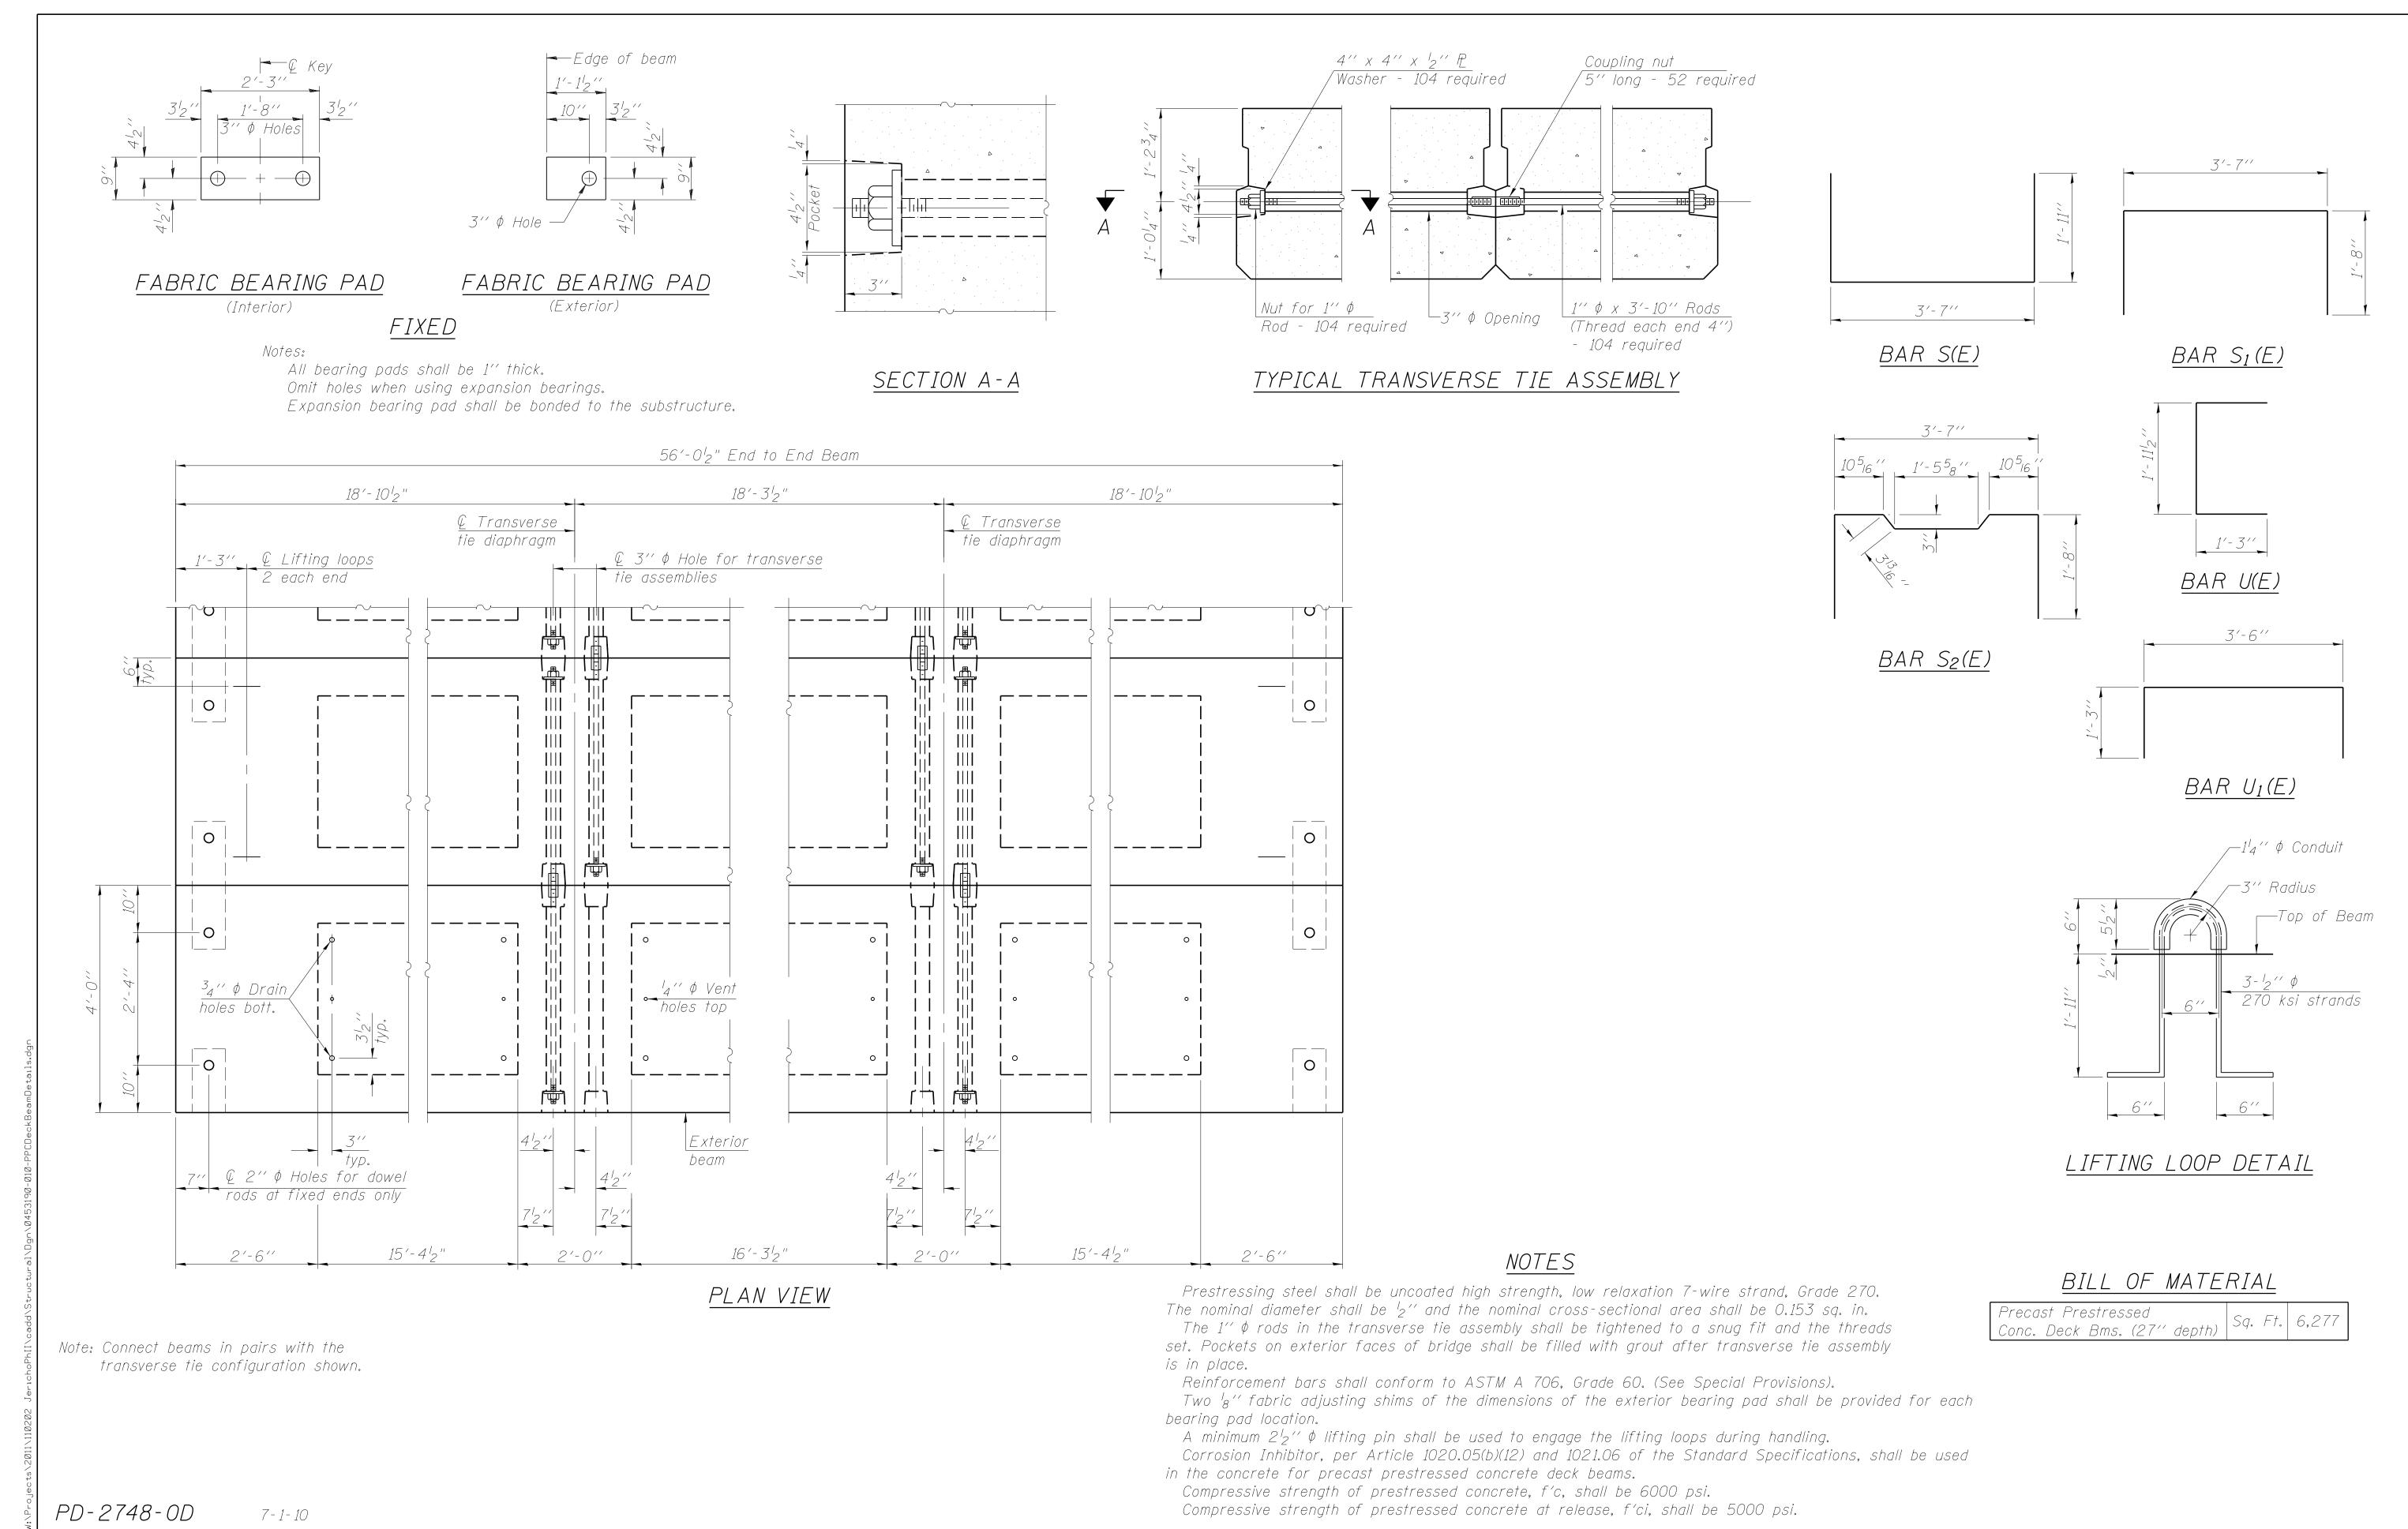116 West Main Street, Suite 201
St. Charles, Illinois 60174

USER NAME = nparr1s

PLOT SCALE = \$SCALE\$

CHECKED - AEU REVISED PLOT SCALE = \$SCALE\$

DRAWN - HLF
REVISED PLOT DATE = 7/9/2013

CHECKED - AEU REVISED -

HLF

REVISED

DESIGNED -

STATE OF ILLINOIS
DEPARTMENT OF TRANSPORTATION

27" x 48" PPC DECK BEAM DETAILS
STRUCTURE NO. 045-3190

SHEET NO. 10 OF 15 SHEETS

FAU SECTION COUNTY TOTAL SHEETS NO.


1542 04-00329-00-BR KANE 86 52


CONTRACT NO. XXXXX

ILLINOIS FED. AID PROJECT


T OF TRANSPORTATION

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SEC. THRU ABUT.

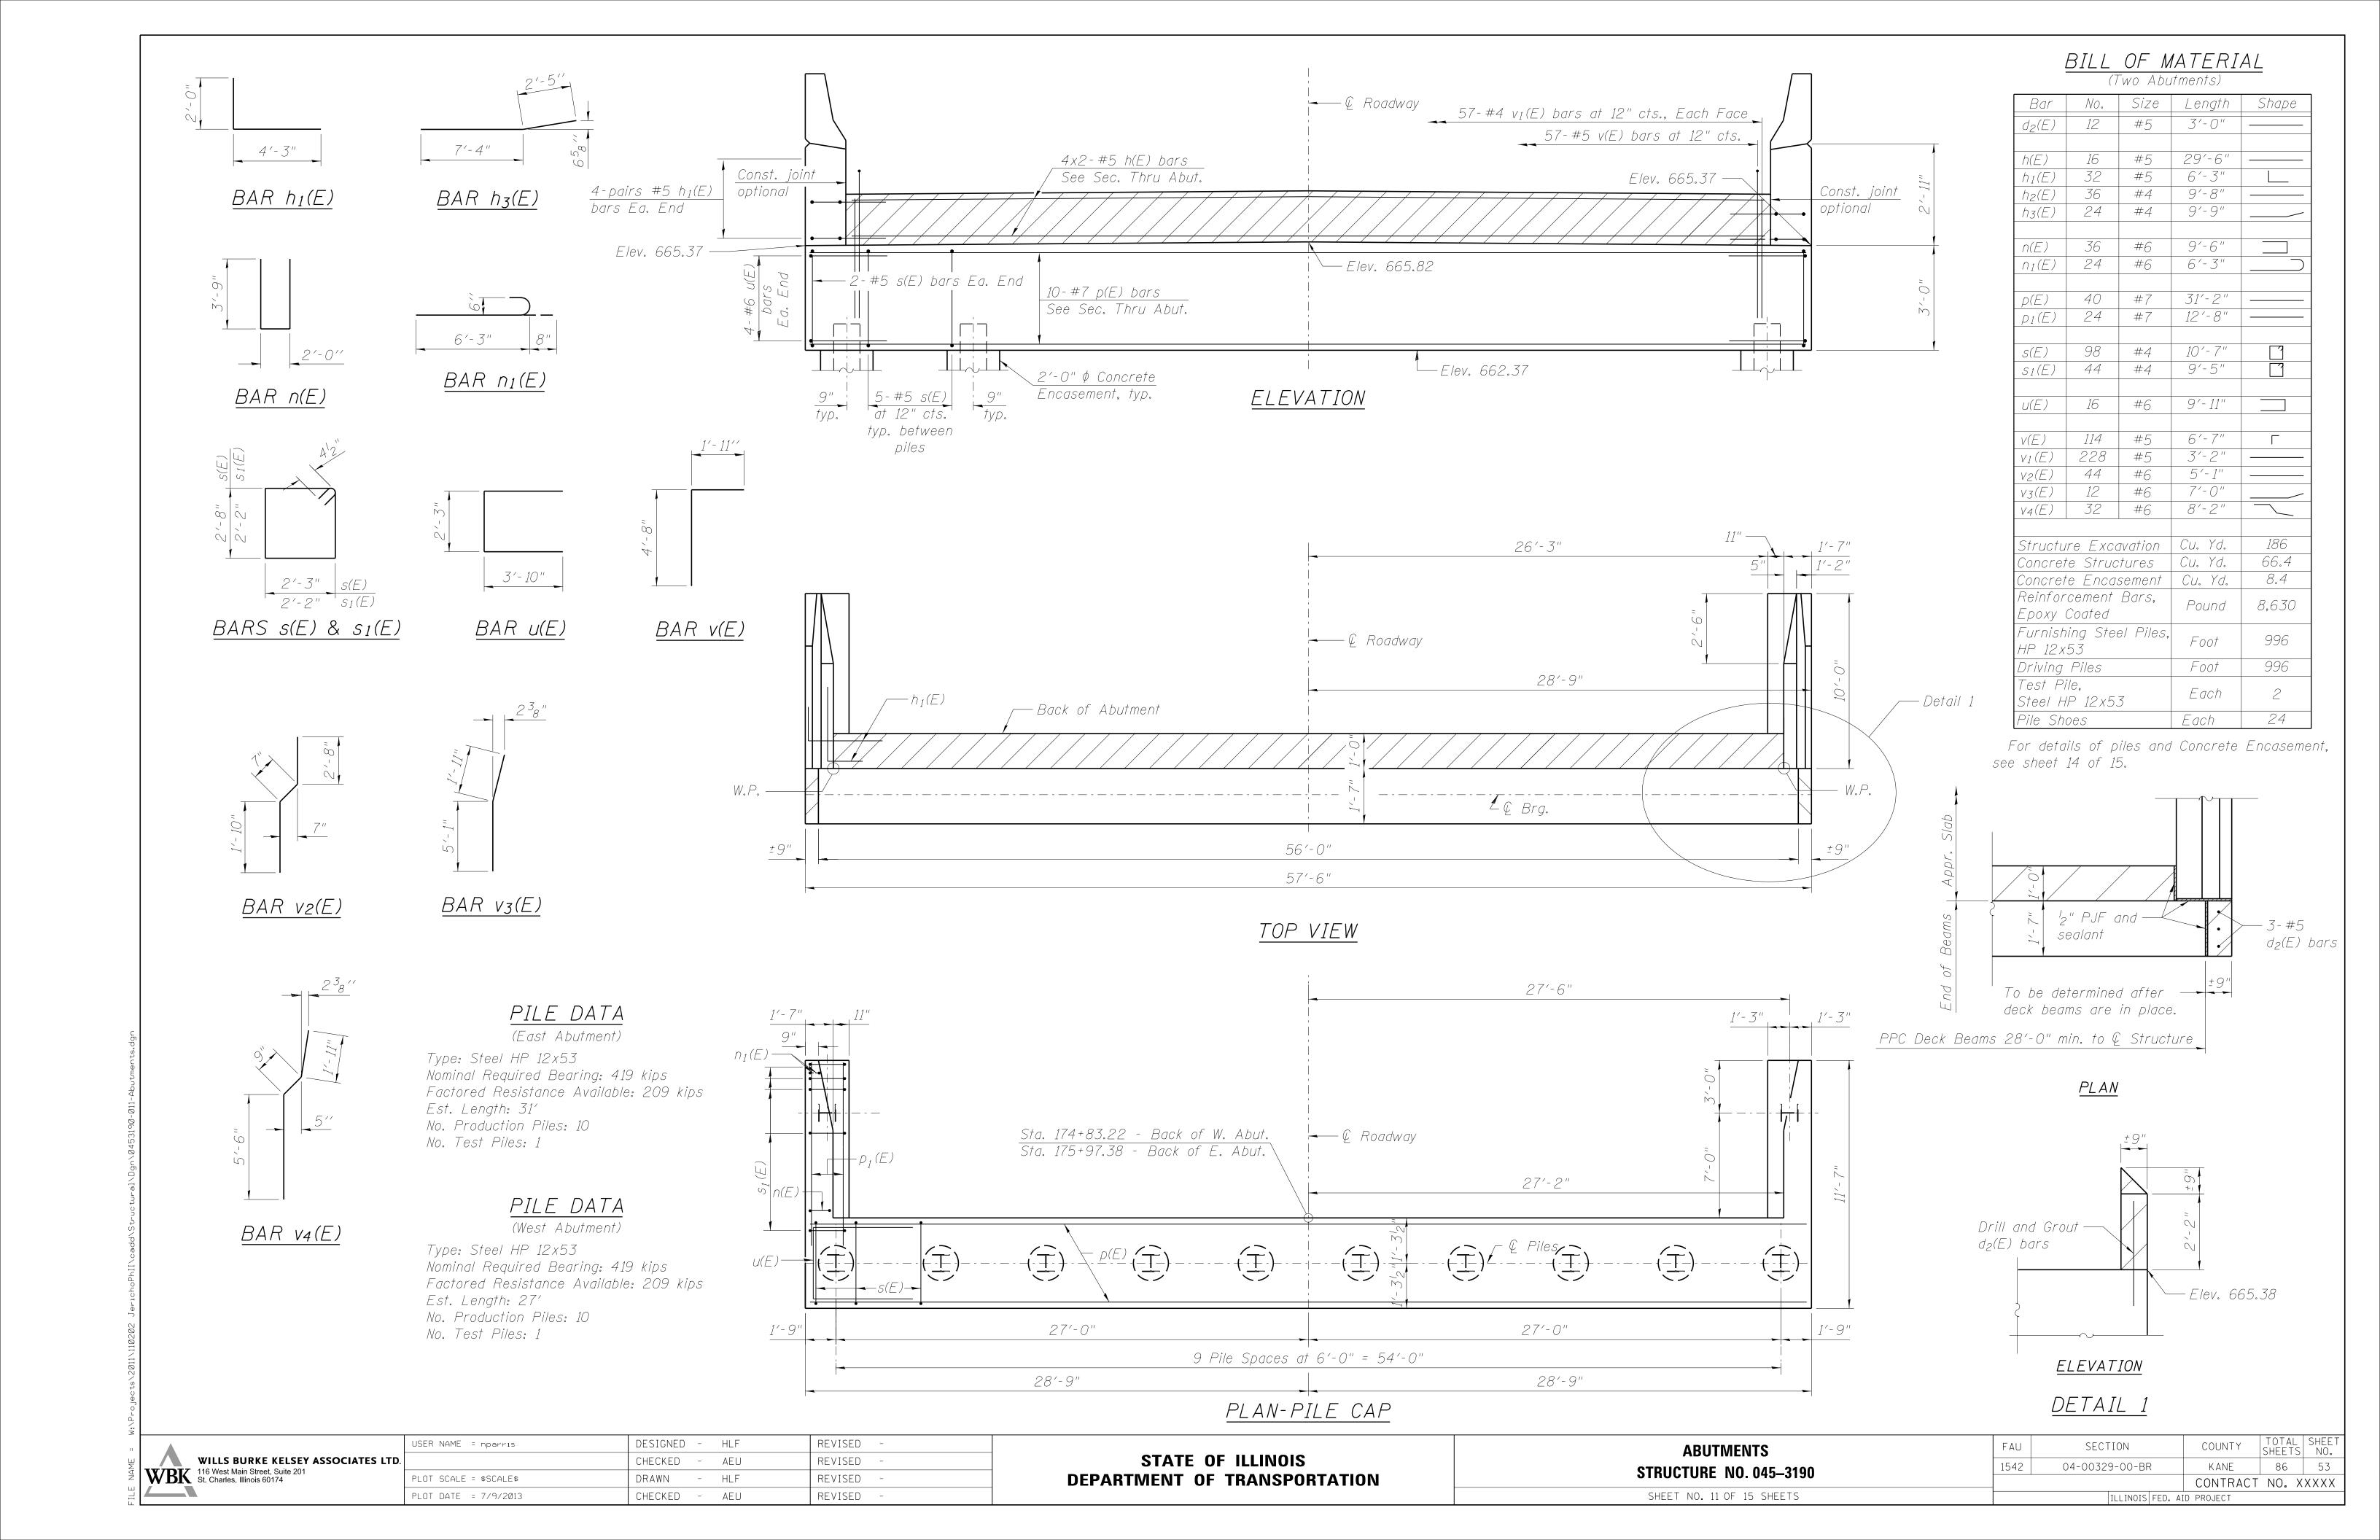

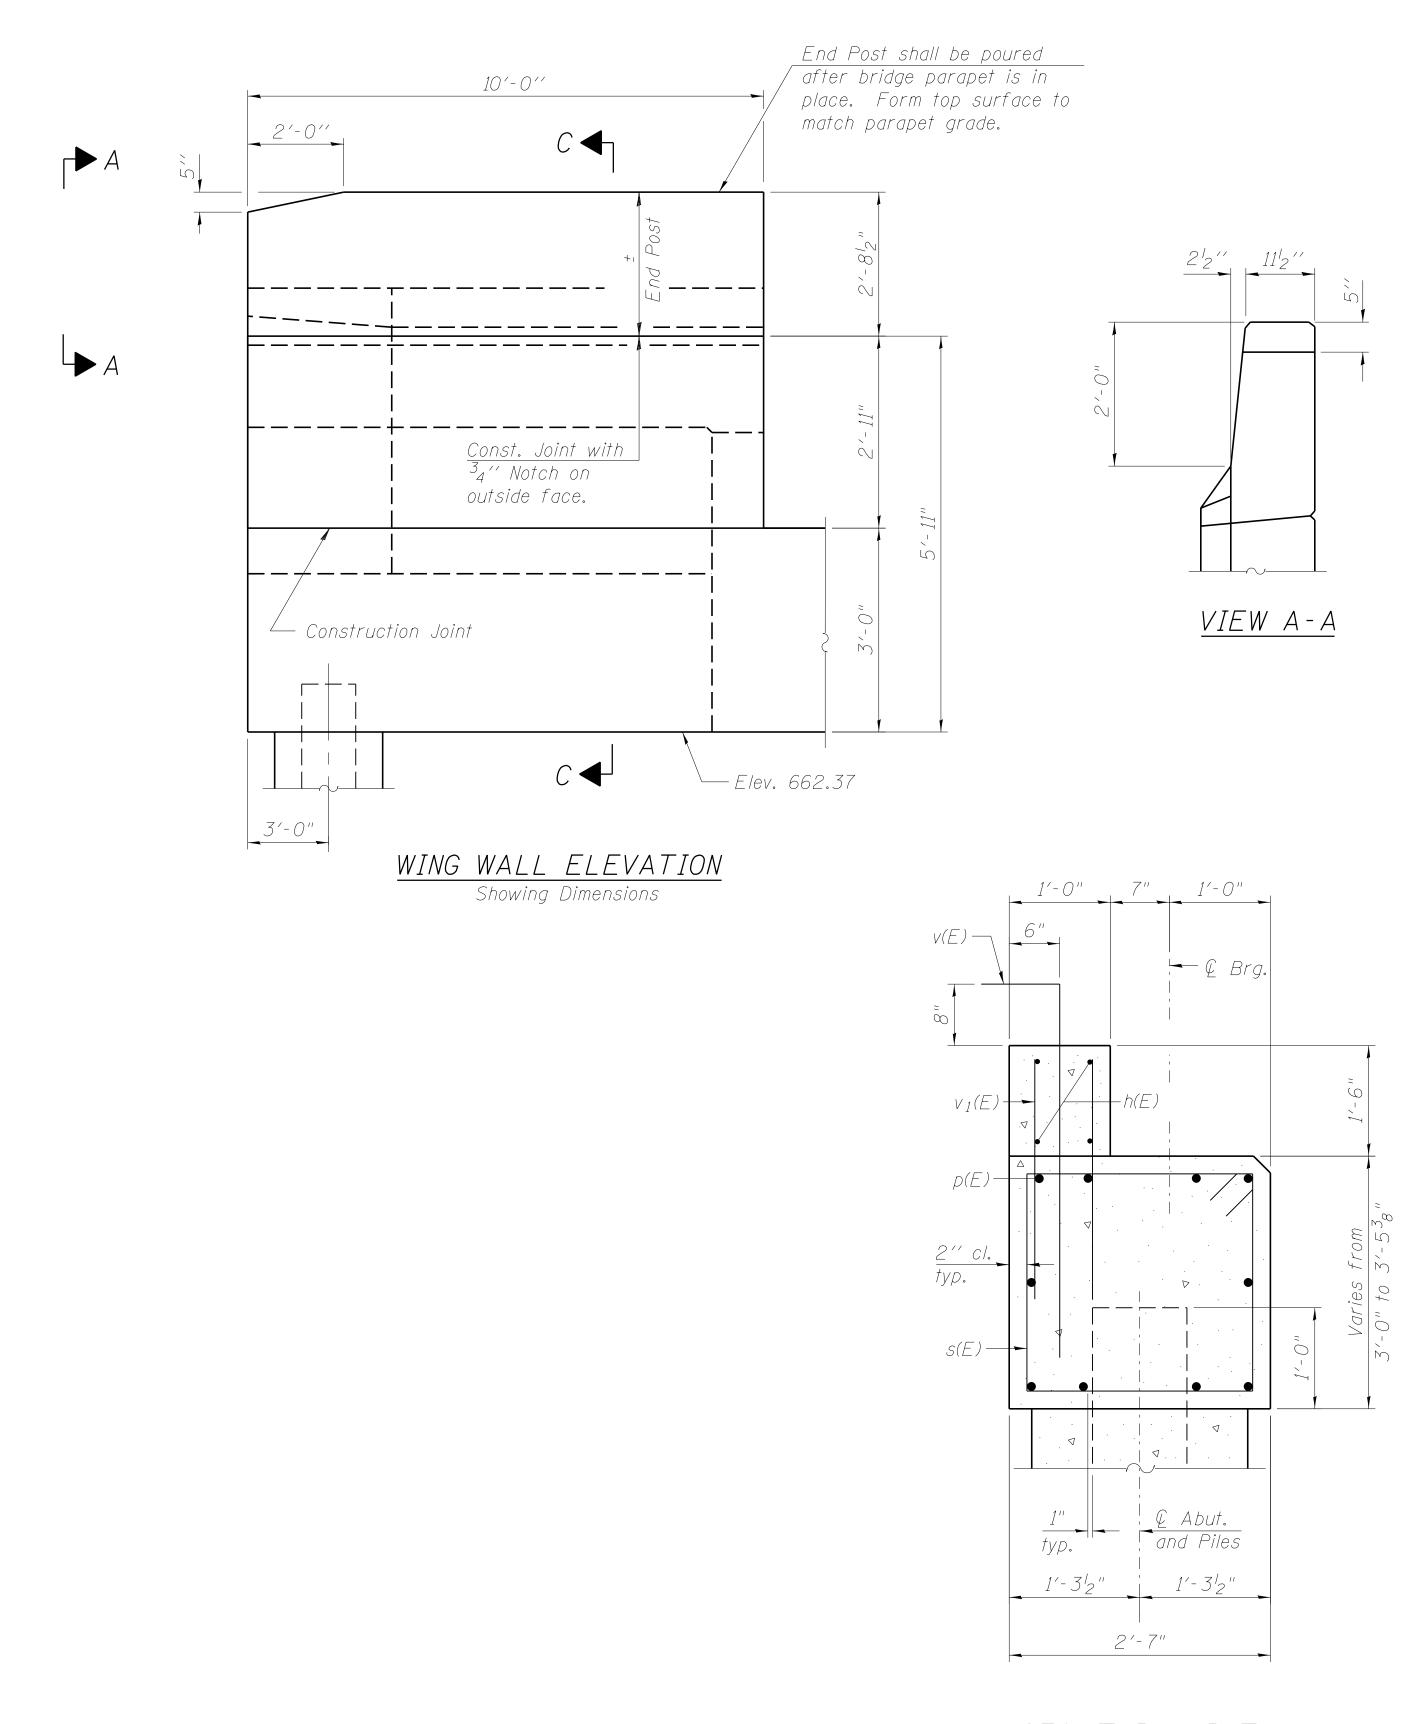- Hatched area to be poured after superstructure false work has been removed. Quantity of concrete included with Concrete Superstructure.
- Space reinforcement in cap to miss anchor bolts.
- Pour steps monolithically with cap.
- Quantity of concrete in end post included with Concrete
- Superstructure on sheet of -.
- For Concrete Encasement details, see sheet 14 of 15.


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╝		WILLS BURKE KELSEY ASSOCIATES LTD.
Ĭ	W/RK	116 West Main Street, Suite 201 St. Charles, Illinois 60174
Ц	W DIC	ot. Chanes, minois 60174

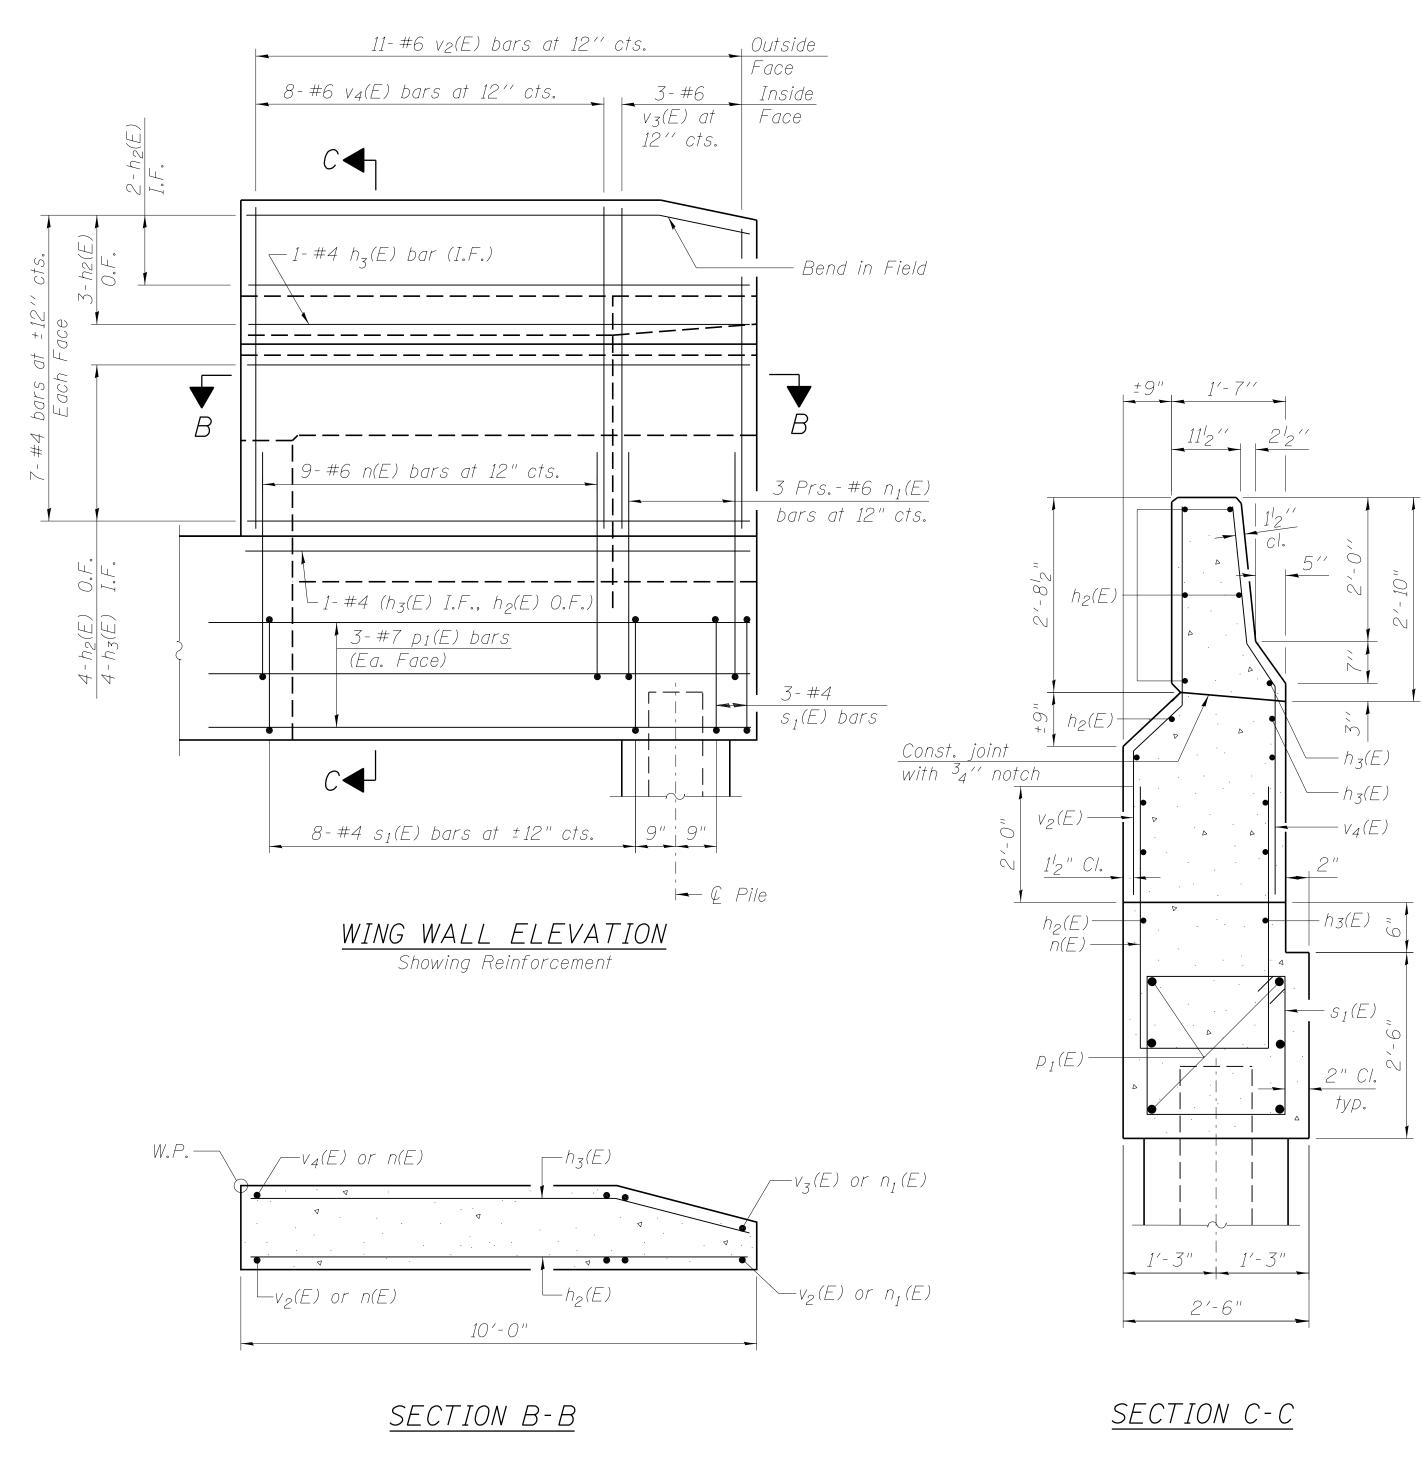	USER NAME = nparris	DESIGNED	-	HLF	REVISED -
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	PLOT SCALE = \$SCALE\$	DRAWN	-	HLF	REVISED -
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STATE OF ILLINOIS				
DEPARTMENT OF TRANSPORTATION				


ABUTMENT DETAILS	FAU	SECTION	COUNTY	TOTAL SHEETS	SHEET NO.
STRUCTURE NO. 045-3190	1542	04-00329-00-BR	KANE	86	54
0111001011E 140: 043 0130			CONTRACT	NO. X	XXXX
SHEET NO. 12 OF 15 SHEETS		ILLINOIS FED. AT	D PROJECT		

TOTAL SHEET NO. 86 54

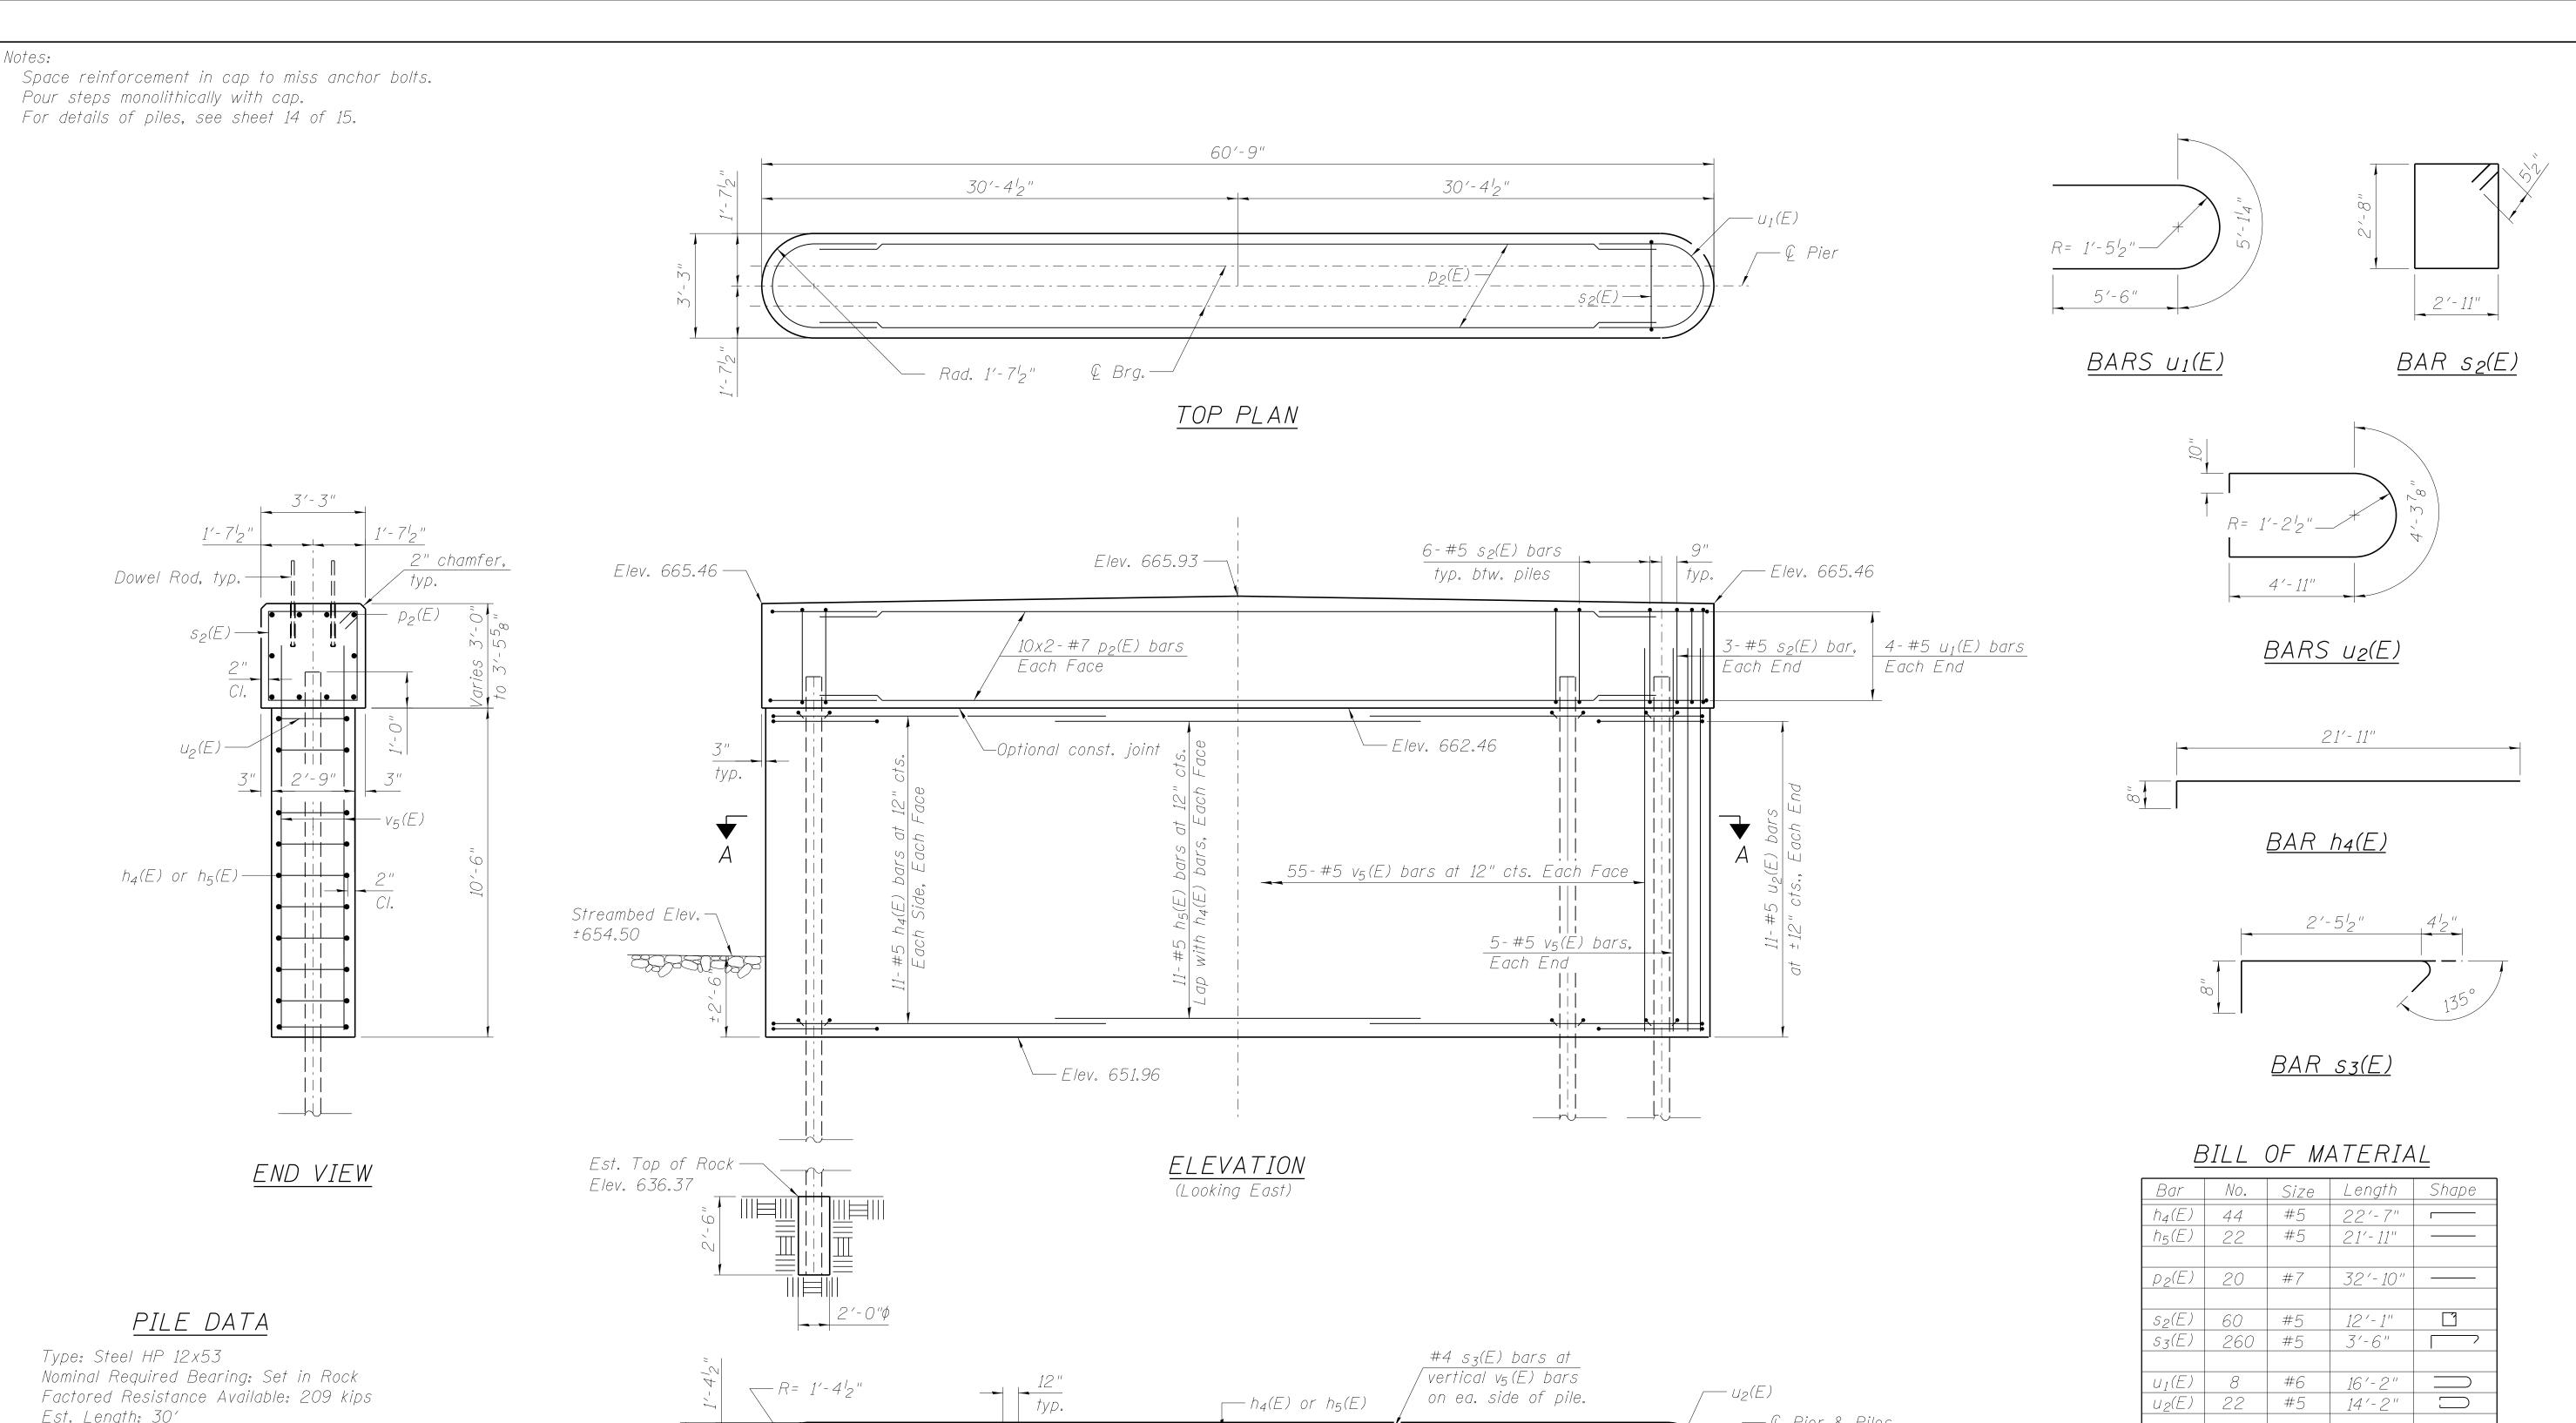

Type: Steel HP 12x53
Nominal Required Bearing: Set in Rock
Factored Resistance Available: 209 kips
Est. Length: 30'
No. Production Piles: 10
No. Test Piles: 0
Est. Top of Rock: 636.37
Rock Socket Depth: 2.5'
Rock Socket Diameter: 2'-0"

Piles shall be driven through 2'-0" diameter precored holes extending to elevation 633.47 according to Article 512.09(c) of the Standard Specifications. Cost included in driving piles.

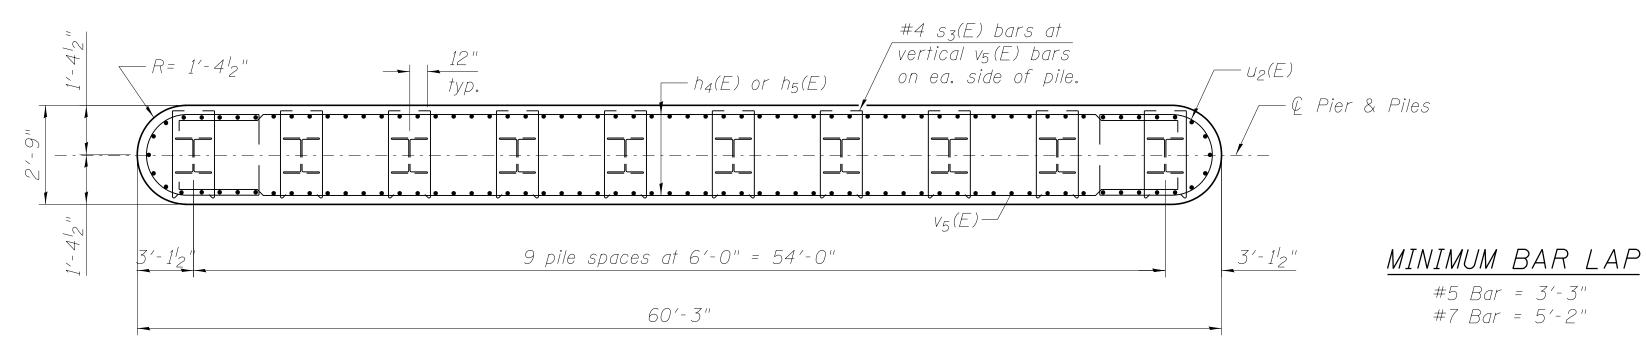

SECTION A-A

n	USER NAME = nparris	DESIGNED - HLF	REVISED -		PIFR	FAU	SECTION	COUNTY TOTAL SHEET
WILLS BURKE KELSEY ASSOCIATES LTD	0.	CHECKED - AEU	REVISED -	STATE OF ILLINOIS	OTDUOTUDE NO 045 0400	1542	04-00329-00-BR	KANE 86 55
WBK 116 West Main Street, Suite 201 St. Charles, Illinois 60174	PLOT SCALE = \$SCALE\$	DRAWN - HLF	REVISED -	DEPARTMENT OF TRANSPORTATION	STRUCTURE NO. 045–3190			CONTRACT NO. XXXXX
	PLOT DATE = 7/9/2013	CHECKED - AEU	REVISED -		SHEET NO. 13 OF 15 SHEETS		ILLINOIS FED.	AID PROJECT

v₅(E) 120 #5

Concrete Structures

Seal Coat Concrete

Reinforcement Bars,

Furnishing Steel Piles,

Epoxy Coated

HP 12x53

Driving Piles

Pile Shoes

Cofferdam Excavation Cu. Yd.

12'-6"

Cu. Yd.

Cu. Yd.

Pound

Foot

Foot

Each

163

87.2


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996


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10




STEEL PILE TABLE


Designation	Depth d	Flange width b _f	Web and Flange thickness t	Encasement diameter A
HP 14×117	14/4′′	14 78''	13/1/	30′′
x102	14''	14 34 11	11/6	30′′
x89	1378′′	14 34 ′′	5, 11	30′′
x73	1358′′	14 ⁵ 8′′	12''	30′′
HP 12x84	12/4′′	1214''	116 ′′	24''
x74	12 /8 ′′	1214''	58''	24''
x63	12''	12 /8 ′′	12"	24''
x53	1134''	12′′	7 ₁₆ ′′	24''
HP 10x57	10′′	1014''	916	24''
x42	934''	10/8′′	716	24''
HP 8x36	8′′	818''	716	18′′

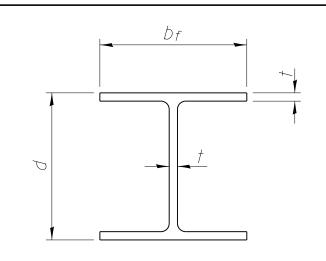


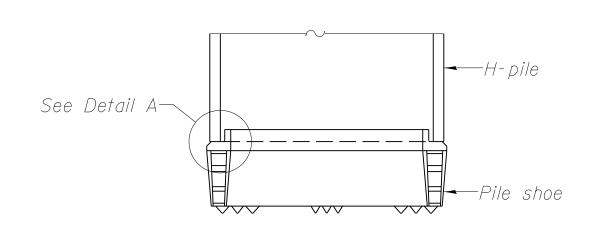ELEVATION

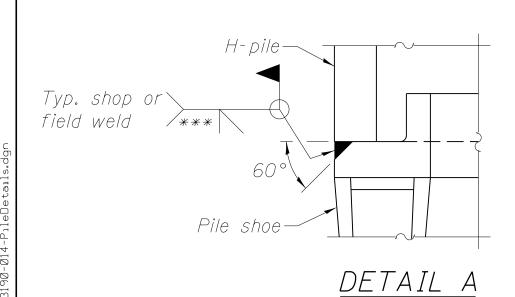


H-PILE SHOE ATTACHMENT

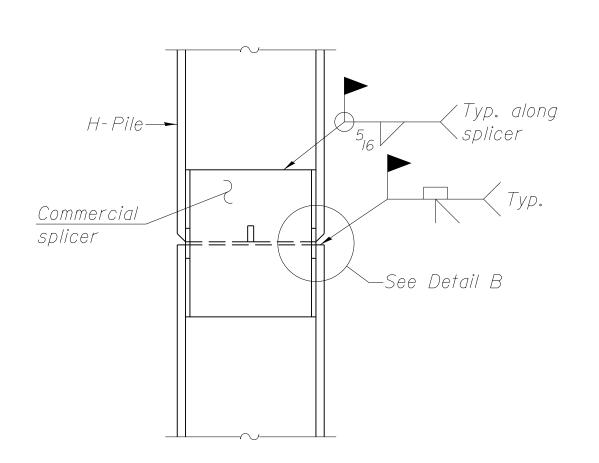

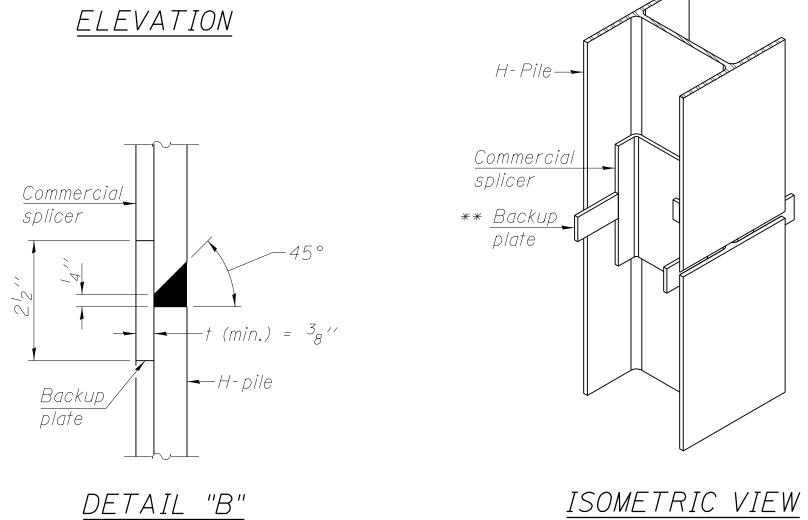


WELDED COMMERCIAL SPLICE

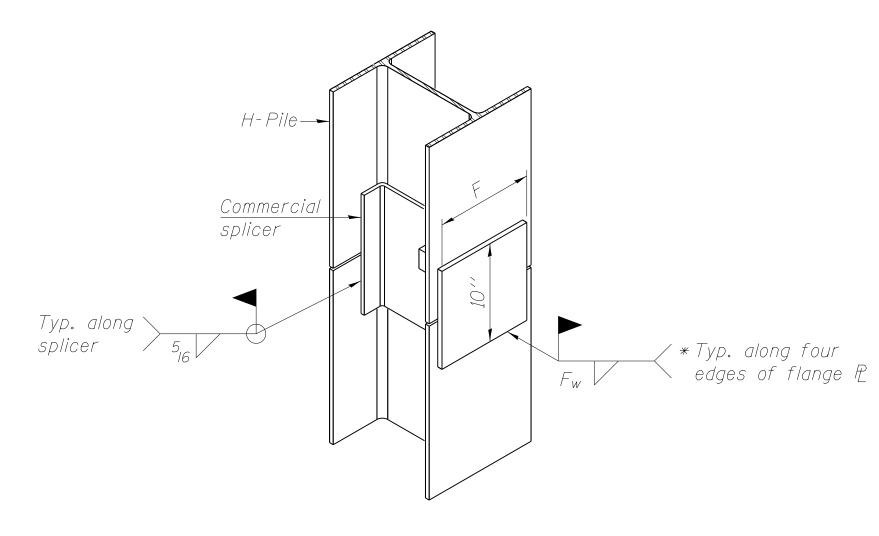

ISOMETRIC VIEW


A Bottom of pile cap

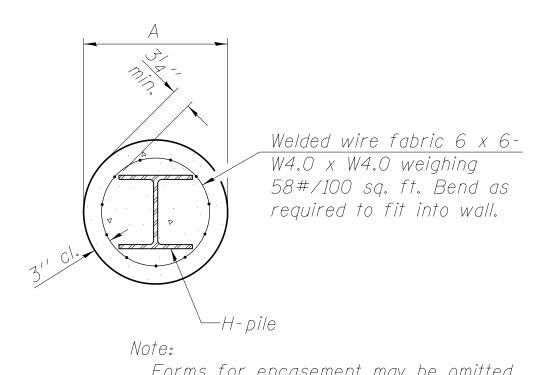

Forms for encasement may be omitted when soil conditions permit.

ELEVATION


PILE ENCASEMENT

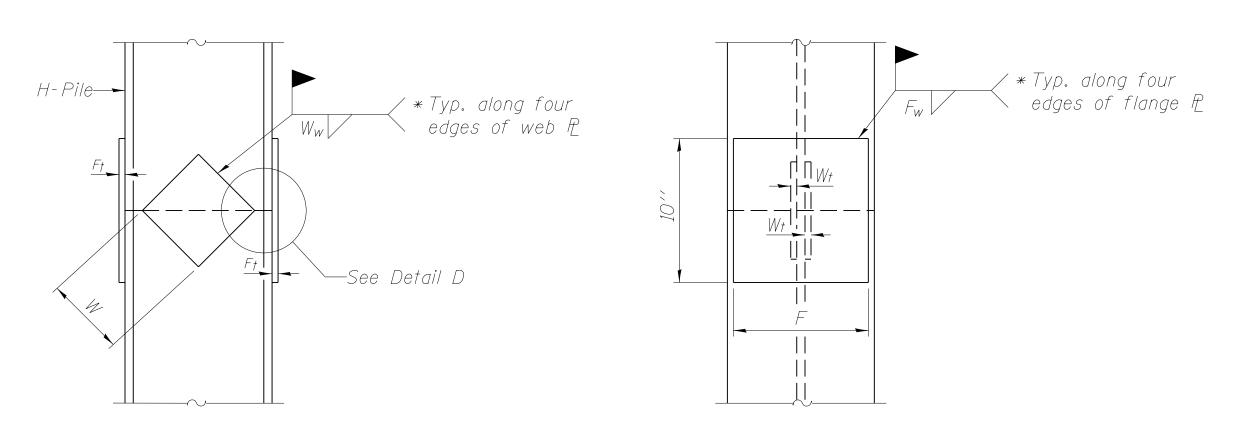

ELEVATION

END VIEW

SECTION A-A

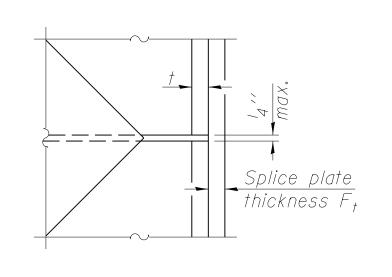

DETAIL D

Designation	F	F _t	F_w	W	W _t	W _w
HP 14×117	12 12 "	1''	78′′	734''	58′′	12''
x102	1212''	7, ′′	34''	734''	5, 11	2"
x89	12/2''	34''	116 //	734''	5,77	2"
x73	1212''	58′′	9 //	734''	5,77	12"
HP 12x84	10′′	78′′	116 //	612''	5, 11	12"
x74	10′′	78''	116 ′′	612''	5, 11	2"
x63	10′′	5811	2"	612''	2"	38 ′′
x53	10′′	58′′	12"	612''	12"	38 ′′
HP 10x57	8''	34''	9 //	514''	2"	38 ′′
x42	8′′	5811	9 //	514''	2"	38 11
HP 8x36	7′′	58''	716 ′′	41/4	2"	38''
	1	1	1	1	1	<u> </u>

WELDED PLATE FIELD SPLICE

WELDED COMMERCIAL SPLICE ALTERNATE

- * Interrupt welds $\frac{1}{4}$ from end of web and/or each flange.
- ** Remove portions of backup plates that extend outside the flanges.

*** Weld size per pile shoe manufacturer (5₁₆'' min.).

Note: The steel H-piles shall be according to AASHTO M270 Grade 50.

F-HP

1-27-12

USER NAME = nparris

DESIGNED - HLF

CHECKED - AEU

REVISED
PLOT SCALE = \$SCALE\$

DRAWN - HLF

REVISED
PLOT DATE = 7/9/2013

CHECKED - AEU

REVISED -

STATE OF ILLINOIS
DEPARTMENT OF TRANSPORTATION

 HP PILE DETAILS
 FAU
 SEC

 STRUCTURE NO. 045—3190
 1542
 04-0032

AU SECTION COUNTY TOTAL SHEET NO. 242 04-00329-00-BR KANE 86 56

CONTRACT NO. XXXXX

| ILLINOIS FED. AID PROJECT

WILLS BURKE KELSEY ASSOCIATES LTD.

116 West Main Street, Suite 201
St. Charles, Illinois 60174

Testing Service Corporation

STRUCTURE	PODINGLOG	
SINUGIUME	コンスロット・フィ	

Page 1 of 1
Date Started <u>4/14/08</u>

	ROUTE	DESCR	RIPTIC	<u>L</u> ис	ericho	Road	over Blackberry Creek	Date (omp	leted	4/1	4/08
	SECT. <u>76-00092-01-BR</u>		STR	UCT. N	10. <u>0</u> .	<u>45-301</u>	10 DRILLED	BY TS	<u>3C L-</u>	70,889	}	
-	COUNTY Kane	LOCA	AOITA	l Soi	uth End	d Wes	t Abutment S 25,SE 1	<u>/4</u> , TV	VP	<u>38N</u> ,	RNG.	7E_
	Boring No. SB-1 Station ft		D E P	B L O W	Qu	w	Surface Water Elev. Groundwater Elev.: when drilling 650 at Completion 650	8.0 8.7	D E P	B L O W	Qu	W
_	Surface Elev. <u>666.98</u> f 7" Asphalt Pavement		- 	\$ 	tsf	%	after Hrs.		H	S	tsf	%
	4" Gravel and Sand Subbase	666.08		2	В	^·· <u>······</u>	Dense to very dense gray	_		15		
	FILL - Brown CLAY LOAM, trace gravel, moist A-4/A-6	_ 663.48		2 2 2	1.2 15%	14.3	SAND and GRAVEL, occasional Cobbles, saturated A-1-a			15 24 29		7.4
	FILL - Gray and black CLAY, trace organic, very moist A-7-6	661.48	-5	3 3 5	B 1.2 15%	27.3	Very dense Cobbles and	337,98 336,98		15 5/6"		9.7
	Medium stiff brown CLAY, little black clay, moist A-7-6	658.98		1 2 2	P 0.75	28.6		 				
	Med. dense brown SAND and GRAVEL, saturated A-1-a	 656.48	-10	2 5 5		10.3	DOLOMITE, light gray, mottled red and green from 34 to 40 feet, thin to med. bedded, silty, densely fractured, poor to very poor		35			Workshood L
	Med. dense gray SAND and GRAVEL, saturated A-1-a			4 5 7		14.6	Rock Mass Quality, green clay filled joint from 36 to 37.5 feet. Core Run from 30 to 40 feet	-				
	Med. dense gray SAND,	<u>653.98</u>	-15	4 6 8		14.8	Recovery = 100% RQD = 20%					
	little to some gravel, saturated A-1-b	- •		6 7 9		15.1	End of Boring at 40.0' Diedrich D-120 Truck Rig (#315)		1 0			
***		648.98					CME Automatic Hammer					
30/17/6	Advad dans on one	*****	-20	10 11 15	·	9.5	3.25" ID HSA Rock Core with NX Core Barrel		5			
2	Med. dense gray SAND and GRAVEL, occasional Cobbles, saturated A-1-a			9 12 13		8.7						
; ;	· · · · · · · · · · · · · · · · · · ·	- 541.98	~Z5I	9 10 12		9.3			1 7			
S	PT. (N) = Sum of last two bloc tations, Depths, Offset, and E	w values levation	in sa s are	imple. in Feet	(Qu) f	' B=Bulç	ge S=Shear P=Penetration Test	<u>,5</u>	T)			***************************************

Testing Service Corporation

STRUCTURE BORING LOG

Page 1 of 1

SECT 76-00092-01-BR						over Blackberry			***************************************		***************************************		
SECT. 76-00092-01-BR													,
COUNTY Kane	LOCA	NOITA	No	rth Enc	l East	Abutment	S	25,SE	1/4	TWP.	<u>38N</u>	, RNG.	<u>7E</u>
Boring No. SB-2 Station ft		DEP	B L O			Surface Water Groundwater when drillin	Elev.: g	6	<u>58.8</u>	D _. E _. P	В L О		
Surface Elev. 667.33 f	t		W S	Qu tsf	W %	at Completi			<u>58.9</u>	T	W S	Qu tsf	W %
6" Asphalt Pavement 7" Gravel and Sand Subbase	666.23		2	P		Very dense g	ray sanc	jy .			400/00		
Sample 1: LL/PL/PI=28/12/16			1 2	2.75	14.9	SILT, little gra A-4	avel, dan	ήp			100/6"		8.1
FILL - Brown LOAM, little gravel, moist									639.33				
A-6(7)	004.50	-5	2 3	9 3.5	14.1	Hard dark gra	ıy CLAY,	, moist			10 15 18	\$ 4.9 10%	14.6
Stiff black and dark brown CLAY, trace organic, very moist	661.83		3 4	B 1.1 15%	30.6	A-6			000 00				4
A-7-6	659,33		8	15%		Very dense gr and Boulders	ay Cobb	oles	<u>635.33</u>				
		10	5 7 8		12.9	weathered an Dolomite	d fractur	ed	622.22		18 40 44	<u> </u>	············
Loose to med. dense brown	_		, , , , , , , , , , , , , , , , , , , 	```		***************************************			632.33	<u>-35</u>	······································		<u> </u>
SAND, little gravel, trace silt, saturated A-1-b			5 4 3		9.1	SHALE, greer weathered	iish-gray	, very					
					.44.5	Core Run 35 t Recov. = 91%	, RQD =	12%	629.03				
		-15	6 9 9		14.4	SANDSTONE med. grained inclusions	, light grav with grav	/el	627.33	40			
	651.83	_		Visit shirt da 		SHALE, very v	veathere	ed	626.33				İ
			9 18 19		6.4	SANDSTONE fine grained wi	ith occas	ay.					
Dense to very dense gray GRAVEL, little sand,	•		45		H	2" cse. sand la DOLOMITE, gred and green,	ray, moti	tled,	624.33				
numerous Cobbles and Boulders (rock fragments recovered), saturated	_	-20	0/2"		6.6	bedded with gr partings	een clay		622.33	-45	***********		
4-1-a	**	1	6			End of Boring		.					
,	- 644.33		2 <u>2</u> ———			CME Automation 3.25" ID HSA	ം ലമന്ന്ന	U I					
/ery dense gray SAND and GRAVEL, saturated	 	1 2	.5 :0		li	2" NX Core Ba	rrel						,,,,,,,,,,,,,,,,,,,,,,,,,,,,,,,,,,,,,,,
A-1-a PT. (N) = Sum of last two blocks to be contact.	642.33	-25]	20 11							 50			

WILLS BURKE KELSEY ASSOCIATES LTD.


116 West Main Street, Suite 201
St. Charles, Illinois 60174

	USER NAME = nparris	DESIGNED	-	HLF	REVISED	-
•		CHECKED	-	AEU	REVISED	-
	PLOT SCALE = \$SCALE\$	DRAWN	-	HLF	REVISED	-
	PLOT DATE = 7/9/2013	CHECKED	-	AEU	REVISED	-

STATE OF ILLINOIS				
DEPARTMENT OF TRANSPORTATION				

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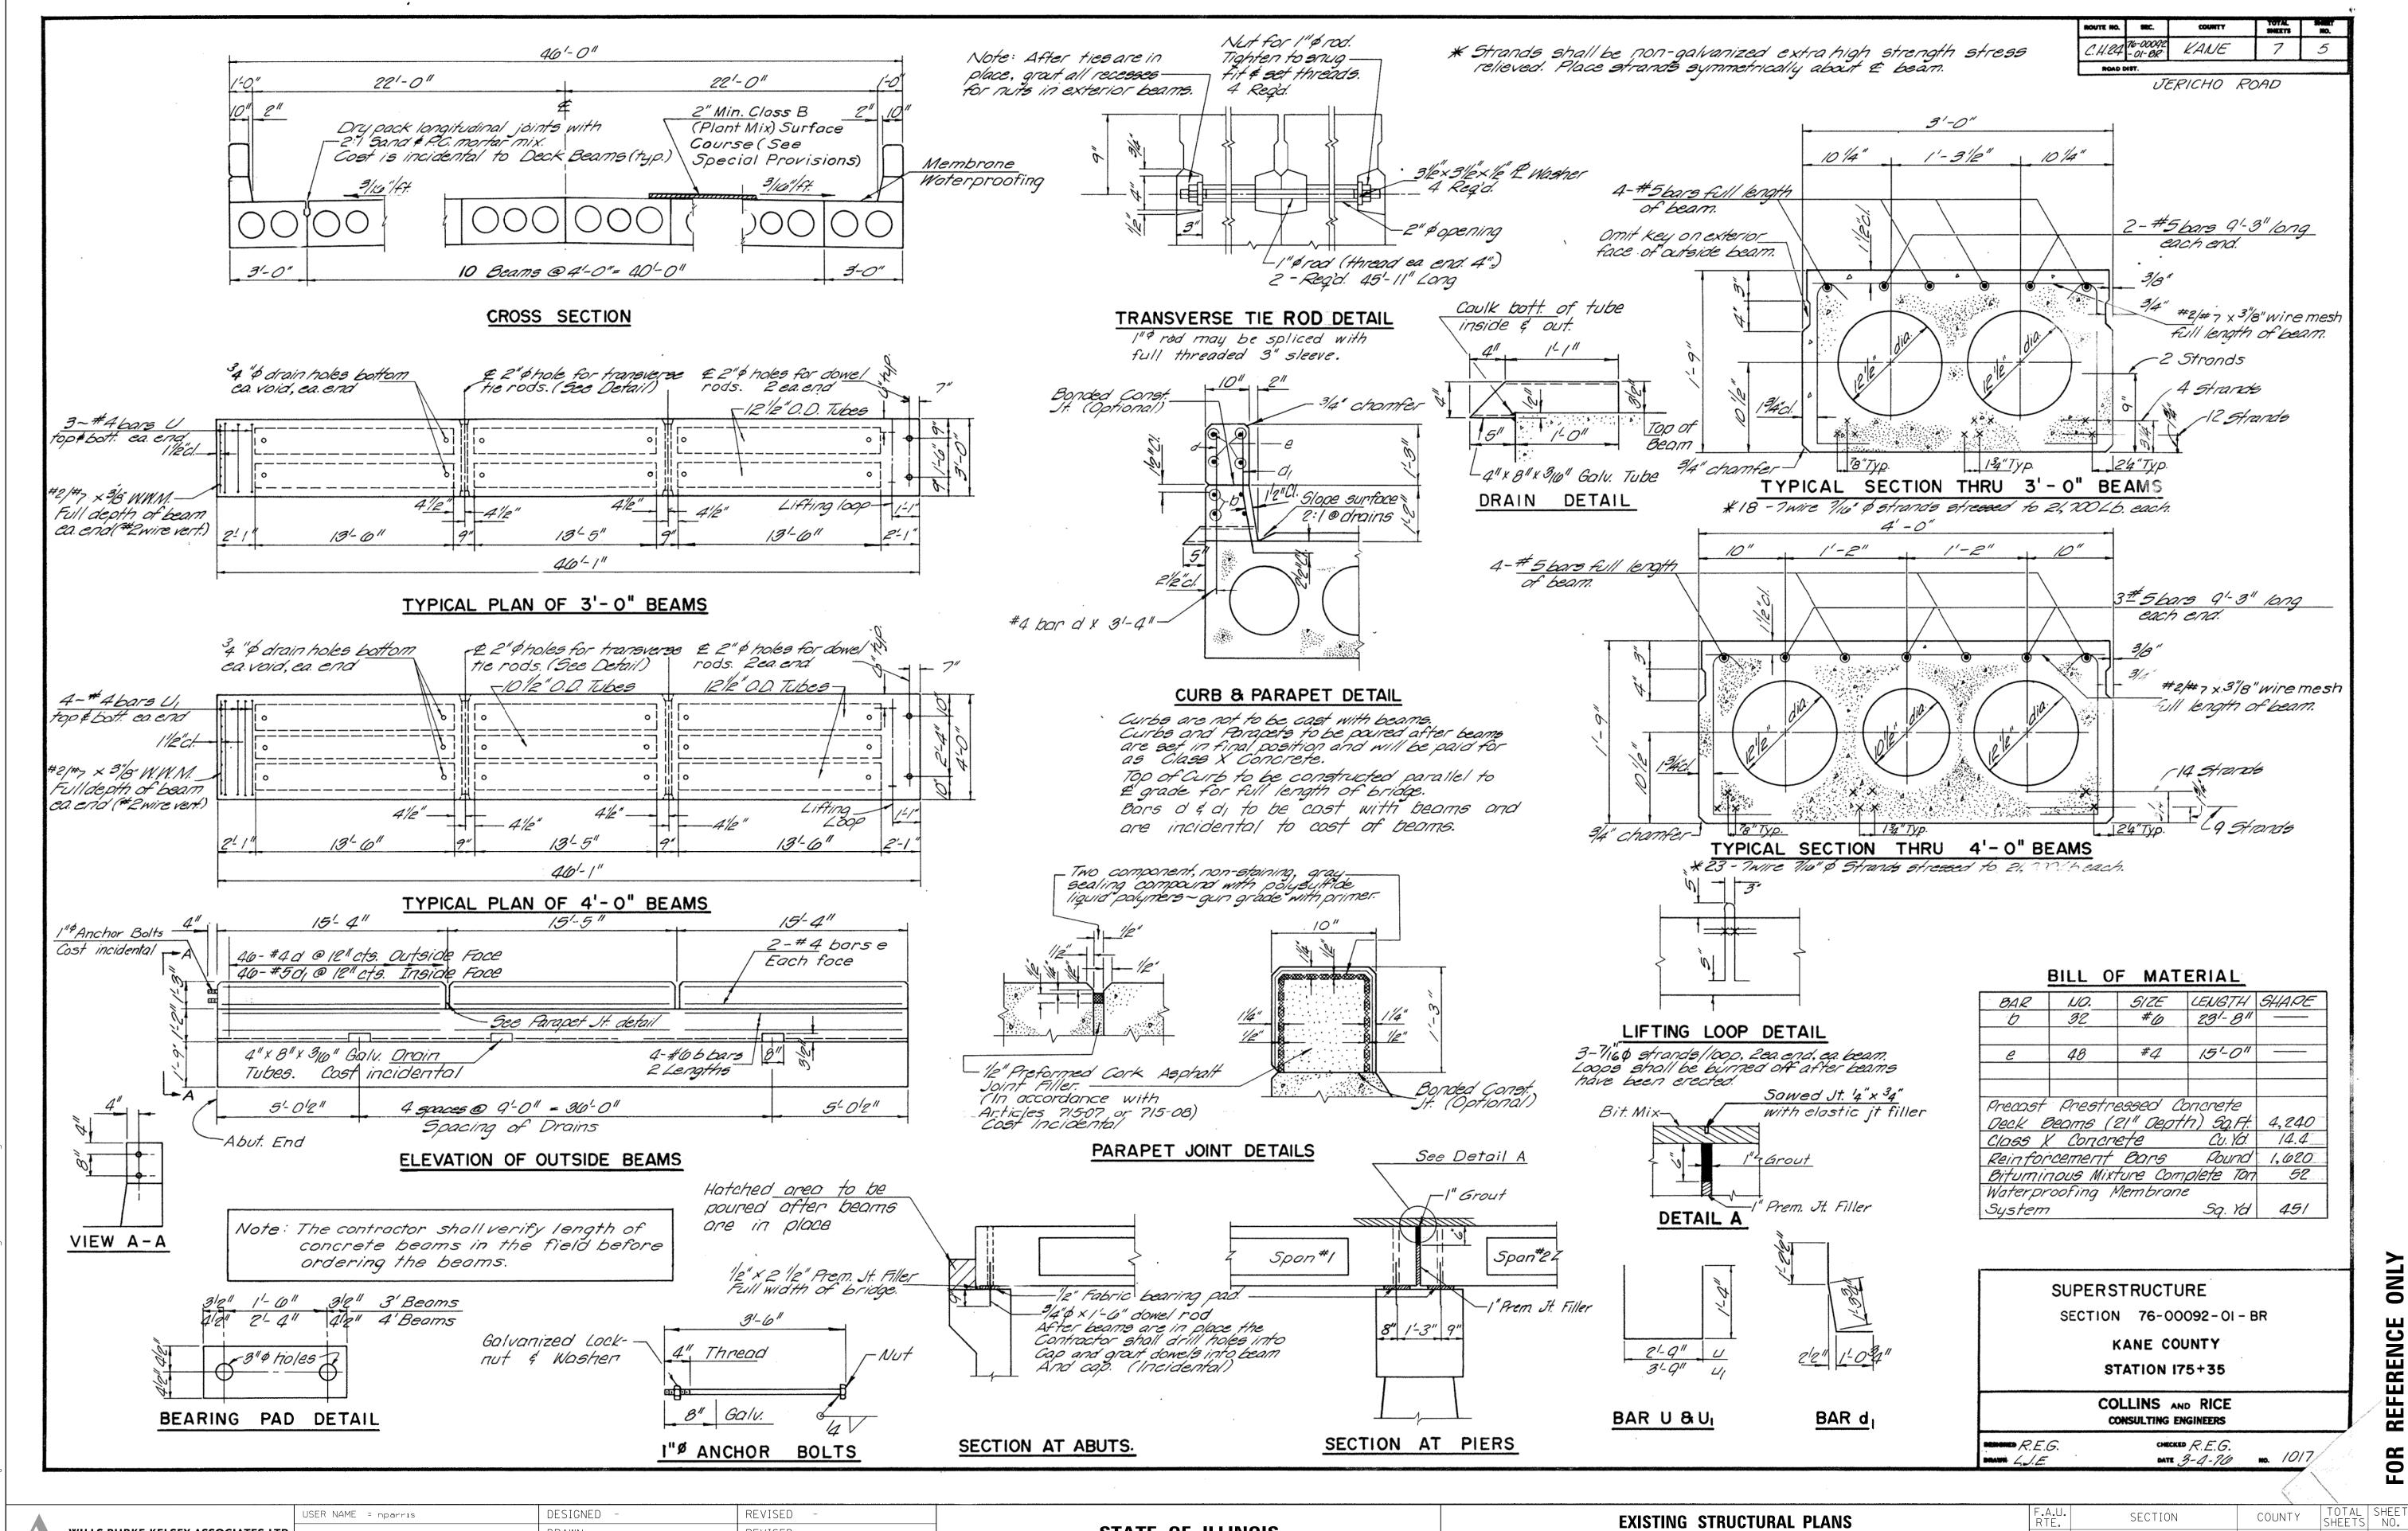
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RUCTURE NO. 045-3190	1542	04-00329-00-BR	KANE	86	57
1001011L 140. 043-3130			CONTRACT	NO. X	XXXX
HEFT NO. 15 OF 15 SHEFTS		ILLINOIS FED A	ID PROJECT		

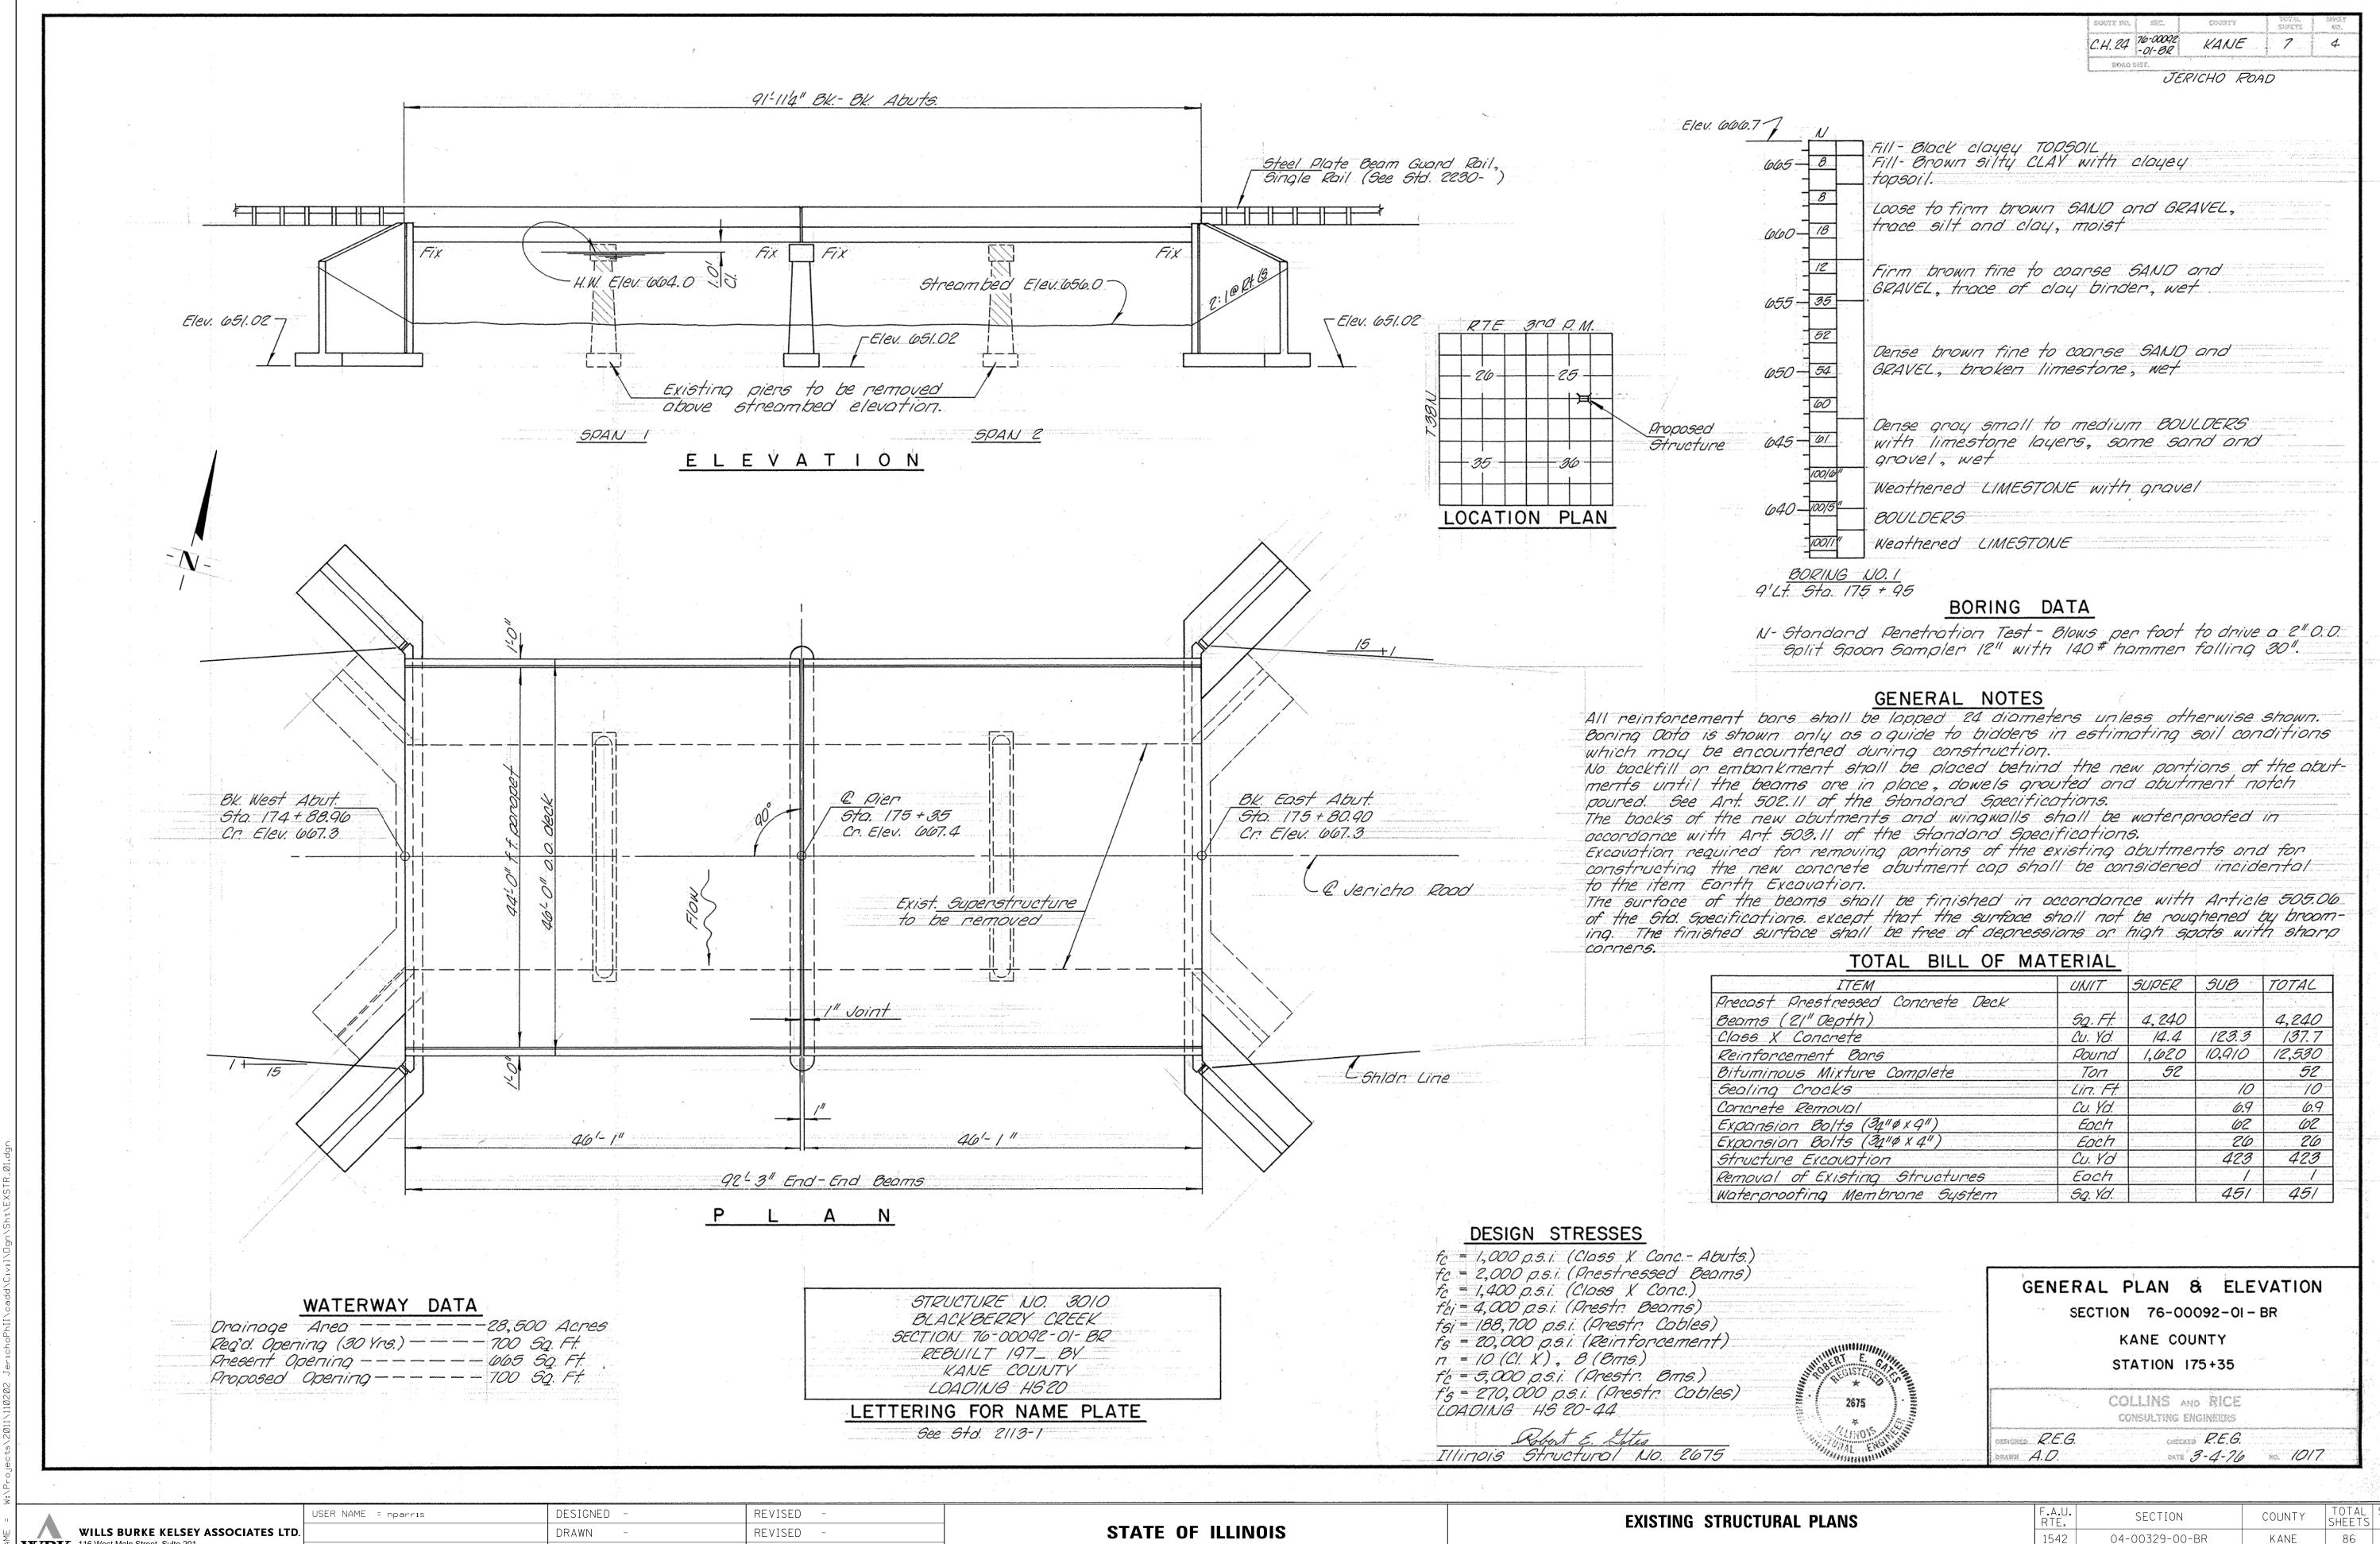

86 58 CONTRACT NO.

ERENCE

SCALE: N.T.S.



WILLS BURKE KELSEY ASSOCIATES LTD.

116 West Main Street, Suite 201
St. Charles, Illinois 60174

	USER NAME = nparris	DESIGNED -	REVISED -
).		DRAWN -	REVISED -
	PLOT SCALE = 1:20	CHECKED -	REVISED -
	PLOT DATE = 7/9/2013	DATE -	REVISED -

STATE OF ILLINOIS
DEPARTMENT OF TRANSPORTATION

SCALE: N.T.S.


	EXIST	ING S	TRUCTUF	RAL PLANS		
SHEET	NO. 2	OF 4	SHEETS	STA.	TO STA.	

SECTION COUNTY TOTAL SHEETS NO.

04-00329-00-BR KANE 86 59

CONTRACT NO.

ILLINOIS FED. AID PROJECT

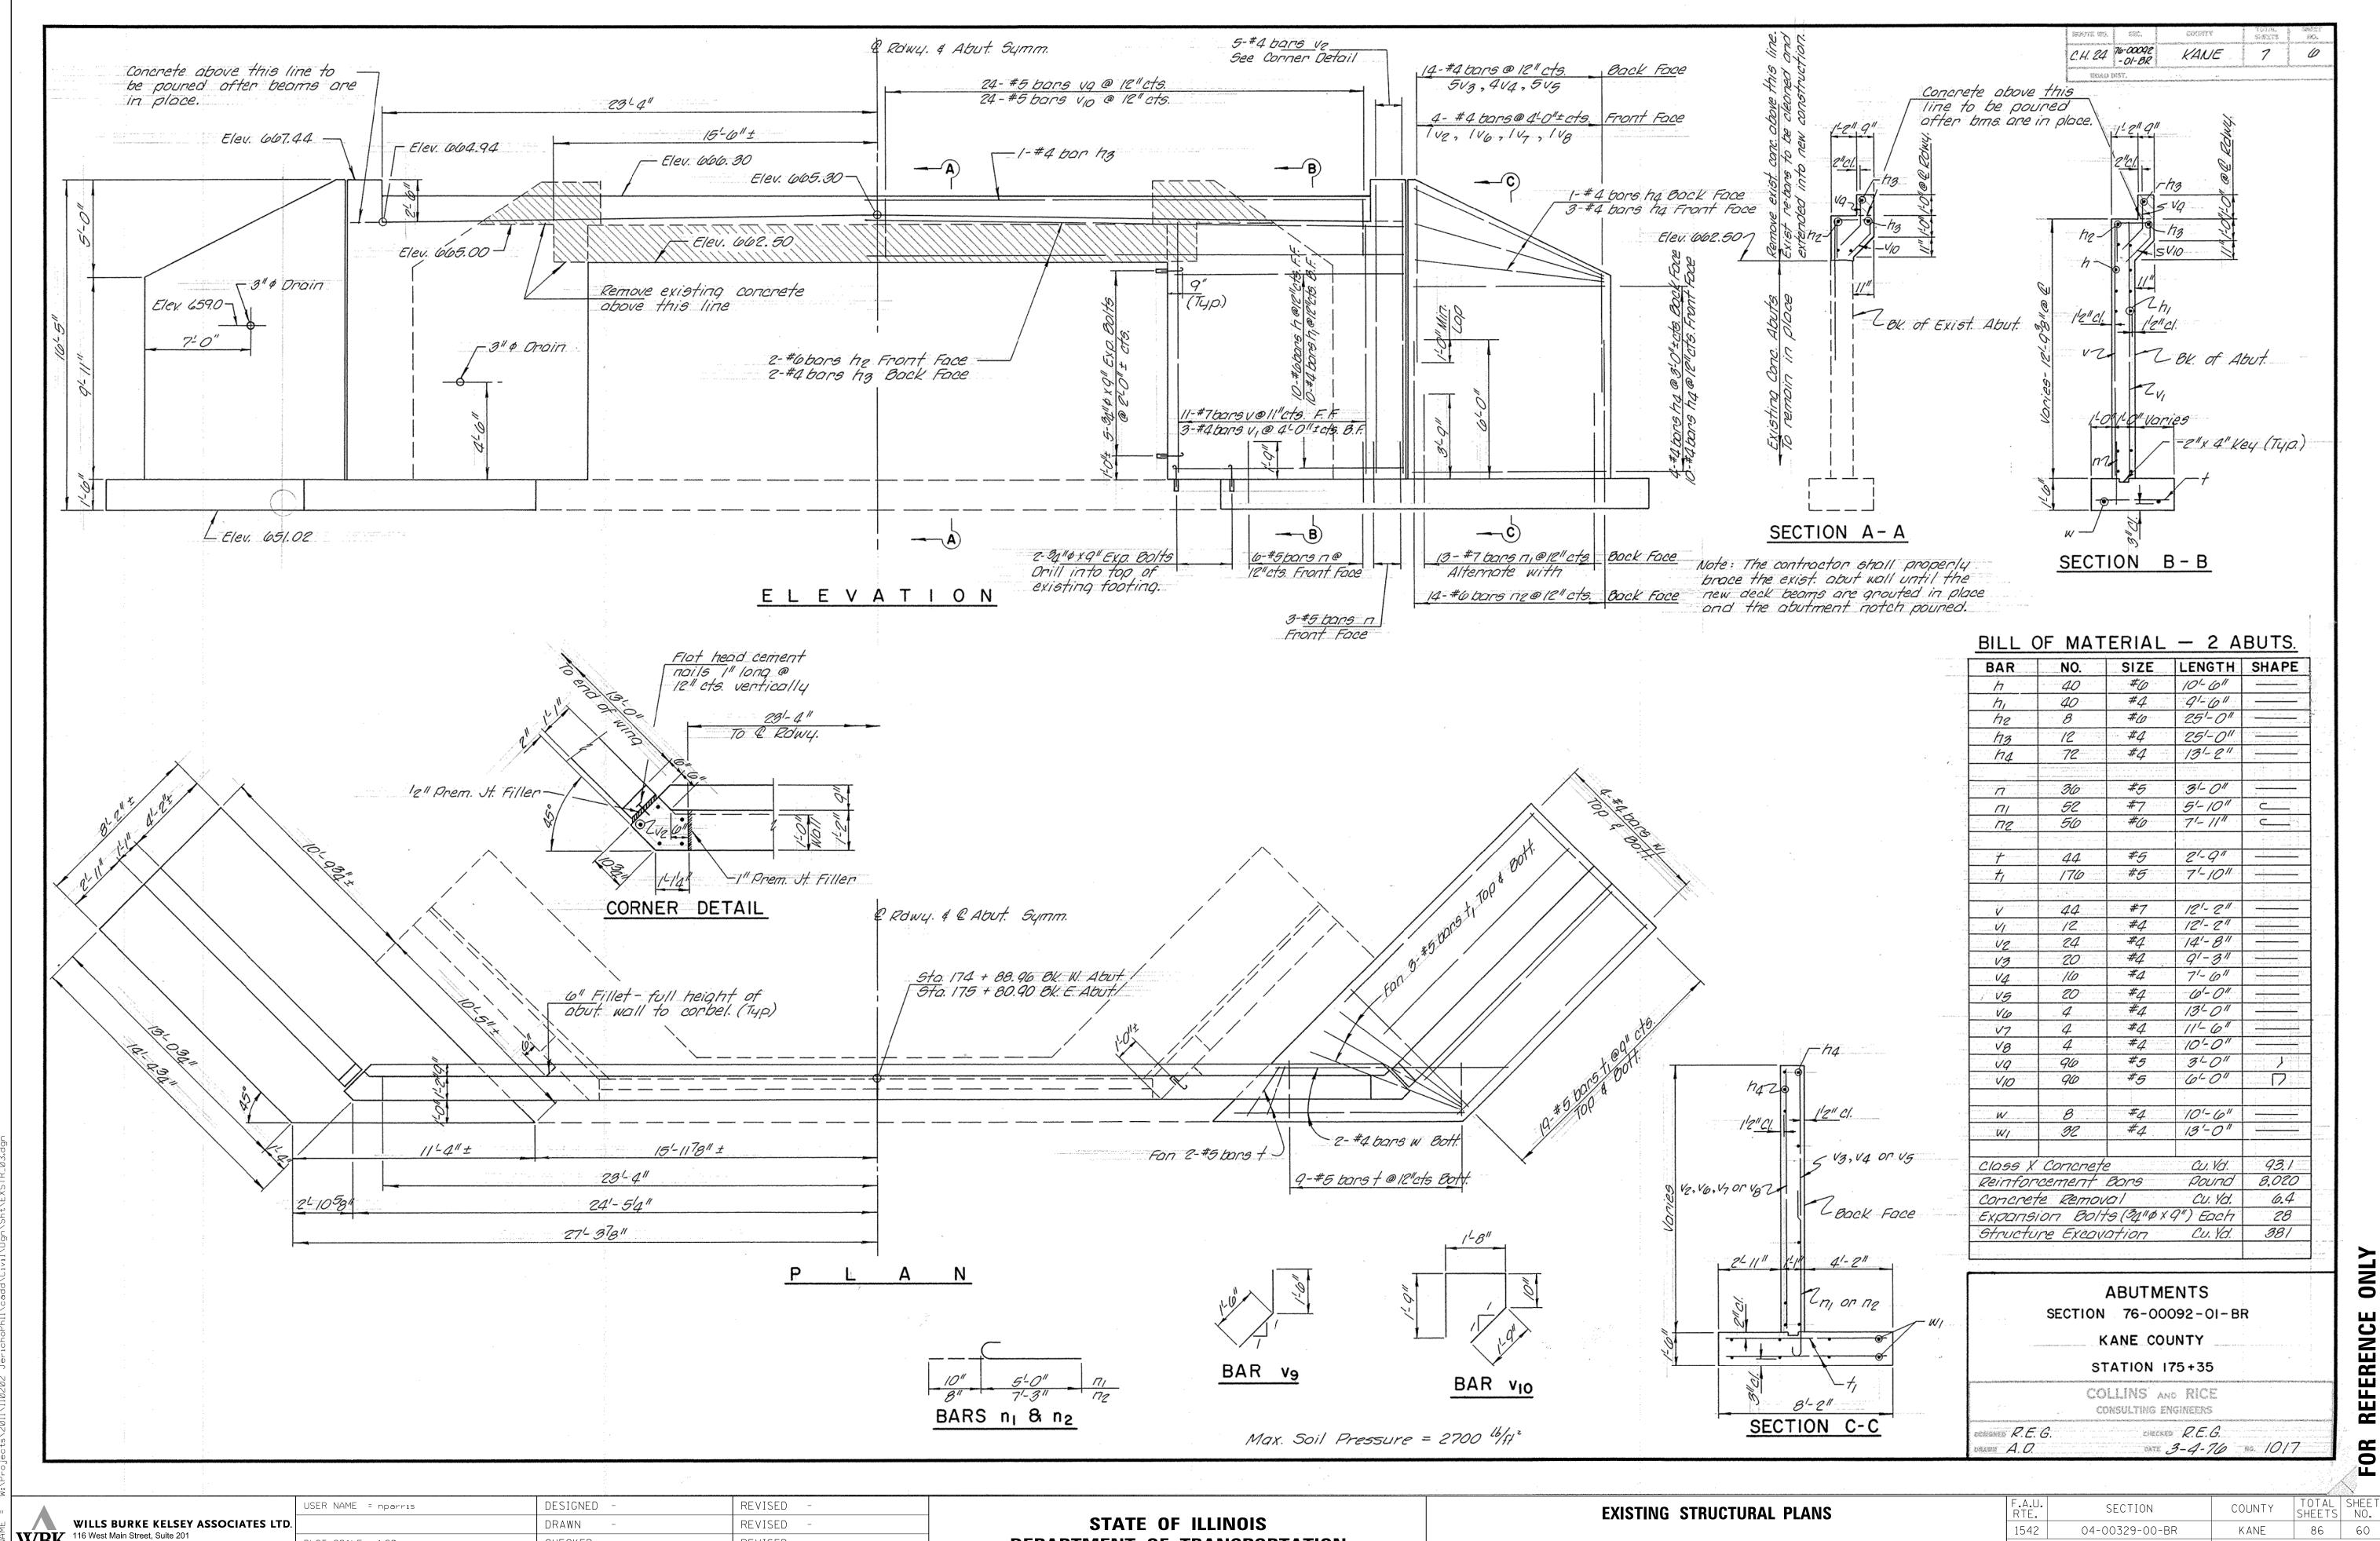

WBK 116 West Main Street, Suite 201 St. Charles, Illinois 60174


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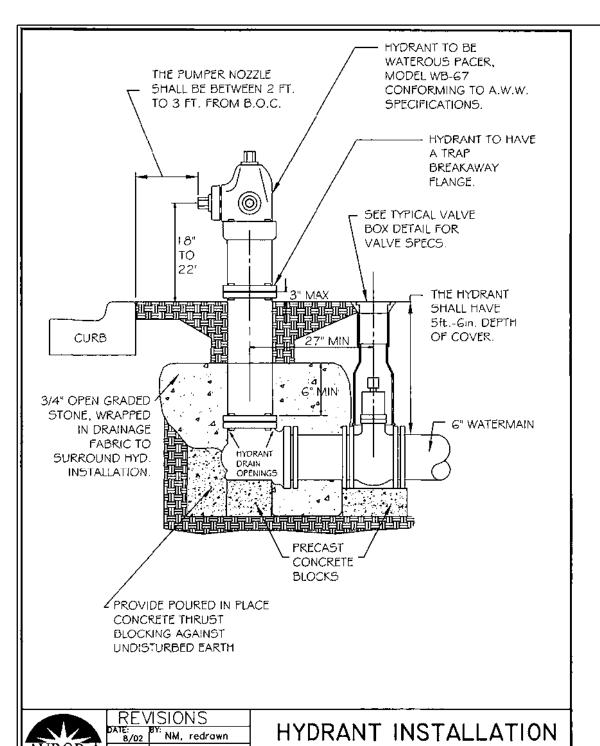
DEPARTMENT OF TRANSPORTATION

SCALE: N.T.S.


SHEET NO. 3 OF 4 SHEETS STA. TO STA.


CONTRACT NO. ILLINOIS FED. AID PROJECT




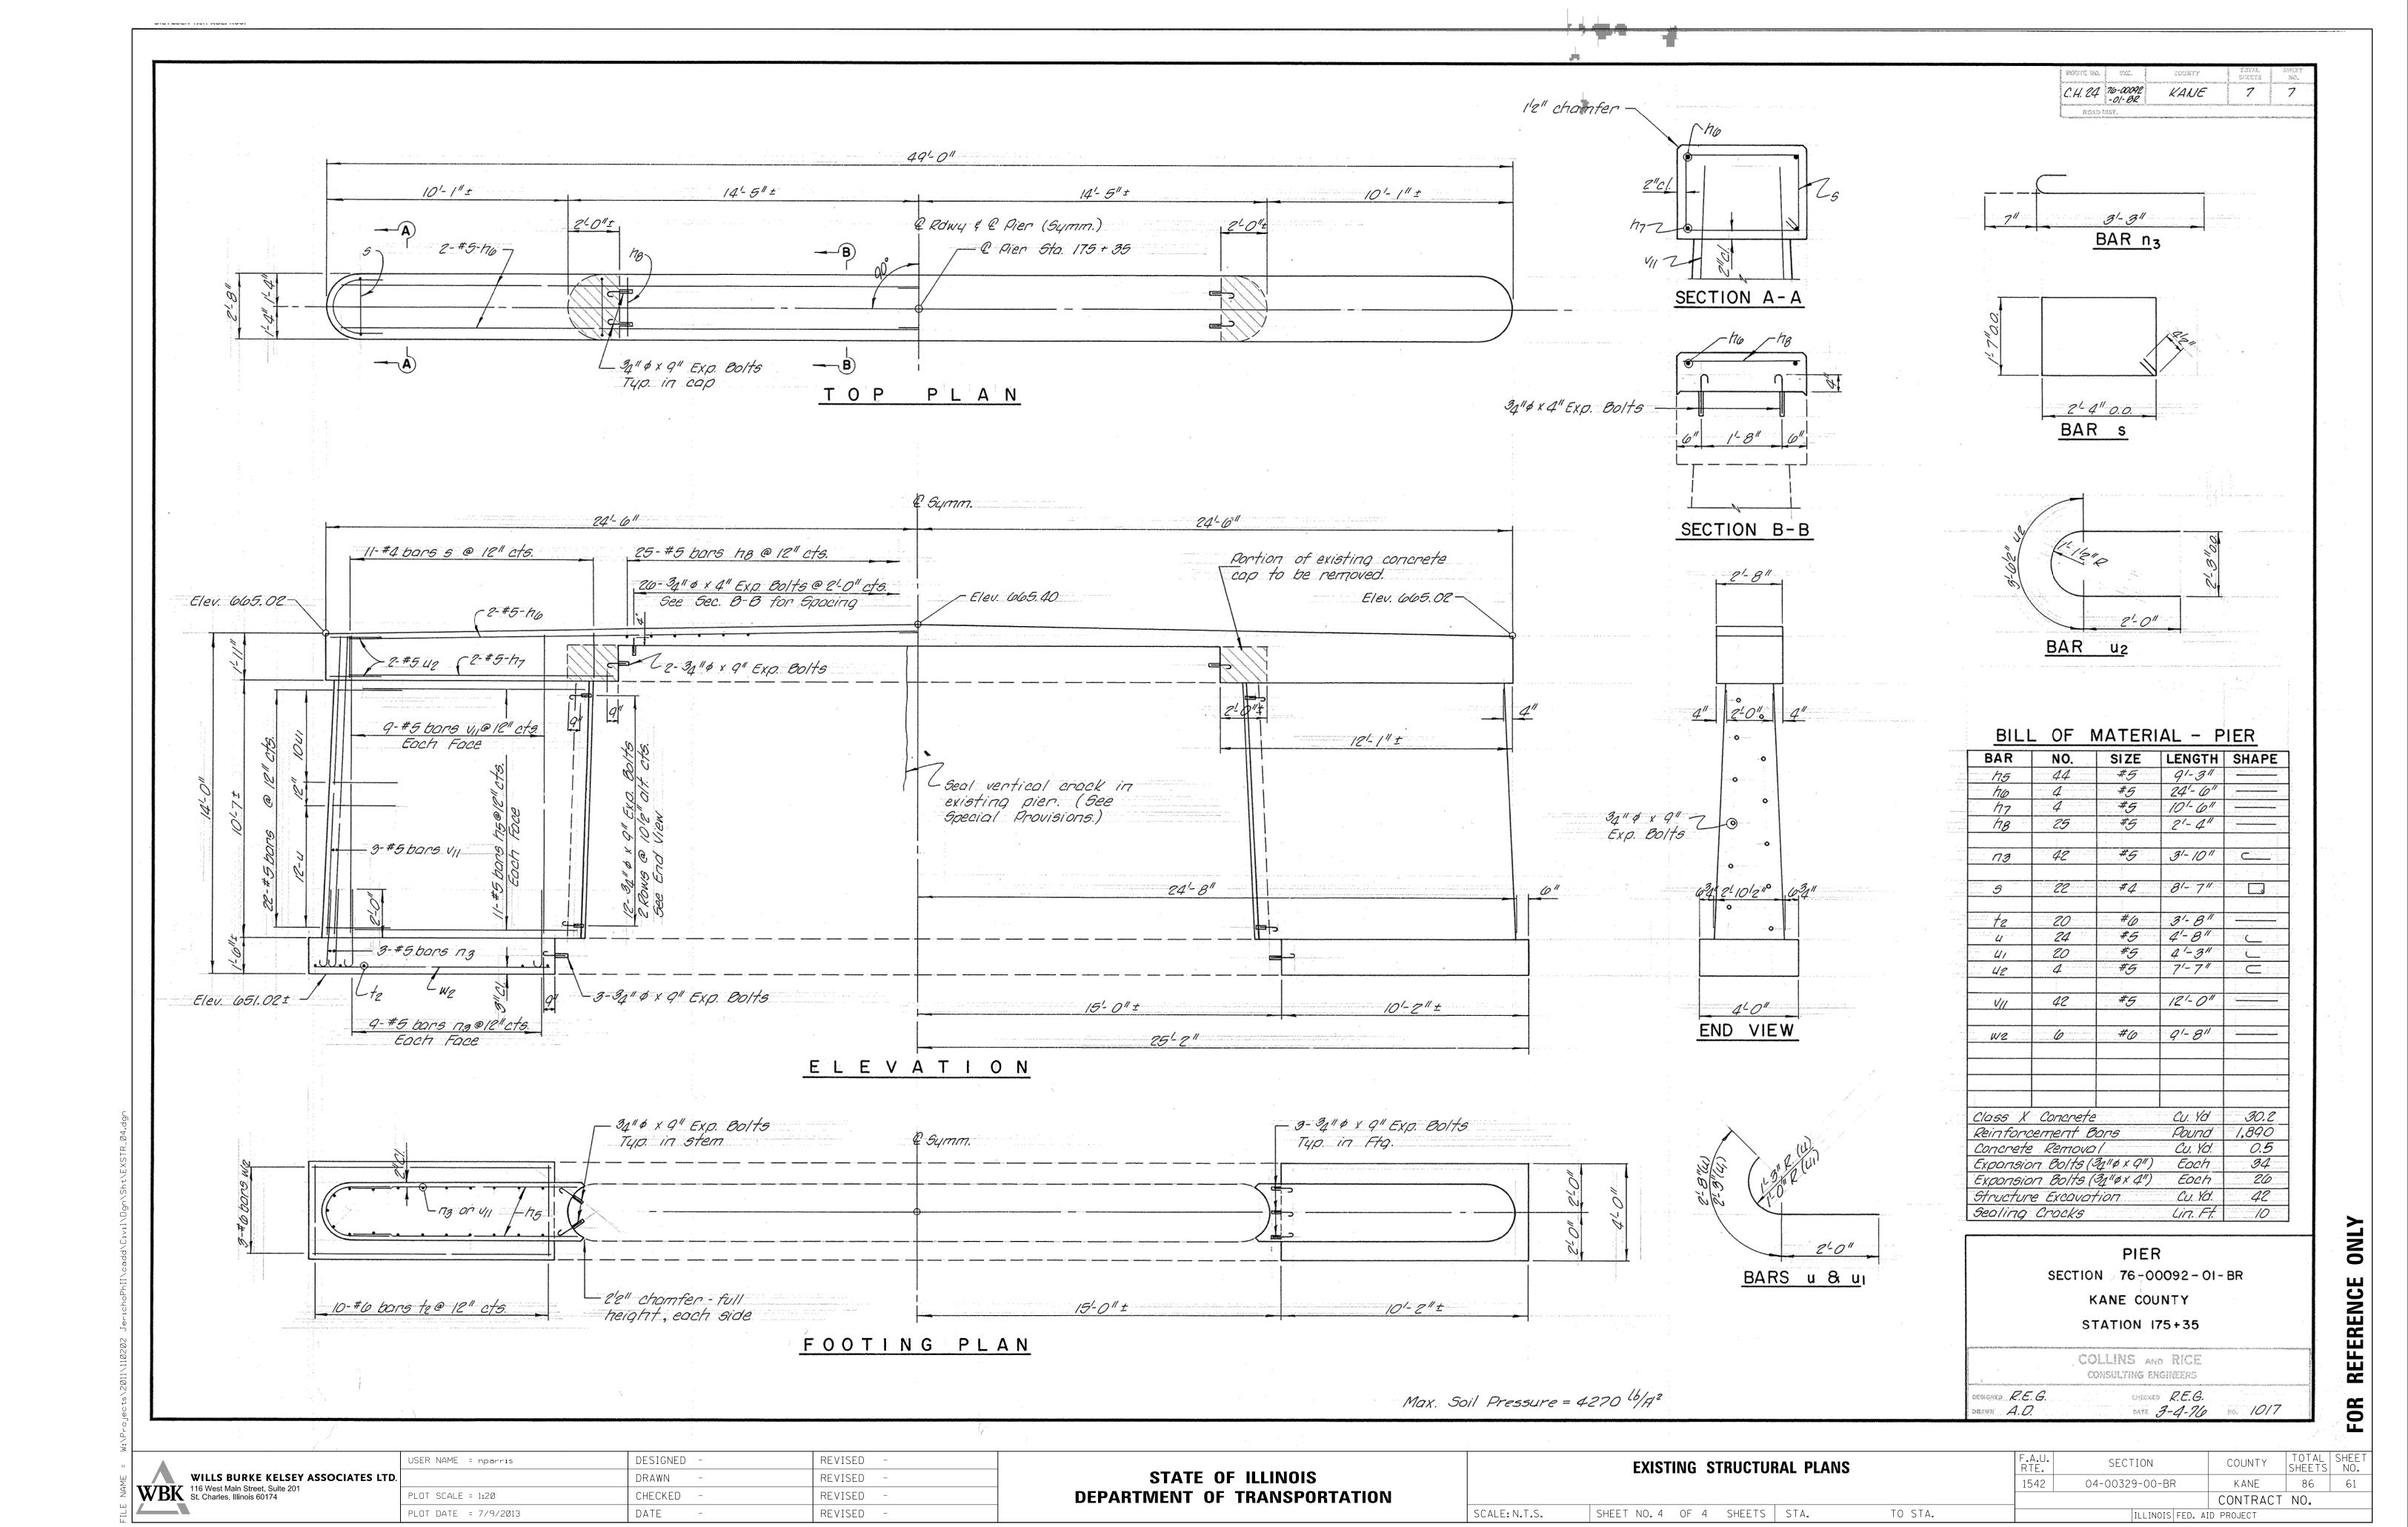



ENGINEERING

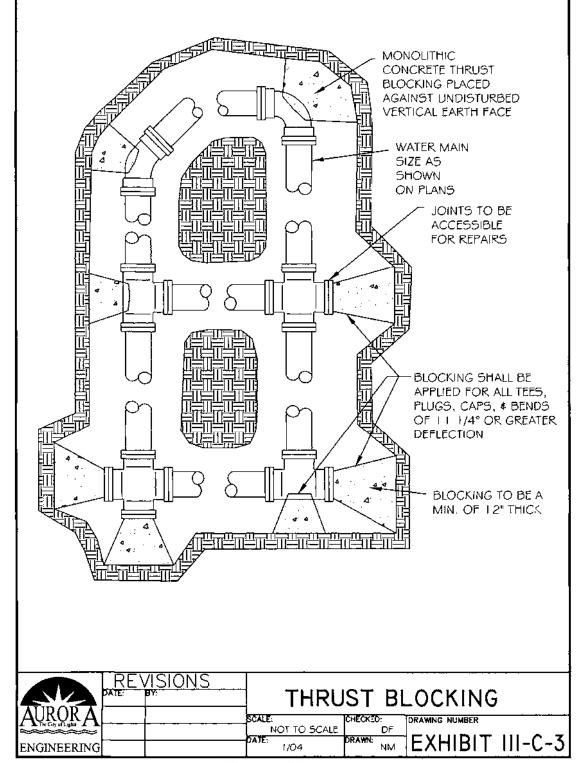

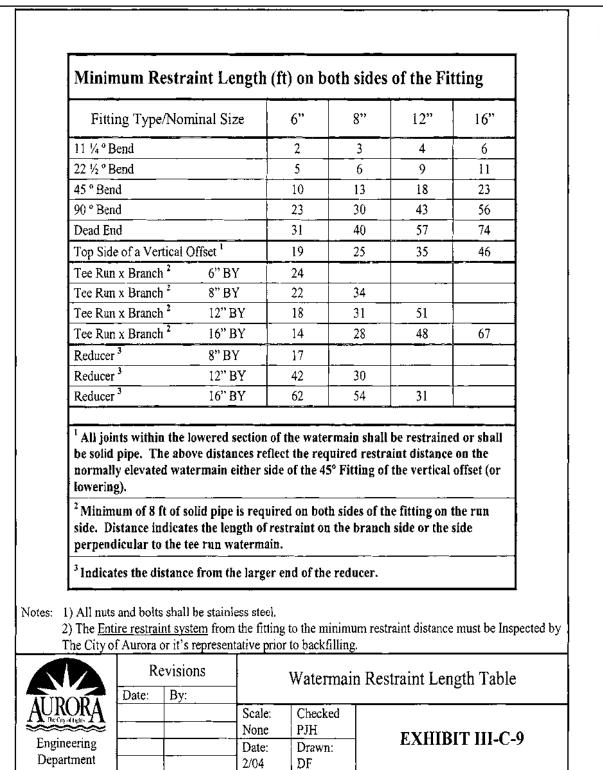


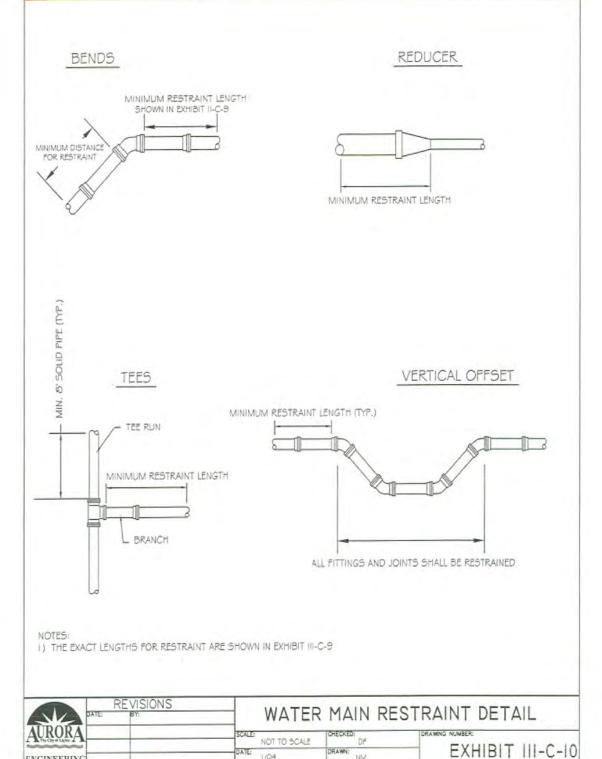


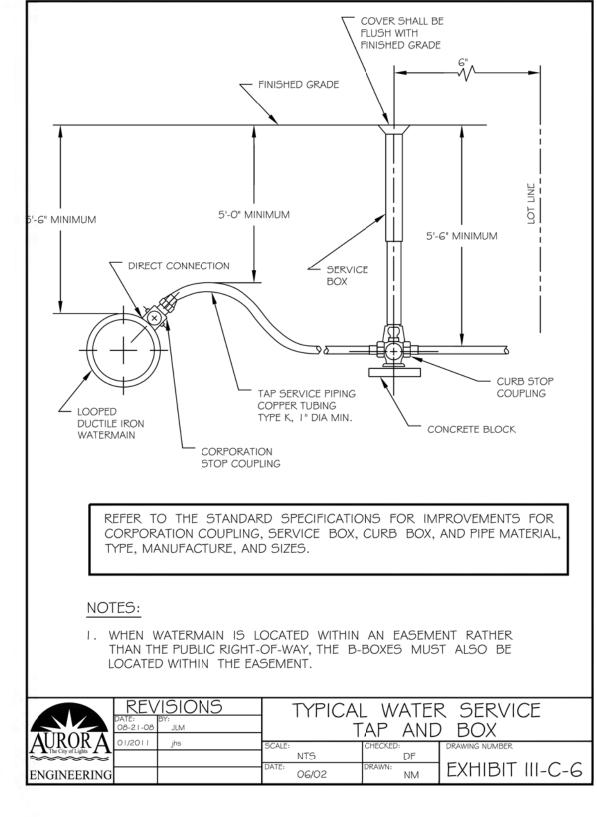


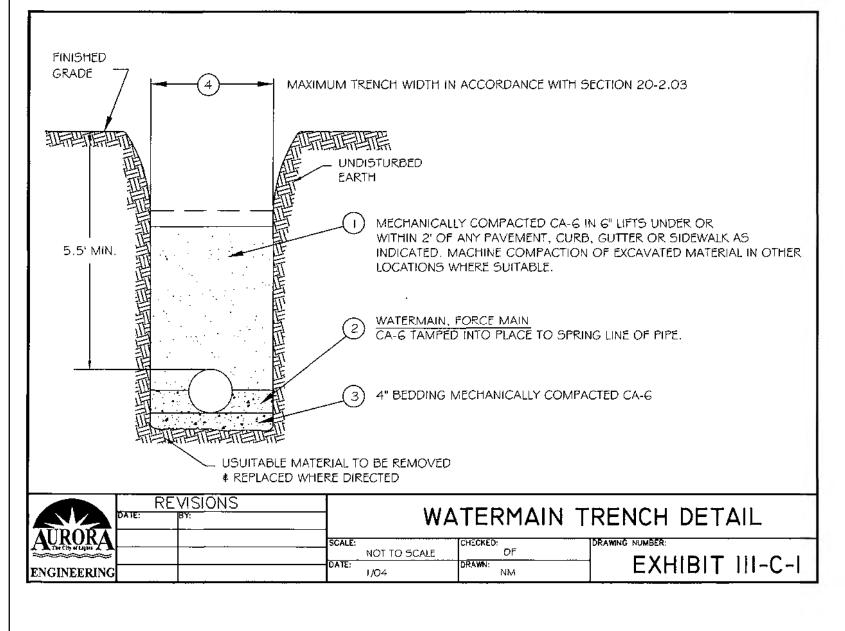



NMSA EXHIBIT III-C-7

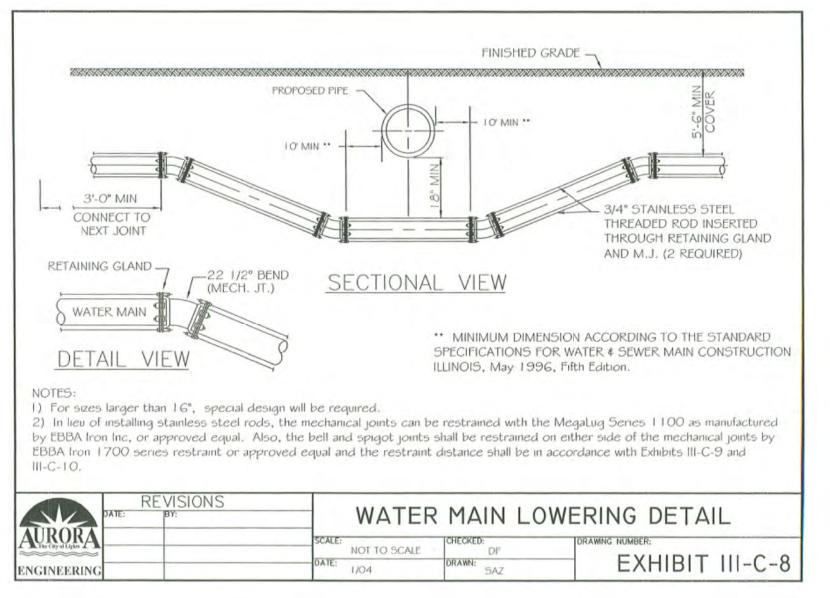


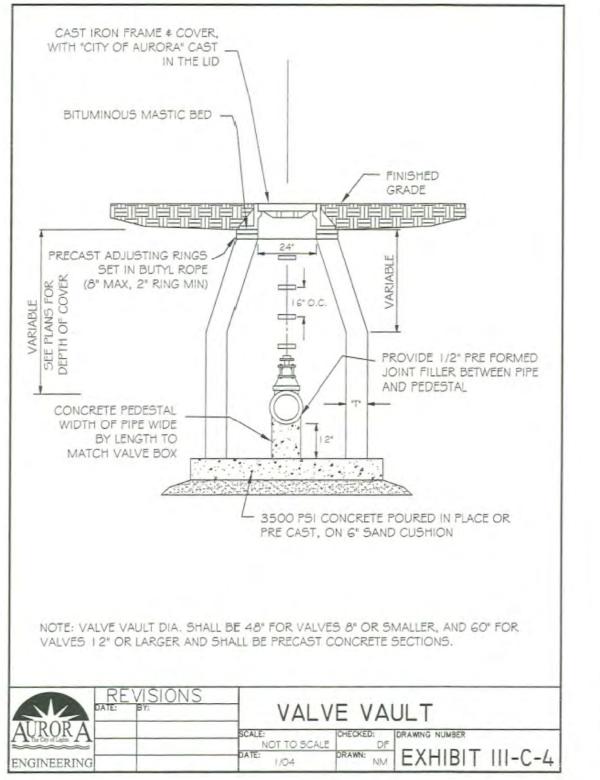

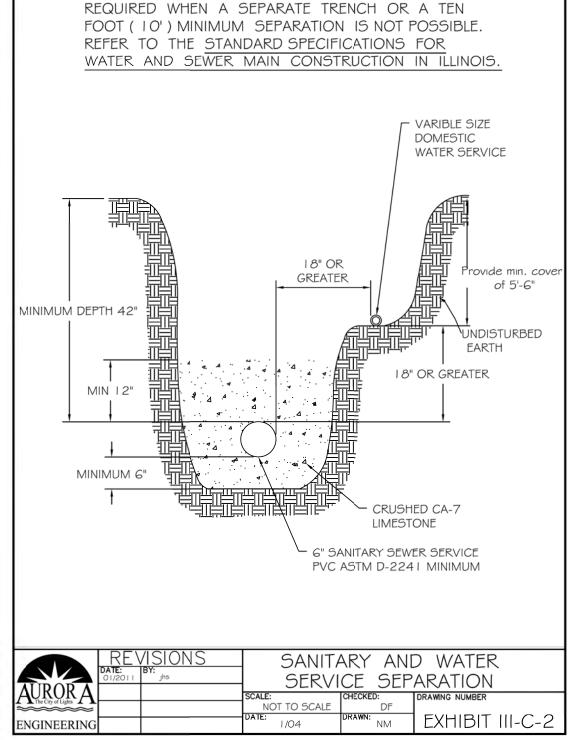

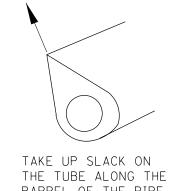

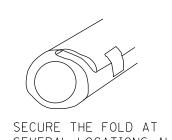

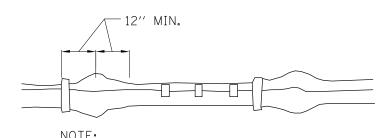

ONE LENGTH OF POLYETHYLENE TUBE FOR EACH LENGTH OF PIPE, OVERLAPPED AT JOINT.

REPAIR ALL SMALL RIPS, TEARS OR OTHER TUBE DAMAGE WITH ADHESIVE TAPE.

POLYETHYLENE ENCASEMENT

WILLS BURKE KELSEY ASSOCIATES LTD. WBK 116 West Main Street, Suite 201 St. Charles, Illinois 60174

	USER NAME = nparris	DESIGNED -	REVISED -
D.		DRAWN -	REVISED -
	PLOT SCALE = 1:20	CHECKED -	REVISED -
	PLOT DATE = 7/9/2013	DATE -	REVISED -

STATE OF ILLINOIS
DEPARTMENT OF TRANSPORTATION

SCALE: N.T.S.

1	DETAILS			F.A.U. RTE.	SECTION	COUNTY	TOTAL SHEETS	SHEET NO.
				1542	04-00329-00-BR	KANE	86	62
						CONTRACT	NO.	
SHEET NO.1 OF 4	SHEETS	STA.	TO STA.		ILLINOIS FED. A	ID PROJECT		

THE TUBE ALONG THE BARREL OF THE PIPE TO MAKE A SNUG, BUT NOT TIGHT, FIT.

FOLD EXCESS POLY-ETHYLENE BACK OVER

SEVERAL LOCATIONS ALONG THE TOP OF THE PIPE. THE PIPE BARREL (APPROX. EVERY THREE FEET).

N.T.S.

SCALE 2:1

SEEDING, CLASS 2A					
LBS. / ACRE	COMMON NAME				
70.000	TALL FESCUE (INFERNO, TARHEEL II, QUEST, BLADE RUNNER OR FALCON IV)				
20.000	PERENNIAL RYEGRASS				
20.000	RED FESCUE (AUDUBON, SEA LINK OR EPIC)				
20.000	HARD FESCUE (RESCUE 911, SPARTAN II OR RELIANT IV)				
70.000	FULTS SALT GRASS OR SALTY ALKALIGRASS				
200.000	TOTAL WEIGHT OF SEEDS (LBS)				

	SEEDING, CLASS 4						
LBS. / ACRE	SCIENTIFIC NAME	COMMON NAME	C - VALUE	IND. STATUS			
4.000	ANDROPOGON GERARDII	BIG BLUESTEM	5	FAC			
5.000	ANDROPOGON SCOPARIUS	LITTLE BLUESTEM	5	FACU			
5.000	BOUTELOUA CURTIPENDULA	SIDE OATS	8	UPL			
1.000	ELYMUS CANADENSIS	CANADA WILD RYE	4	FAC-			
1.000	PANICUM VIRGATUM	SWITCH GRASS	.5	FAC+			
2.000	SORGHASTRUM NUTANS	INDIAN GRASS	5	FACU+			
15.000	LOLIUM PRENNE	PERENNIAL RYEGRASS	0	FACU			
33.000	TOTAL WEIGHT OF SEEDS (LBS)						
COVER CRO	P:			_			
25.000	LOLIUM MULTIFLORUM	ANNUAL RYEGRASS	0	UPL			
25.000	AVENA SATIVA	OATS	0	UPL			

SCIENTIFIC NAME	COMMON NAME	C - VALUE	IND. STATUS
AMORPHA CANESCENS *	LEADPLANT	9	UPL
ANEMONE CYLINDRICA	THIMBLE WEED	6	UPL
ASCLEPIAS TUBEROSA	BUTTERFLY WEED	7	UPL
ASTER AZUREUS	SKY BLUE ASTER	8	UPL
ASTER LAEVIS	SMOOTH BLUE ASTER	9	UPL
ASTER NOVAE-ANGLIAE	NEW ENGLAND ASTER	4	FACW
BAPTISIA LEUCANTHA*	WILD WHITE INDIGO	8	FACU+
COREOPSIS PALMATA	PRAIRIE COREOPSIS	6	UPL
ECHINACEA PALLIDA	PALE PURPLE CONEFLOWER	8	UPL
ERYNGIUM YUCCIFOLIUM	RATTLESNAKE MASTER	9	FAC+
HELIANTHUS MOLLIS	DOWNY SUNFLOWER	9	UPL
HELIOPSIS HELIANTHOIDES	OX-EYE SUNFLOWER	5	UPL
LIATRIS ASPERA	BUTTON BLAZING STAR	6	UPL
LIATRIS PYCNOSTACHYA	PRAIRIE BLAZING STAR	8	FAC-
MONARDA FISTULOSA	BERGAMOT	4	FACU
PARTHENIUM INTEGRIFOLIUM	WILD QUININE	8	UPL
PETALOSTEMUM CANDIDUM *	WHITE PRAIRIE CLOVER	9	UPL
PETALOSTEMUM PURPUREUM *	PURPLE PRAIRIE CLOVER	9	UPL
PHYSOSTEGIA VIRGINIANA	FASE DRAGONHEAD	6	OBL
POTENTILLA ARGUTA	PRAIRIE CINQUEFOIL	9	FACU-
RATIBIDA PINNATA	YELLOW CONEFLOWER	4	UPL
RUDBECKIA SUBTOMENTOSA	SWEET CONEFLOWER	9	FACU+
SILPHIUM LACINIATUM	COMPASS PLANT	5	UPL
SILPHIUM TEREBINTHINACEUM	PRAIRIE DOCK	5	FACU
SOLIDAGO RIGIDA	STIFF GOLDENROD	4	FACW-
TRADESCANTIA OHIENSIS	SPIDERWORT	2	FACU+
VERONICASTRUM VIRGINICUM	CULVER'S ROOT	7	FAC


* INNOCULATION REQUIRED

	SEEDIN	G, CLASS 4A		
LBS. / ACRE	SCIENTIFIC NAME	COMMON NAME	C - VALUE	IND. STATUS
5.000	ANDROPOGON SCOPARIUS	LITTLE BLUESTEM	5	FACU-
5.000	BOUTELOUA CURTIPENDULA	SIDE OATS	8	UPL
1.000	ELYMUS CANADENSIS	CANADA WILD RYE	4	FAC-
0.500	SPOROBOLUS HETEROLEPIS	PRAIRIE DROPSEED	7	UPL
15.000	LOLIUM PRENNE	PERENNIAL RYEGRASS	0	FACU
26.500	TOTAL WEIGHT OF SEEDS (LBS)			
COVER CROI	P:			
10.000	LOLIUM MULTIFLORUM	ANNUAL RYEGRASS	0	UPL
32.000	AVENA SATIVA	OATS	0	UPL


LBS/ACRE	SCIENTIFIC NAME	COMMON NAME	C-VALUE	IND. STATUS
1.000	BROMUS LATIGLUMIS	EAR-LEAFED BROME	5	FACW-
0.250	CAREX LUPULIFORMIS	KNOBBED HOP SEDGE	10	OBL
0.250	CAREX NORMALIS	NORMAL SEDGE	5	FAC
0.250	CAREX PROJECTA	NECKLACE SEDGE	4	FACW+
5.000	ELYMUS CANADENSIS	NODDING WILD RYE	4	FAC-
5.000	ELYMUS RIPARIUS	RIVERBANK WILD RYE	5	FAC-
5.000	ELYMUS VILLOSUS	SILKY WILD RYE	5	FACU
8.000	ELYMUS VIRGINICUS	VIRGINIA WILD RYE	4	FACW-
1.000	GLYCERIA STRIATA	FOWL MANNA GRASS	4	FACW
0.250	JUNCUS SPP.	RUSH SPECIES		
10.000	POA PALUSTRIS	MARSH BLUE GRASS	9	FACW+
10.000	POA TRIVIALIS	ROUGH BLUE GRASS	34.	FACW
46.000	TOTAL WEIGHT OF SEED	OS (LBS)		
OVER CRO	P:			
5.000	AGROSTIS ALBA	RED TOP GRASS	0	FACW
20.000	AVENA SATIVA	OATS	0	UPL

LBS/ACRE	SCIENTIFIC NAME	COMMON NAME
0.060	ACORUS CALAMUS	SWEET FLAG
0.120	ANGELICA ATROPURPUREA	ANGELICA
0.040	ASCELEPIA INCARNATA	SWAMP MILKWEED
0.200	ASTER PUNICEUS	PURPLE STEMMED ASTER
0.140	BIDENS CERNUA	BEGGARS TICKS
0.140	EUPATORIUM MACULATUM	SPOTTED JOE PYE WEED
0.140	EUPATORIUM PERFOLIATUM	BONESET
0.040	HELENIUM AUTUMNALE	SNEEZEWEED
0.040	IRIS VIRGINICA SHREVEI	BLUE FLAG IRIS
0.100	LOBELIA CARDINALIS	CARDINAL FLOWER
0.100	LOBELIA SIPHILITICA	BLUE LOBELIA
0.040	LYTHRUM ALATUM	WINGED LOOSESTRIFE
0.100	PHYSOSTEGIA VIRGINIANA	FALSE DRAGONHEAD
0.200	POLYGONIUM PENSYLVANICUM	PENNSYLVANIA SMARTWEED
0.200	POLYGONIUM LAPATHIFOLIUM	CURLYTOP SMARTWEED
0.100	PYCHANTHEMUM VIRGINIANUM	MOUNTAIN MINT
0.100	RUDBECKIA LACINIATA	CUT-LEAF CONEFLOWER
0.040	SOLIDAGO RIDDELLII	RIDDELL GOLDENROD
0.100	SPARGANIUM EURYCARPUM	GIANT BURREED
2.000	TOTAL WEIGHT OF SEEDS (LBS)	

	PLANTING WOODY PLANTS								
Quantity	Code	Scientific Name	Common Name	Size	Type				
2.000	QA	QUERCUS ALBA	WHITE OAK	2-1/2" CALIPER	BALLED AND BURLAPPED				
2.000	AS	ACER SACCHARUM	SUGAR MAPLE	3" CALIPER	BALLED AND BURLAPPED				
2.000	AG	AMELANCHIER X GRANDIFLORA	APPLE SERVICEBERRY	7' HEIGHT	BALLED AND BURLAPPED				
1.000	MP	MALUS 'PRAIRIFIRE'	PRAIRIFIRE CRABAPPLE	8' HEIGHT	BALLED AND BURLAPPED				
2.000	OV	OSTRYA VIRGINIANA	AMERICAN HOPHORNBEAM	8' HEIGHT	BALLED AND BURLAPPED				
2.000	GD	GYMNOCLADUS DIOICUS	KENTUCKY COFFEETREE	4" CALIPER	BALLED AND BURLAPPED				
2.000	QM	QUERCUS MACROCARPA	BUR OAK	3" CALIPER	BALLED AND BURLAPPED				
13.000	TOTAL W	OODY PLANTS	•	•	•				

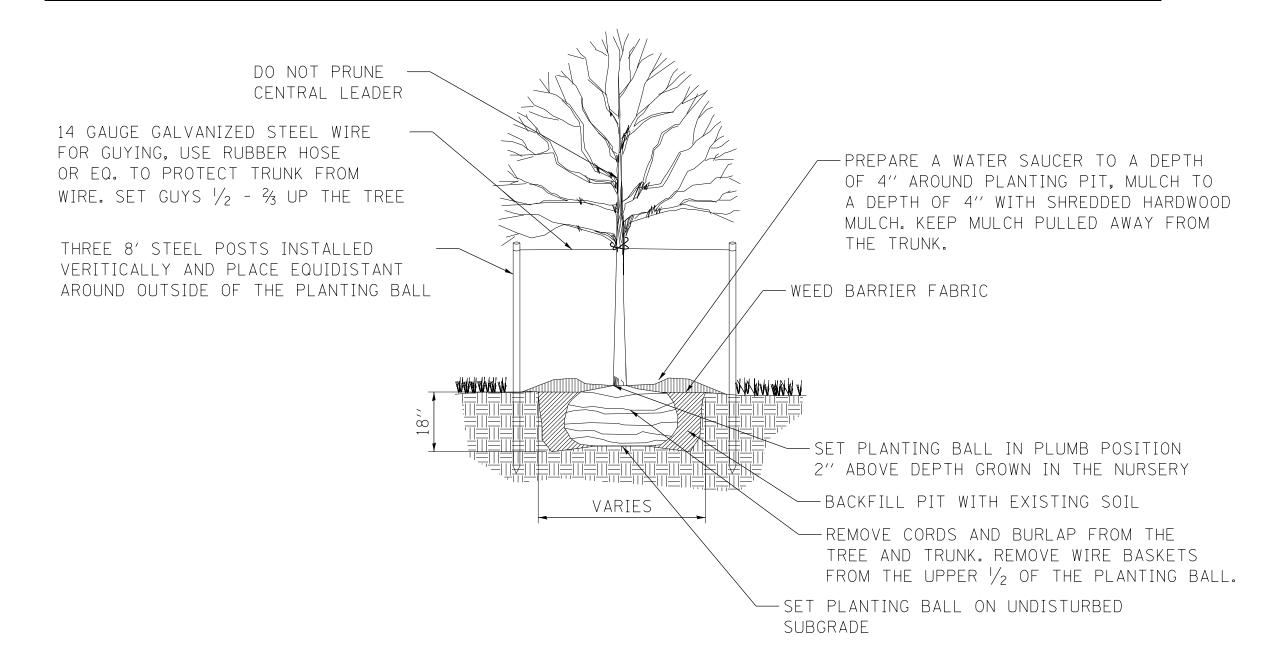

TREE PLANTING DETAIL N.T.S.

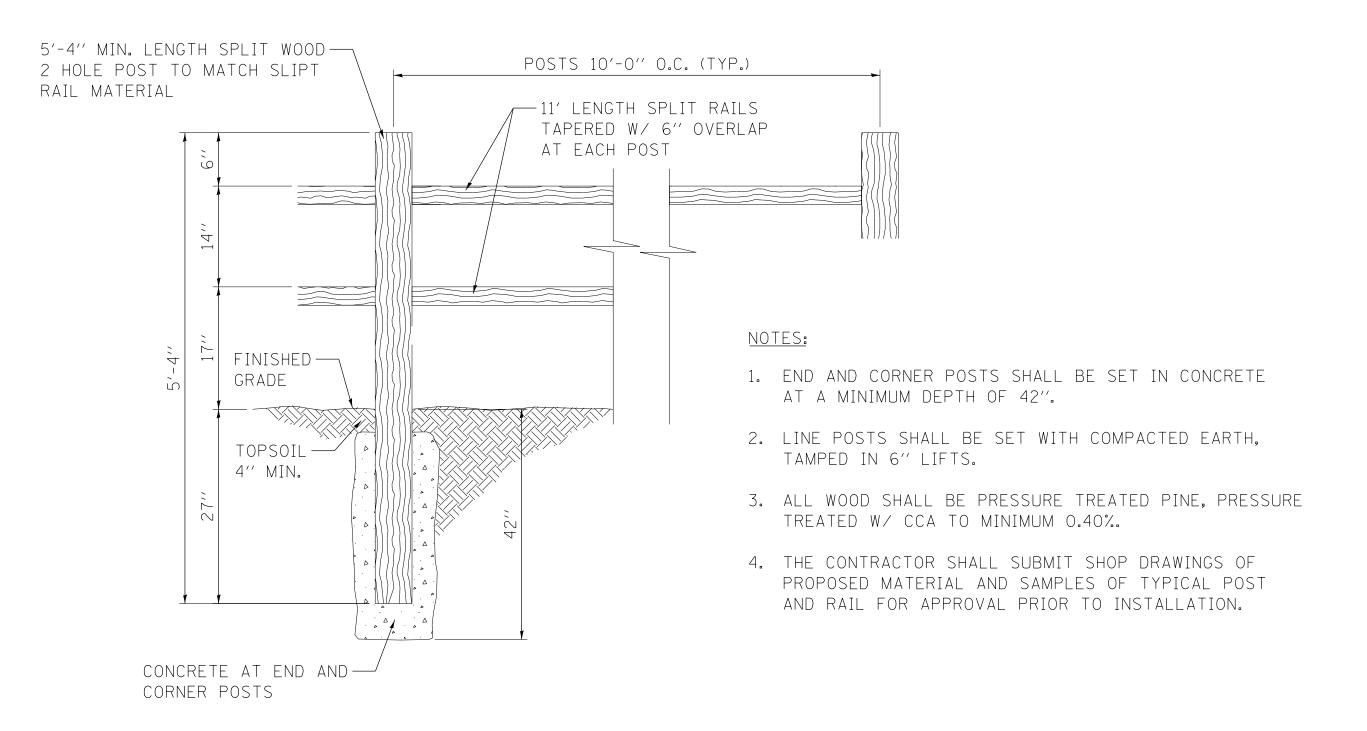

RUSTIC WOOD RAIL AND POST FENCE (2-RAIL)

	USER NAME = nparris	DESIGNED -	REVISED -
LTD.		DRAWN -	REVISED -
	PLOT SCALE = 1:20	CHECKED -	REVISED -
	PLOT DATE = 7/9/2013	DATE -	REVISED -

DETAILS		F.A.U. RTE.	SECTION	COUNTY	TOTAL SHEETS	SHEET NO.	
			1542	04-00329-00-BR	KANE	86	65
					CONTRACT	Γ NO.	
SCALE: N.T.S.	SHEET NO. 4 OF 4 SHEETS STA.	TO STA.		ILLINOIS FED. AID PROJECT			

WILLS BURKE KELSEY ASSOCIATES LT WBK 116 West Main Street, Suite 201 St. Charles, Illinois 60174

